2436 74TH AVE SE



NOTE: 3D RENDERINGS ARE FOR ILLUSTRATIVE PURPOSES ONLY. NOT TO BE USED FOR CONSTRUCTION.

PERSPECTIVE 1

MAX MAXIMUM

MED MEDIUM MIN MINIMUM

MECH MECHANICAL

OC ON CENTER

PERF PERFORATED

MISC MISCELLANEOUS

NOT IN CONTRACT

NOT TO SCALE NUMBER

ABI	BREVIATIONS				5
	ABOVE FINISH FLOOR			PICTURE	
	AIR CONDITIONING			PLASTIC LAMINATE	
	AIR HANDLING UNIT		SF	POUNDS PER SQUARE FOOT	
	ALTERNATE		SI	POUNDS PER SQUARE INCH	(1
	ALUMINUM ANODIZED		L NA	PROPERTY LINE PROTECTED NATURAL AREA	
	BASEMENT		TY		
BLK			ĖF	REFRIGERATOR	
BS				REQUIRED	
BLDG	BUILDING		EV	REVISION	
	CABINET	R		RISER	
	CATCH BASIN	R	M	ROOM	
	CEILING CLEAR		0	ROUGH OPENING	
	CLOSET		G IM	SAFETY GLASS SIMILAR	
_	CONCRETE		H	SINGLE HUNG	
	CONCRETE MASONRY UNIT		OG		
	CONTINUOUS			SPECIFICATION	
	CONTROL JOINT		F	SQUARE FOOT	
	CARPET		S	STAINLESS STEEL	Т
	CASEMENT		TD	STANDARD	٠.
CF			TL	STEEL STORAGE	
DIA	DIAMETER DIAMETER BREAST HEIGHT		D D	STORAGE STORM DRAIN	
DIM			UP		
DW	DISHWASHER		V.	TELEVISION	
DH	DOUBLE HUNG			TEMPORARY	
DN	DOWN		Ρ	TOILET PAPER DISPENSER	
DS	DOWNSPOUT		&G	TONGUE & GROOVE	
D	DRYER		0	TOP OF	
EA ELEC	EACH ELECTRICAL	TI	OW	TOP OF WALL TOWEL BAR	
EP			Ь	TREAD	
	ELEVATOR	Ti	PΖ	TREE PROTECTION ZONE	
EQ		T	ΥP	TYPICAL	
	EXTERIOR		NO	UNLESS NOTED OTHERWISE	
	EXISTING		В	VAPOR BARRIER	
	FINISH FLOOR ELEVATION			VENT TO OUTSIDE	<
FRD FRW	FIRE RATE DOOR FIRE RATE WINDOW		IF ERT	VERIFY IN FIELD VERTICAL	
FXD	FIXED		G	VERTICAL VERTICAL GRAIN	
FIXT	FIXTURE		/C	WATER CLOSET	
FAR	FLOOR AREA RATIO		/H	WATER HEATER	
FTG	FOOTING	W	/RB	WATER RESISTANT BARRIER	
FAU	FORCED AIR UNIT	W		WASHER	
FDN	FOUNDATION		/HF	WHOLE HOUSE FAN	
	FURNACE		/IN	WINDOW	
GFA	GROSS FLOOR AREA HARDWOOD		I/ I/O	WITH WITHOUT	
HDR			/P	WATER PROOFING	
	HEATING, VENTILATION & A/C	Y		YARD	
HT	HEIGHT				
HORZ					
HR	HOUR				
INCL	INCLUDE (ED)(ING)				
INT	INTERIOR				
LED LOD	LIGHT EMITTING DIODE LIMIT OF DISTURBANCE				
	LINEAR FEET				
	MANUFACTURER				
	NA A VINALINA				

SYMBOL LEGEND

STWIDGE	. LEGEND		
<u> </u>			EXISTING WALL
1	GRID LINES		EXISTING WALL TO DEMO
XX			2X WALLS
\boxtimes	PROJECT BASE POINT		
•	REFERENCE ELEVATION POINT		FOUNDATION WALL
\bigoplus	PROPERTY CORNER		CONCRETE SURFACE
PL	PROPERTY LINE	(a) ()	CAST IN PLACE CONCRETE
Ę	CENTER LINE		
T.O.W. 119.12'	TOP OF WALL ELEVATION	\boxtimes \otimes	STRUCTURAL POST - SIZE AND TYPE PER STRUCTURAL PLAN
N 90 00' 00" E	PROPERTY LINE TAG	 _G	GAS OUTLET
Distance	SECTIONS FOUND	GAS	GAS METER
A101	ON SHEET A101	— ₩	HOSE BIB
1 A101	DETAIL SECTION FOUND ON SHEET A101	□ DS	DOWNSPOUT
1		METER	ELECTRICAL METER
4 A1.0 2	INTERIOR ELEVATION FOUND ON SHEET A1.0	EP	ELECTRICAL PANEL
3			UNDISTURBED EARTH
E)//T			COMPACTED FILL
EXIT	EXIT DIRECTION		GRAVEL
(s)	SMOKE DETECTOR		RIGID OR SPRAY INSULATION
			BIBS BLOWN-IN INSULATION
(s/c)	SMOKE & CARBON MONOXIDE DETECTOR		STONE
$\left\langle 1\right\rangle _{SG}$	DOOR TAG NUMBER		BATT INSULATION
10'-0"x12'-0"	DOOR SIZE	A	EXHAUST FAN
⟨Â⟩	WINDOWS TAG NUMBER	VTOS	VENT TO OUTSIDE
<u></u>	DRAWING REVISION		WATER METER STEP DOWN /
1 i	WALL TAG ASSEMBLY		ELEVATION CHANGE

WHOLE HOUSE FAN

KEY NOTES

ENERGY CODE COMPLIANCE

CONDITIONED FLOOR AREA

1ST FLOOR: 2ND FLOOR:	994.0 SF 1561.5 SF 2007.8 SF	
TOTAL:	4563.3 SF < 5000 SF "MEDIUM DWE	LLING U
GENERAL PRESC	CRIPTIVE METHOD: SEE SHEETS A0.	.3 & A5.0
SYSTEM TYPE 2 -HEAT PUM	ATION CREDITS PER TABLE R406.2 P MEETING FEDERAL STANDARDS 3.2(1)C OR C403.3.2(2)	1.0 CRE
OPTION 1.3 BUILD	FENESTRATION U=0.28 int	0.5
UNDER EN OPTION 2.3 AIR L -AIR LEAKA HOUR	EAKAGE CONTROL GE TO MAX 1.5 AIR CHANGES PER	1.5
WITH HRV V RECOVERY OPTION 3.6 HIGH -DUCTLESS RESISTANC	OUSE VENTILATION REQ'S MET W/ MINIMUM SENSIBLE HEAT 'EFFICIENCY OF 0.75 EFF. HVAC EQUIPMENT S SPLIT SYSTEM W/ NO ELECTRIC CE HEATING IN PRIMARY LIVING.	2.0
OPTION 5.3 EFFIC	CIENT WATER HEATING	1.0

-ENERGY STAR RATED GAS WATER HEATER WITH MIN. UEF OF 0.91. TOTAL CREDITS REQUIRED 6.0 **TOTAL CREDITS PROPOSED** 6.0

OTHER PERMITS

ELECTRICAL, MECHANICAL, AND PLUMBING PERMITS ARE TO BE OBTAINED SEPARATELY.

SEPARATE FIRE SPRINKLER PERMIT TO BE OBTAINED.

PROJECT DATA

ARCHITECT:

NEW CONSTRUCTION OF SINGLE FAMILY **DESCRIPTION:** RESIDENCE WITH ATTACHED GARAGE OWNER: BV HOMES L.L.C. **BLAKE LANZ** 317 4TH ST KIRKLAND, WA 98033 P: 206.715.6200 E: BLAKE@LNLBUILDS.COM

> SCHUYLER TUTT MEDICI ARCHITECTS 11711 SE 8TH ST, SUITE 100 BELLEVUE, WA 98005 P: 425.453.9298

E: SCHUYLER@MEDICIARCHITECTS.COM

STRUCTURAL MULHERN & KULP **ENGINEER:** RICHARD ZABEL 7220 TRADE ST, SUITE 295 SAN DIEGO, CA 92121

P: 619.650.0010 E: RZABEL@MULHERNKULP.COM

CIVIL ENGINEER: MAHER JOUDI D.R. STRONG 620 7TH AVE KIRKLAND, WA 98033

> P: 425.827.3063 E: MAHER.JOUDI@DRSTRONG.COM

ARBORIST: DAVEY RESOURCE GROUP, INC.

TODD BEALS 18809 10TH AVE NE SHORELINE, WA 98155 P: 253.656.1650

E: TODD.BEALS@DAVEY.COM

SURVEYOR: **TERRANE EDWIN GREEN** 10801 MAIN STREET, SUITE 102

BELLEVUE, WA 98004

P:425.458.4488 E: EDWING@TERRANE.NET

GEOTECH: EARTH SOLUTIONS NW, LLC

SCOTT RIEGEL 15365 NE 9TH ST, SUITE 100 REDMOND, WA 98052 P: 425.449.4704

E: SCOTTR@ESNW.COM

CODE INFORMATION

ALL MATERIALS, WORKMANSHIP, DESIGN AND CONSTRUCTION SHALL CONFORM TO THE DRAWINGS, SPECIFICATIONS, AND THE FOLLOWING APPLICABLE CODES USED IN THIS DESIGN FOR CITY OF MERCER ISLAND.

2018 WASHINGTON STATE BUILDING CODE (IBC) 2018 WASHINGTON STATE EXISTING BUILDING CODE (IEBC) 2018 WASHINGTON STATE RESIDENTIAL CODE (IRC) 2018 WASHINGTON STATE MECHANICAL CODE (IMC) 2018 INTERNATIONAL FUEL GAS CODE (NATURAL GAS) (IFGC) 2018 INTERNATIONAL SWIMMING POOL AND SPA CODE (ISPSC) 2018 UNIFORM PLUMBING CODE (UPC) 2018 WASHINGTON STATE ENERGY CODE - COMMERCIAL PROVISIONS (WSEC - COMMERCIAL) 2018 WASHINGTON STATE ENERGY CODE - RESIDENTIAL PROVISIONS (WSEC - RESIDENTIAL)

2018 WASHINGTON STATE FIRE CODE (IFC) 2017 WASHINGTON CITIES ELECTRICAL CODE (2017 WCEC WITH 2020 NEC UPDATES)

DEFERRED SUBMITTAL

DESIGN DOCUMENTS FOR THE FOLLOWING ITEMS SHALL BE DEFERRED, PER IBC 107.3.4.1. THESE ITEMS SHALL NOT BE INSTALLED UNTIL THE DEFERRED SUBMITTALS HAVE BEEN APPROVED BY THE BUILDING OFFICIAL.

*HANDRAILS *GUARDRAILS

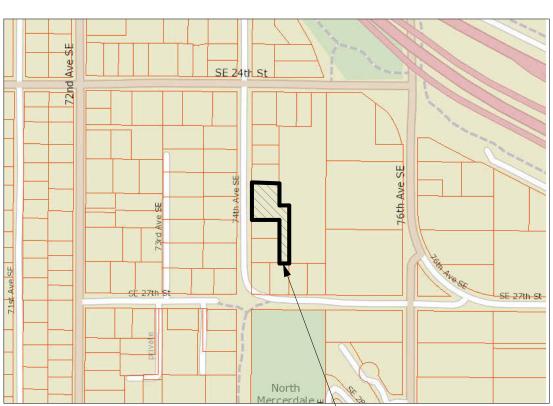
THE DEFERRED SUBMITTAL DESIGN DOCUMENTS SHALL BE REVIEWED AND APPROVED BY THE ENGINEER PRIOR TO SUBMITTING TO THE BUILDING OFFICIAL

FIRE SPRINKLERS

AUTOMATIC SPRINKLERS PROVIDED: <u>13R SPRINKLER SYSTEM</u> TO BE PROVIDED

NOXIOUS WEEDS

PER MICC 19.02.020(F)(3)(d), PROPOSED DEVELOPMENTS SHALL REMOVE JAPANESE KNOTWEED (POLYGONUM CUSPIDATUM) AND REGULATED CLASS A, REGULATED CLASS B, AND REGULATED CLASS C WEEDS IDENTIFIED ON THE KING COUNTY NOXIOUS WEED LIST, AS AMENDED, FROM REQURIED LANDSCAPING AREAS ESTABLISHED PURSUANT TO MICC 19.02.020(F)(3)(a). NEW LANDSCAPING SHALL NOT INCORPORATE ANY WEEDS IDENTIFIED ON THE KING COUNTY NOXIOUS WEED LIST. REMOVAL SHALL NOT BE REQUIRED IF THE REMOVAL WILL RESULT IN INCREASED SLOP INSTABILITY OR RISK OF LANDSLIDE OR EROSION.



MILLR SUB14-01

12639#g1s 0417

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SURVEY

TITLE SHEET & SYMBOLS

LOT COVERAGE DIAGRAM (IF NECESSARY)

14887#g1s 0405

1 OF 2

2 OF 2

A0.1

A0.2

A0.3

A0.4

A1.0

A2.0

A2.1

A2.2

A3.0

A4.1

A4.2

A4.3

A4.4

A5.0

A5.1

A6.0

A6.1

A6.2

A6.4

S-0.0

S-1.1

S-2.0 S-3.0

SD-1

C3



- PROJECT LOCATION

103018# 2.36 AC

PROJECT LOCATION

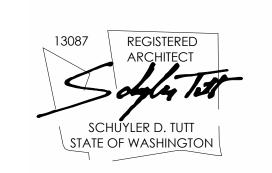
QUARTER SECTION MAP

VICINITY MAP



11711 SE 8TH STREET 200 W. RIVER ST. SUITE 301 KETCHUM, ID 83340 BELLEVUE, WA 98005 TEL: (425) 453-9298 TEL: (208) 726-0194

REGISTRATION:



INTA	AKE DATE:	9/28/2023
REV	ISIONS:	DATE:
1	CORRECTION LETTER	5/28/24

PROJECT / CLIENT:

2436 74TH AVE SE - SFR

LNL BUILDS

PROJECT ADDRESS: 2436 74TH AVE SE MERCER ISLAND, 98040

DRAWING NAME:

TITLE SHEET

DRAWN BY: DRA CHECKED BY: JML

PHASE:

CONSTRUCTION DRAWINGS


This drawing is the exclusive property of MEDICI ARCHITECTS, and can be reproduced only with the permission of the Architect Variations and modifications to work shown on this drawing shall not be carried out without written permission from the Architect.

APPROVED FOR CONSTRUCTION:

PROJECT No.: A22 087 DATE: 5/28/2024

BOUNDARY AND TOPOGRAPHIC SURVEY

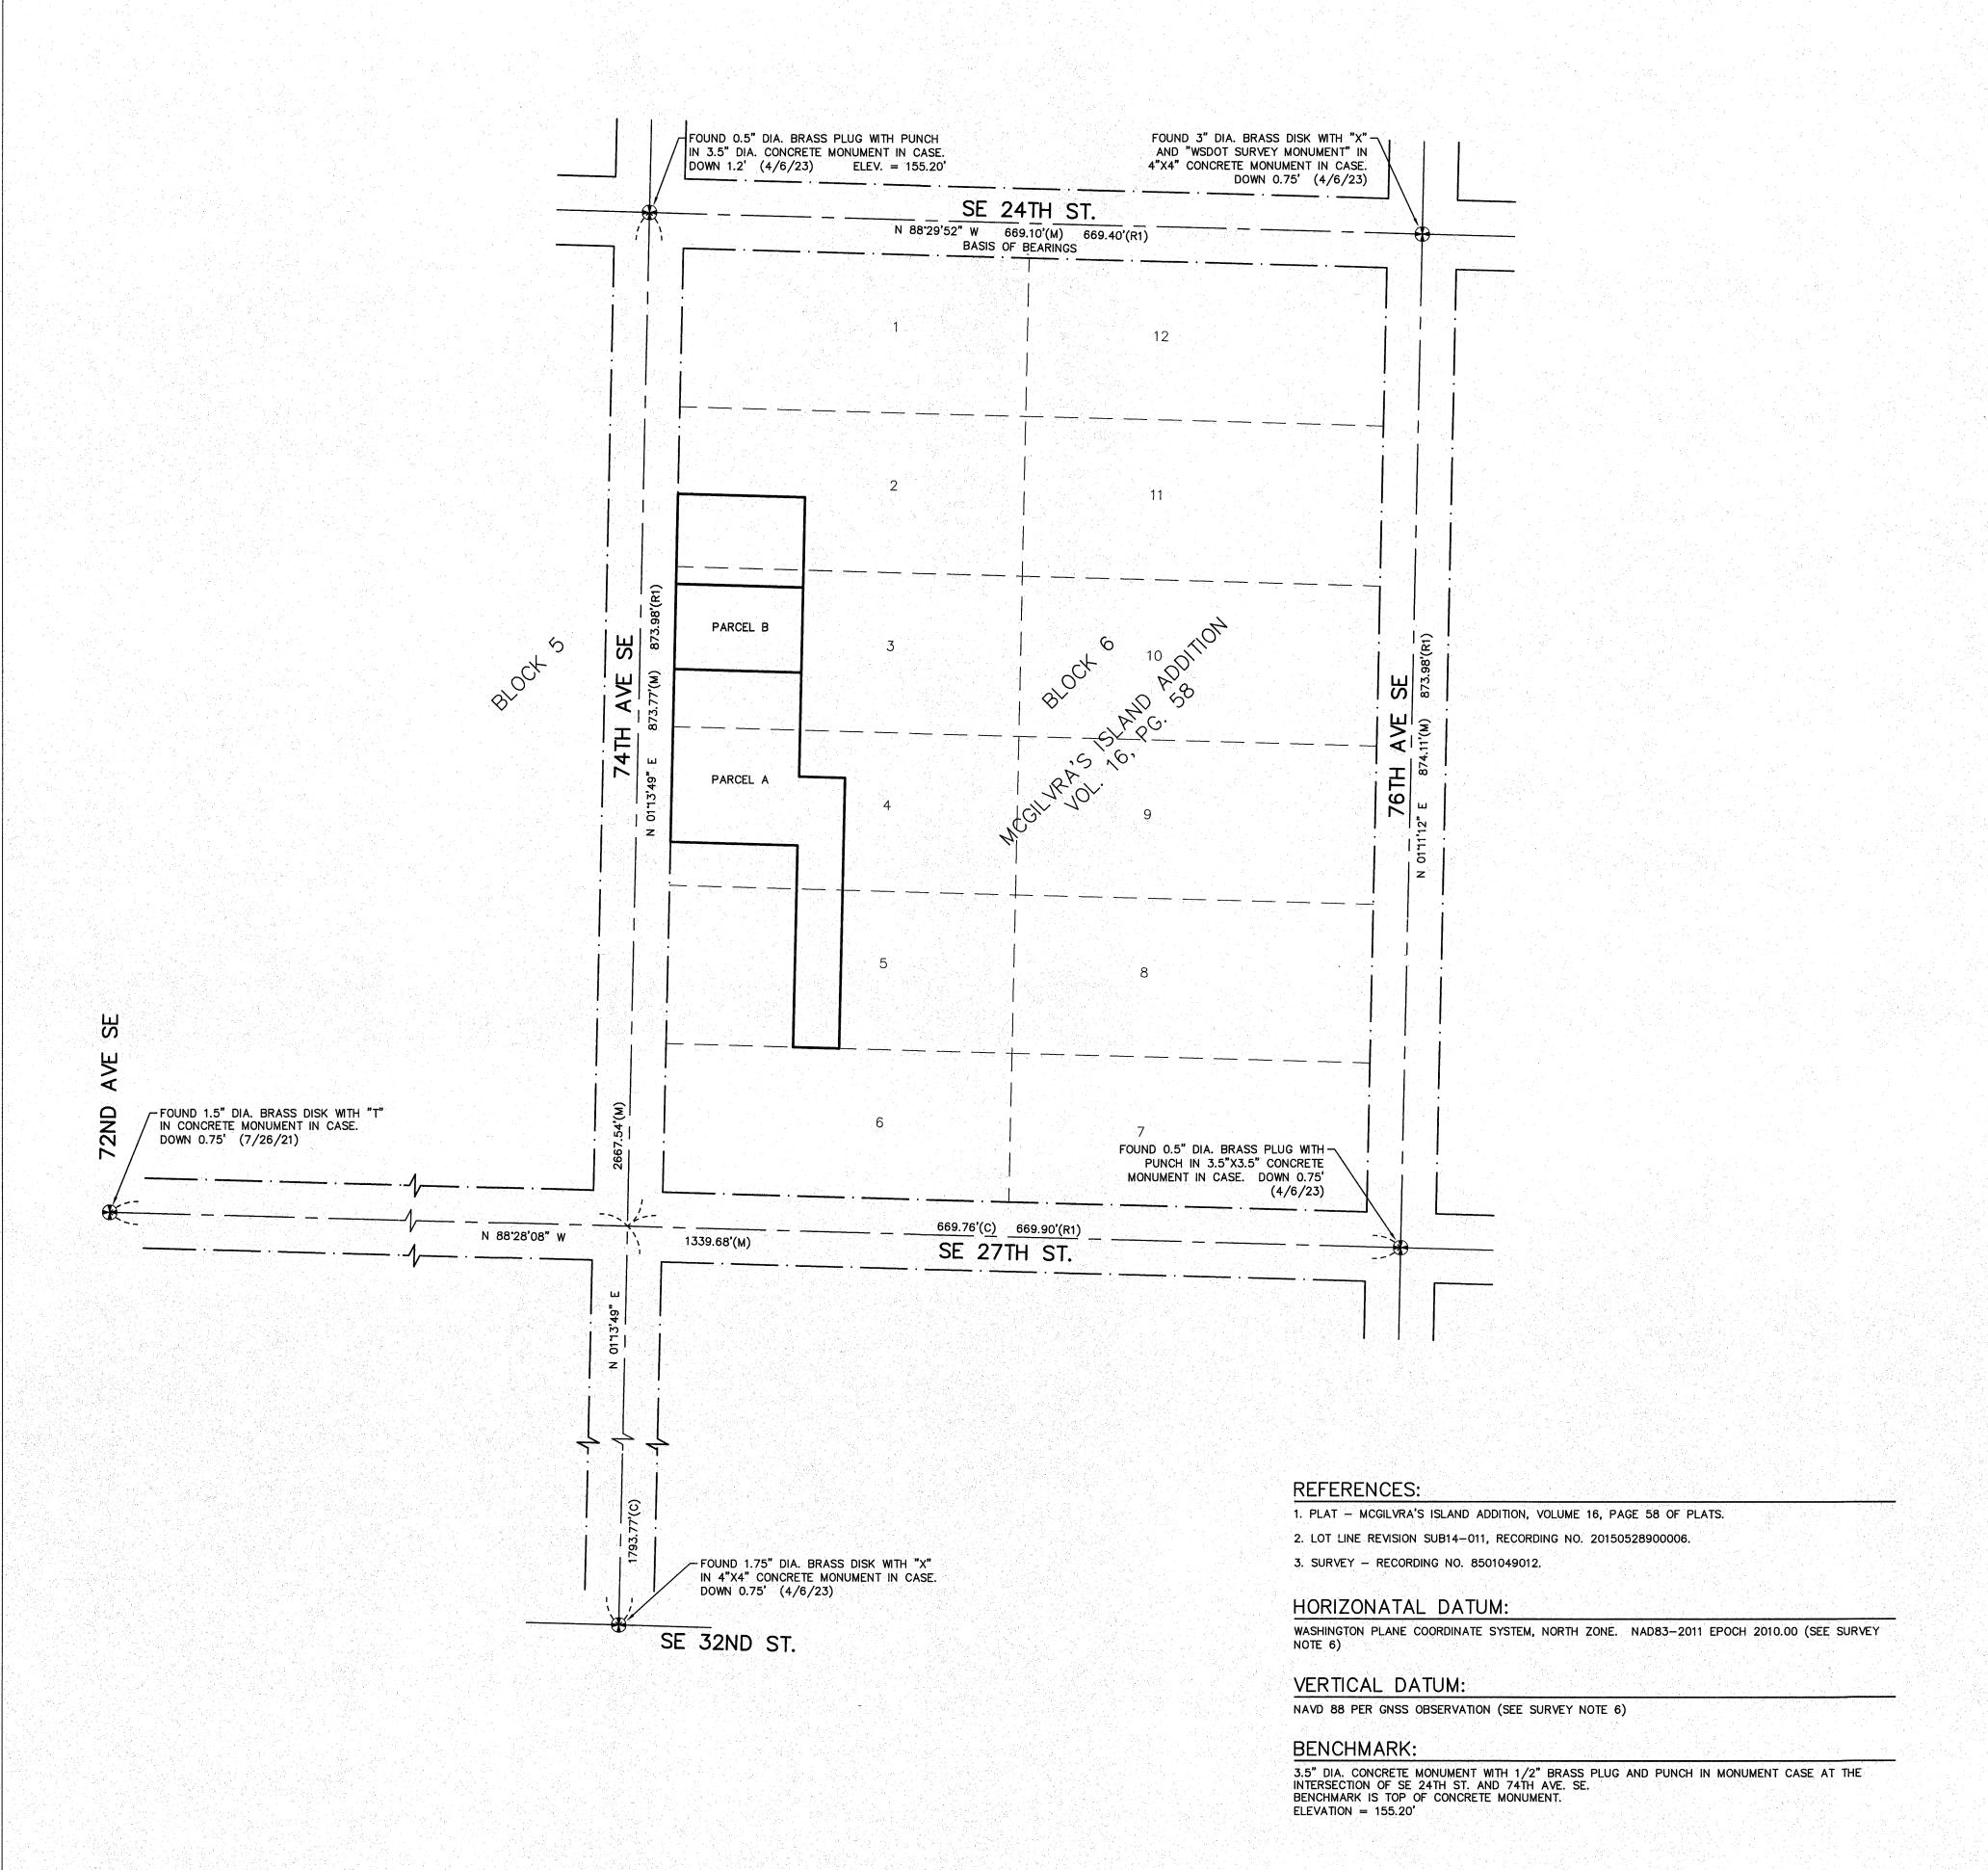A PORTION OF THE NORTHEAST QUARTER OF THE NORTHWEST QUARTER, SECTION 12, TOWNSHIP 24 NORTH, RANGE 04 EAST, W.M., CITY OF MERCER ISLAND, KING COUNTY, WASHINGTON



LEGAL DESCRIPTION:

PARCEL

PARCEL B OF CITY OF MERCER ISLAND LOT LINE REVISION NO. SUB14-011, RECORDED UNDER RECORDING NUMBER 20150528900006, IN KING COUNTY WASHINGTON;

SITUATE IN THE COUNTY OF KING, STATE OF WASHINGTON.

PARCEL B:

THE SOUTH 72.72 FEET OF THE NORTH 87.67 FEET OF THE WEST 110 FEET OF LOT 3, BLOCK 6, MCGILVRA'S ISLAND ADDITION, ACCORDING TO THE PLAT THEREOF RECORDED IN VOLUME 16 OF PLATS, PAGE(S) 56, IN KING COUNTY, WASHINGTON;

SITUATE IN THE COUNTY OF KING, STATE OF WASHINGTON.

TITLE RESTRICTIONS

1. EASEMENT GRANTED TO MERCER ISLAND SEWER DISTRICT FOR A SEWER PIPELINE, RECORDING NO. 4655731. AFFECTS PORTION OF PARCEL A AND OTHER PROPERTY. SHOWN HEREON.

2. 4-FOOT WIDE EASEMENT FOR SIDE SEWER - RECORDING NO. 4995706. LOCATION SHOWN IS APPROXIMATE. EASEMENT IS OVER PIPE AS CONSTRUCTED. AFFECTS PORTION OF PARCEL B AND OTHER PROPERTY. SHOWN HEREON.

3. 7-FOOT WIDE EASEMENT FOR UTILITIES INCLUDING POWER, LIGHT, GAS, WATER SEWER AND TELEPHONE, RECORDING NO. 5601958. AFFECTS NORTHERLY PORTION OF PARCEL A. SHOWN HEREON.

- 4. ITEM DELETED FROM TITLE REPORT.
- 5. ITEM DELETED FROM TITLE REPORT.
- 6. ITEM DELETED FROM TITLE REPORT.
- 7. HOLD HARMLESS AGREEMENT, RECORDING NO. 20160120000200. NOT SURVEY RELATED.

8. COVENANTS, CONDITIONS AND RESTRICTIONS, IF ANY, AS PERMITTED BY APPLICABLE LAW, AS SET FORTH ON LOT-LINE REVISION NO. SUB14-011, RECORDING NO. 20150528900006.

9. TIEBACK AND SHORING EASEMENT, RECORDING NO. 20170530001254. AFFECTS EASTERLY PORTION OF PARCELS A AND B. NO DEFINITE LOCATION DESCRIBED. MAY HAVE SELF TERMINATED.

10. EASEMENT FOR SEWER LINE, RECORDING NO. 20170530001263. SHOWN HEREON.

11. HOLD HARMLESS AGREEMENT, RECORDING NO. 20170710000863. NOT SURVEY RELATED.

12. RESTAURANT AGREEMENT, RECORDING NO. 20171113001170. NOT SURVEY RELATED.

13-16. RELATED TO TAXES AND ASSESSMENTS. NOT SURVEY RELATED.

17. NOTES THE ENCROACHMENT OF A "TRASH CORRAL" ON THE NORTH PORTION OF PARCEL B.

SURVEYOR'S NOTES

1. ALL TITLE INFORMATION SHOWN ON THIS MAP HAS BEEN EXTRACTED FROM CHICAGO TITLE COMPANY OF WASHINGTON COMMITMENT NO. 0187036—16, UPDATE 4THD COMMITMENT DATED OCTOBER 3, 2022. IN PREPARING THIS MAP, D.R. STRONG CONSULTING ENGINEERS, LLC HAS CONDUCTED NO INDEPENDENT TITLE SEARCH NOR IS D.R. STRONG CONSULTING ENGINEERS, LLC AWARE OF ANY TITLE ISSUES AFFECTING THE SURVEYED PROPERTY OTHER THAN THOSE SHOWN ON THE MAP AND DISCLOSED BY REFERENCED CHICAGO TITLE COMPANY OF WASHINGTON COMMITMENT. D.R. STRONG CONSULTING ENGINEERS, LLC HAS RELIED WHOLLY ON SAID CHICAGO TITLE COMPANY OF WASHINGTON REPRESENTATIONS OF THE TITLE'S CONDITION TO PREPARE THIS SURVEY AND THEREFORE D.R. STRONG CONSULTING ENGINEERS, LLC QUALIFIES THE MAP'S ACCURACY AND COMPLETENESS TO THAT EXTENT.

2. THIS SURVEY REPRESENTS VISIBLE PHYSICAL IMPROVEMENT CONDITIONS EXISTING ON APRIL 13, 2023.
ALL SURVEY CONTROL INDICATED AS "FOUND" WAS RECOVERED FOR THIS PROJECT ON APRIL 6, 2023
LINESS NOTED OTHERWISE

3. PROPERTY AREA: PARCEL A = $7,999\pm$ SQUARE FEET (0.1836 \pm ACRES). PARCEL B = $25,800\pm$ SQUARE FEET (0.5923 \pm ACRES).

4. ALL DISTANCES ARE IN U.S. SURVEY FEET.

5. THIS IS A COMBINED FIELD TRAVERSE AND GLOBAL NAVIGATION SATELLITE SYSTEMS SURVEY. A TRIMBLE S7 ONE SECOND COMBINED ELECTRONIC TOTAL STATION AND A TRIMBLE R12I GLOBAL NAVIGATION SATELLITE SYSTEMS (GNSS) RECEIVER WERE USED TO MEASURE THE ANGULAR AND DISTANCE RELATIONSHIPS BETWEEN THE CONTROLLING MONUMENTATION AS SHOWN. CLOSURE RATIOS OF THE TRAVERSE MET OR EXCEEDED THOSE SPECIFIED IN WAC 332-130-090. ALL MEASURING INSTRUMENTS AND EQUIPMENT ARE MAINTAINED IN ADJUSTMENT ACCORDING TO MANUFACTURER'S SPECIFICATIONS.

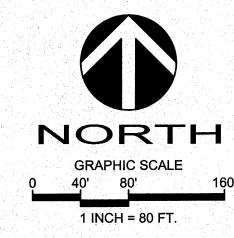
6. RTK GNSS OBSERVATIONS WERE MADE ON 04/06/2023 UTILIZING THE WASHINGTON STATE REFERENCE NETWORK (WSRN). THE COMBINED GRID TO GROUND SCALE FACTOR USED IS 0.999980520.

7. UTILITIES OTHER THAN THOSE SHOWN MAY EXIST ON THIS SITE. ONLY THOSE UTILITIES WITH EVIDENCE OF THEIR INSTALLATION VISIBLE AT GROUND SURFACE ARE SHOWN HEREON. UNDERGROUND UTILITY LOCATIONS SHOWN ARE APPROXIMATE ONLY. UNDERGROUND CONNECTIONS ARE SHOWN AS STRAIGHT LINES BETWEEN SURFACE UTILITY LOCATIONS BUT MAY CONTAIN BENDS OR CURVES NOT SHOWN. SOME UNDERGROUND LOCATIONS SHOWN HEREON MAY HAVE BEEN TAKEN FROM PUBLIC RECORDS. D.R. STRONG CONSULTING ENGINEERS INC. ASSUMES NO LIABILITY FOR THE ACCURACY OF

8. THE BOUNDARY SHOWN HEREON IS BASED ON A FIELD SURVEY.

9. CONTOURS ARE DERIVED FROM DIRECT FIELD OBSERVATION. CONTOUR ACCURACY IS WITHIN ONE—HALF CONTOUR INTERVAL PER NATIONAL MAPPING STANDARDS.

10. THIS SURVEY WAS PERFORMED IN SUPPORT OF ENGINEERING DESIGN.



BASIS OF BEARINGS:

N 88'29'52" W BETWEEN THE MONUMENTS
FOUND IN PLACE ALONG SE 24TH ST.

D.R. STRONG
CONSULTING ENGINEERS
ENGINEERS PLANNERS SURVEYORS
620 - 7th AVENUE KIRKLAND, WA 98033
0 425.827.3063 F 425.827.2423

531510-BUILDS,

PROJECT SURVEYOR: DJC

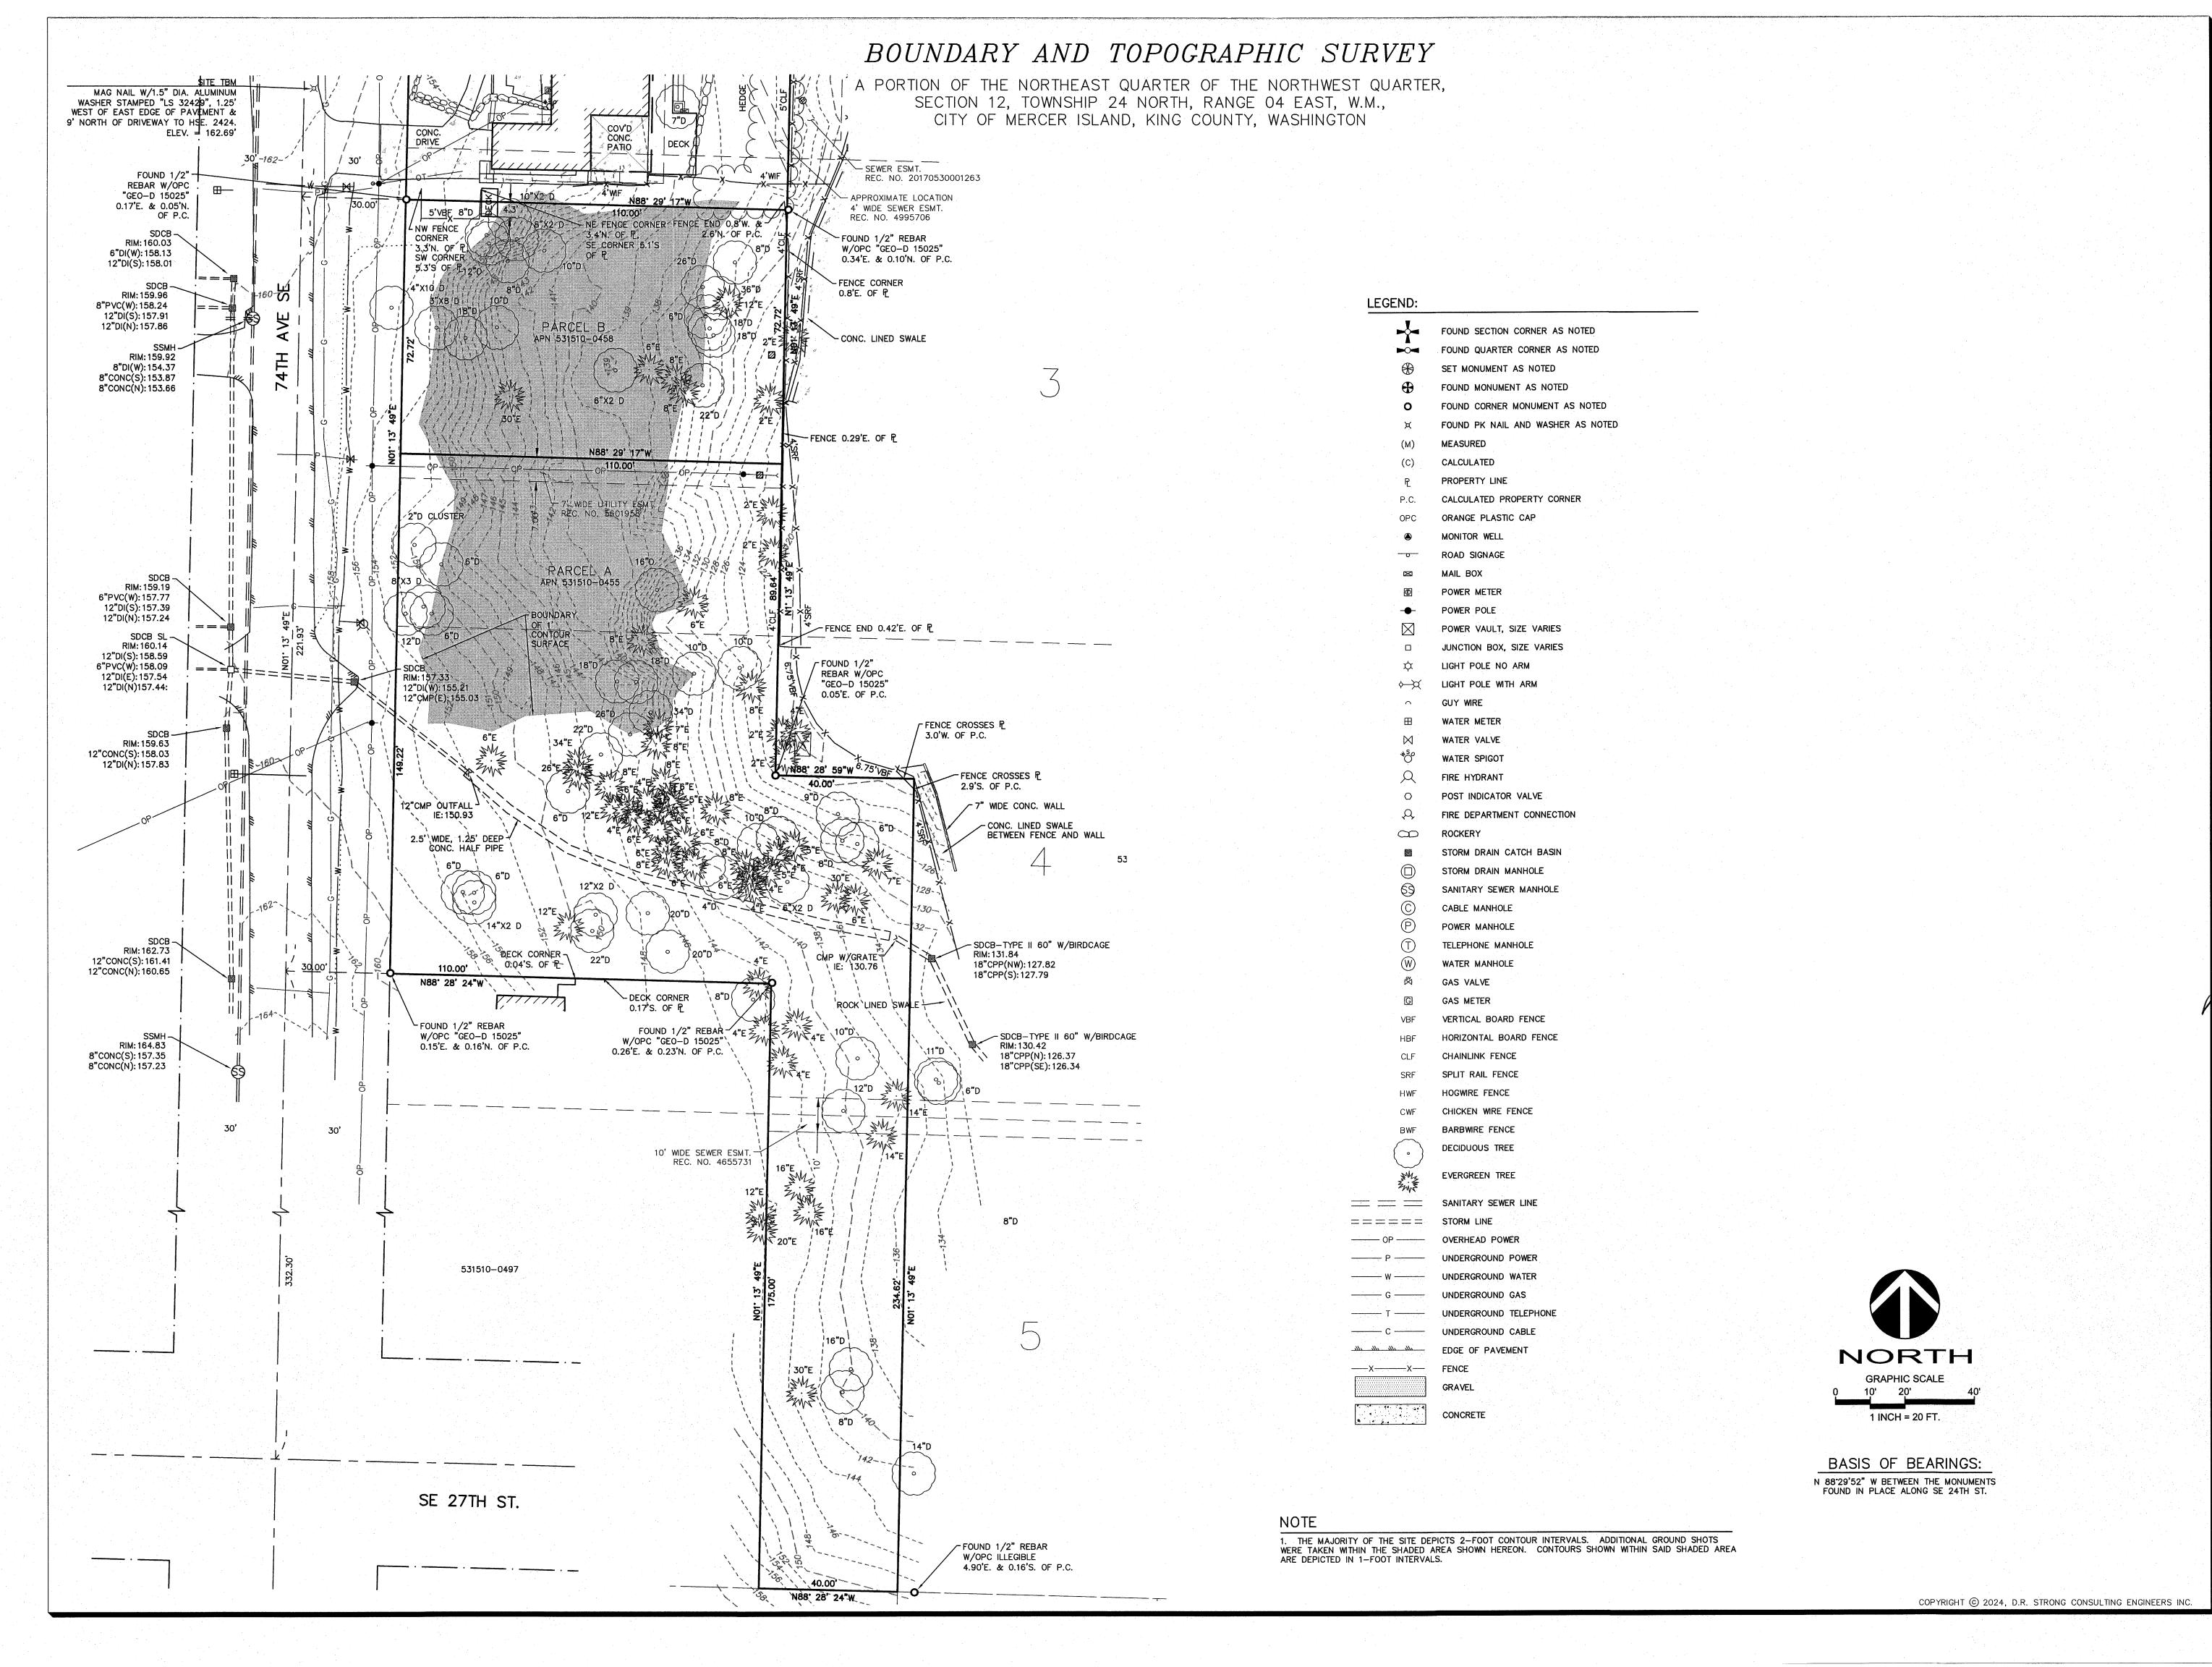
DRAFTED BY: DJC/DLC

FIELD BOOK: 199

DATE: 06-27-2023

PROJECT NO.: 23001

SHEET: 1 OF 2



DRS)

D.R. STRONG CONSULTING ENGINEERS ENGINEERS PLANNERS SURVEYORS 620 - 7th AVENUE KIRKLAND, WA 98033 O 425.827.3063 F 425.827.2423

X PARCELS:

2430 AND 2436 74TH AVE TAX PARCELS : 531510-0458 AND 531510-0

317 - 4TH STREET

AS J COO AS H. AS

> APR 2 DUC

: REVISION 5/24 ADD 1' CONTOURS - SHT 2

PROJECT SURVEYOR: DJC

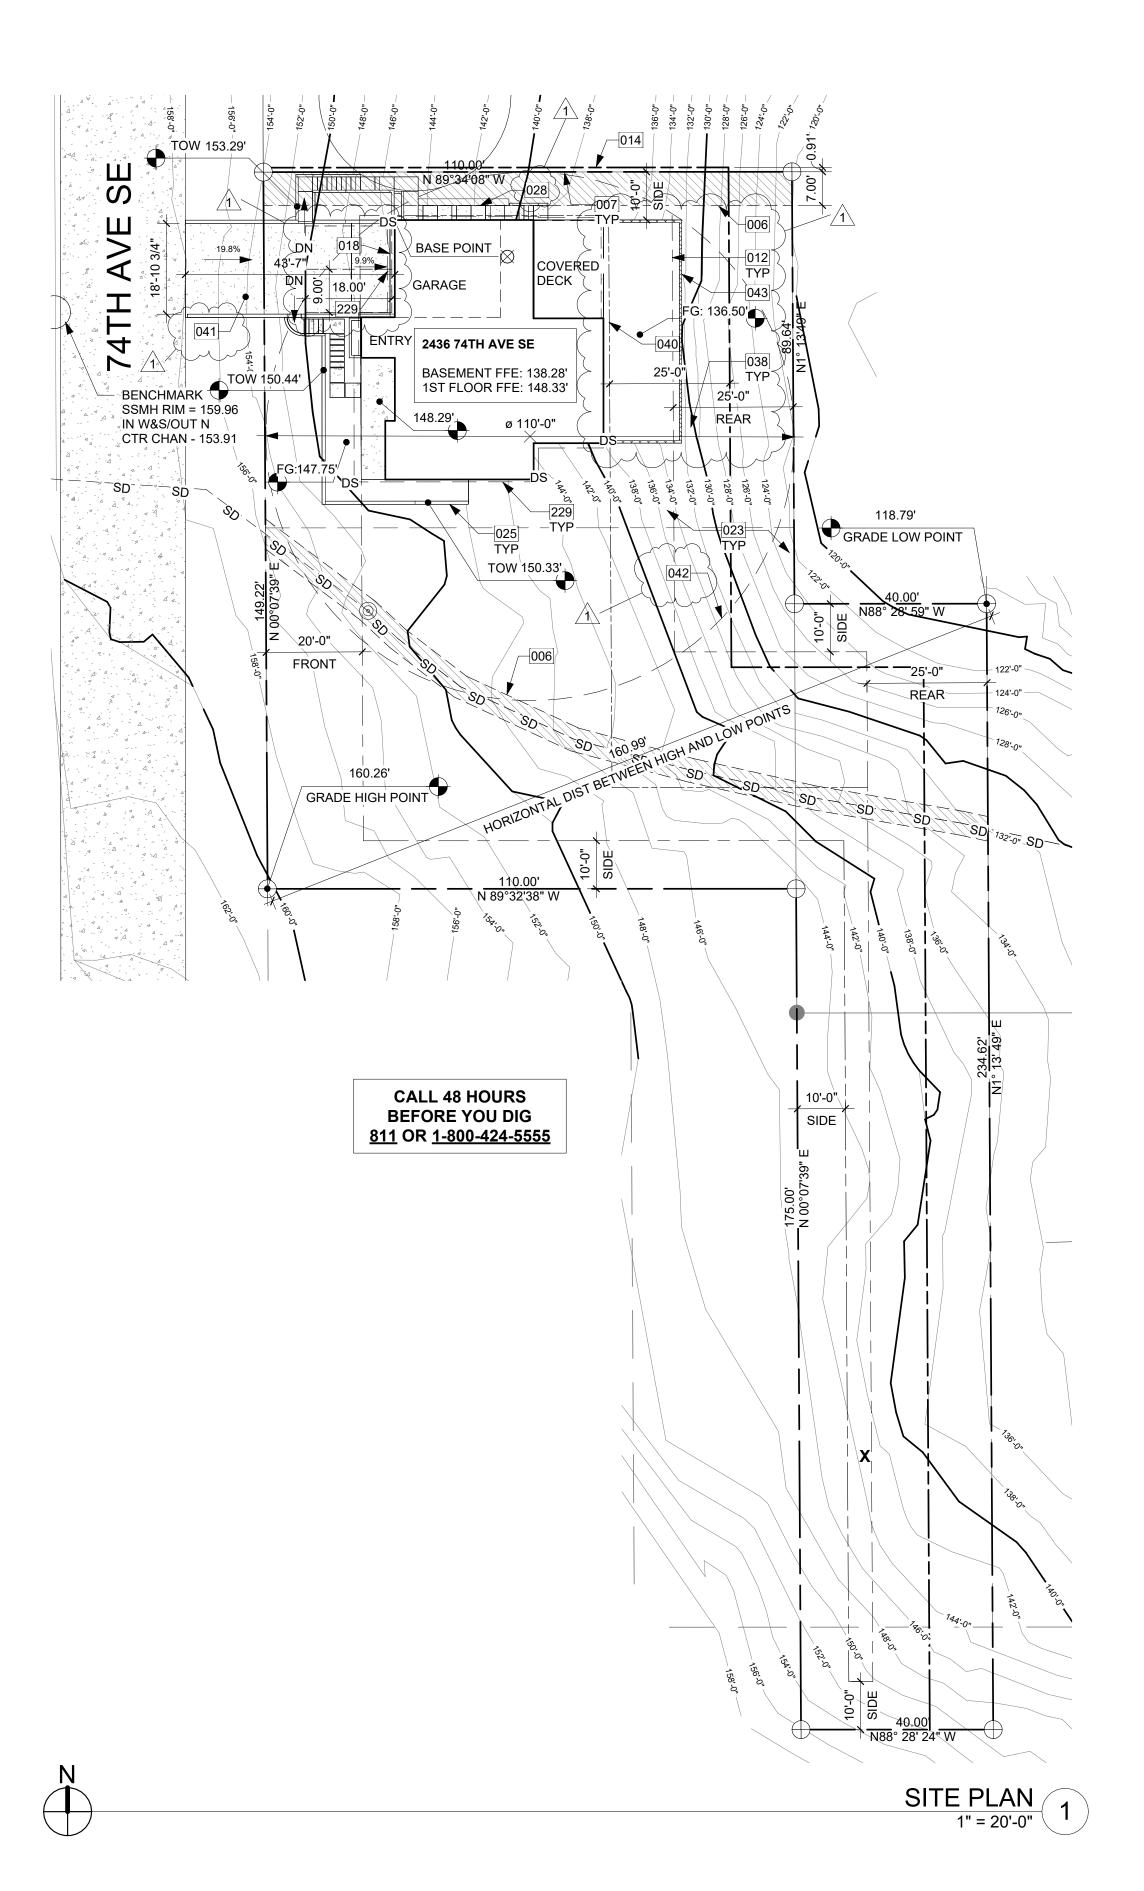
DRAFTED BY: DJC/DLC

FIELD BOOK: 199

DATE: 06-27-2023

PROJECT NO.: 23001

SHEET: 2 OF 2



	006	EXISTING EASEMENT LINE
	007	EXISTING PROPERTY LINE
	012	SETBACK LINE
	014	PROPOSED PROPERTY LINE IN BLA PERMIT, SEE PERMIT 2LLA_23001.
	018	TRENCH DRAIN: SEE DETAILS AND CIVIL.
	023	SITE DRAINAGE AWAY FROM HOME PER IRC SECTION 401.3. SEE CIVIL DRAWINGS FOR FOUNDATION DRAINAGE SPECIFICATIONS.
	025	RETAINING WALL PER STRUCTURAL. 36" TALL GUARDS CONFORMING TO SECTION R312 SHALL BE PROVIDED WHERE ADJACENT TO WALKING SURFACE AND RETAINED EARTH IS >30".
	028	HARDSCAPE STEPS DRAWN DIAGRAMATICALLY; TO FOLLOW SITE CONTOURS. PROVIDE HANDRAILINGS TO ANY PORTION OF EXTERNAL STAIRS THAT EXCEED 4 RISERS.
_	038	DRIPLINE OF TREES TO BE RETAINED ON SITE, TYP.
}	040	DASHED LINE OF NEW SETBACK LINE AFTER BLA ADJUSTMENT. SEE PERMIT 2LLA_23001.
\succ	041	DRIVEWAY SLOPE THAT EXCEEDS 15% SHALL BE CEMENT CONCRETE PAVEMENT WITH A BRUSHED SURFACE FOR TRACTION. DRIVEWAY SLOPE THAT

IS 15% OR LESS TO BE ASPHALT CONCRETE SURFACE, PER CIVIL.

ZONING REQUIREMENTS

229 LONG DASHED LINE OF ROOF ABOVE.

JURISDICTION: CITY OF MERCER ISLAND R-9.6 SINGLE FAMILY **ZONING:** PARCEL ASSESSOR'S #: 5315100455 25789 SF = 0.59 ACRE LOT SIZE:

LANDSCAPE BLOCK WALL TO NOT EXCEED 4'-0" IN HEIGHT

LOT REQUIREMENT MINIMUM 75'-0" DIAMETER.

LEGAL DESCRIPTION:

MC GILVRAS ISLAND ADD PCL B MERCER ISLAND LLR# SUB 14-011 REC#20150528900006 SD LLR BEING POR LOTS 1 THRU 5 SD BLK 6 PLat Block: 6

MAXIMUMS:

Plat Lot: 3-4-5

SETBACKS:

MAX. FAR: 40%

MAX. LOT COVERAGE: 35% (9026.15 SF)

MAX. HEIGHT: 30' ABOVE ABE

REQUIRED FRONT: MIN. 20' PROVIDED: 20' REQUIRED SIDE: MIN. 5'/5' PROVIDED: 10'/10' MIN. 25' PROVIDED: 25' REQUIRED REAR:

G.F.A. CALCULATION

25,789 SF LOT SIZE G.F.A. IN ZONE R-9.6 = 40% <u>10,315.6 SF</u>

BASEMENT FLOOR EXEMPT (SEE BASEMENT FLOOR AREA CALCULATION)

1ST FLOOR 1,561.46 SF 2ND FLOOR 2,007.81 SF ATTACHED GARAGE 459.46 SF

TOTAL: 4,497.34 SF PERCENT: 17.44%

LOT COVERAGE CALCULATION

LOT SIZE 25789 SF 2321.01 SF MAX HARDSCAPE COVERAGE (9%) MIN LANDSCAPE REQUIREMENT (70%) 18052.3 SF MAXIMUM PAVER COVERAGE (9%) 2321.01 SF 9026.15 SF **ALLOWABLE LOT COVERAGE (35%)**

IMPERVIOUS ACTUAL **SURFACES** AREA_ 2120.97 SF FOOTPRINT INCLUDING EAVES: DRIVEWAY: 520.61 SF COVERED DECK: 304.57 SF COVERED ENTRY PATIO: 194.17 SF PAVER WALKWAY AND STAIRS < 60" 192.94 SF PAVER ENTRY WALKWAY < 60" 75.75 SF 0.0 SF

TOTAL LOT COVERAGE: 3409.01 SF (5617.14 SF UNDER) REMAINING LANDSCAPE AREA: 22379.99 SF (4327.69 SF OVER)

65%

HARDSCAPE

SURFACES

192.94 SF PAVER WALKWAY AND STAIRS: PAVER ENTRY WALKWAY: 75.75 SF RETAINING WALLS*: 96.01 SF

TOTAL HARDSCAPE AREA: 364.7 SF 1.41% **TOTAL PAVER AREA:** 268.69 SF 1.04%

LOT SLOPE CALCULATION

HORIZONTAL DISTANCE BETWEEN HIGH AND LOW POINT ON SITE:

160.99' 160.26' HIGHEST GRADE POINT: <u>118.79'</u> **LOWEST GRADE POINT:**

GRADE DIFFERENCE: 160.26' - 118.79' = 41.47' AVERAGE GRADE SLOPE: 41.47' / 160.99' = **25.76%**

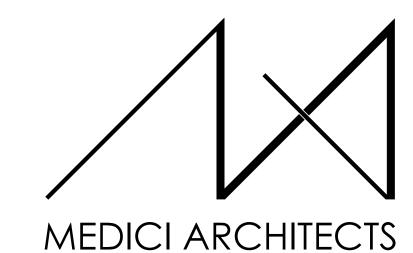
REQUIRED LANDSCAPING AREA BETWEEN 15% AND

LESS THAN 30%:

MAXIMUM LOT COVERAGE BETWEEN 15% AND LESS

SYMBOL LEGEND


SEE TITLE BLOCK SHEET A0.0 FOR COMPLETE SYMBOL INDEX.



11711 SE 8TH STREET SUITE 100

BELLEVUE, WA 98005 TEL: (425) 453-9298

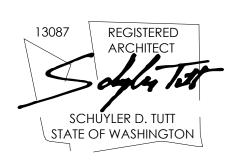REGISTRATION:



200 W. RIVER ST.

KETCHUM, ID 83340

TEL: (208) 726-0194

SUITE 301

9/28/2023 INTAKE DATE:

ΕV	ISIONS:	DATE:
	CORRECTION LETTER	5/28/24

PROJECT / CLIENT:

2436 74TH AVE SE - SFR

LNL BUILDS

1,050.5 SF

-581.89 SF

PROJECT ADDRESS: 2436 74TH AVE SE MERCER ISLAND, 98040

DRAWING NAME:

SITE PLAN

DRAWN BY: DRA CHECKED BY: JML


ASE:


CONSTRUCTION DRAWINGS


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APPROVED FOR CONSTRUCTION:

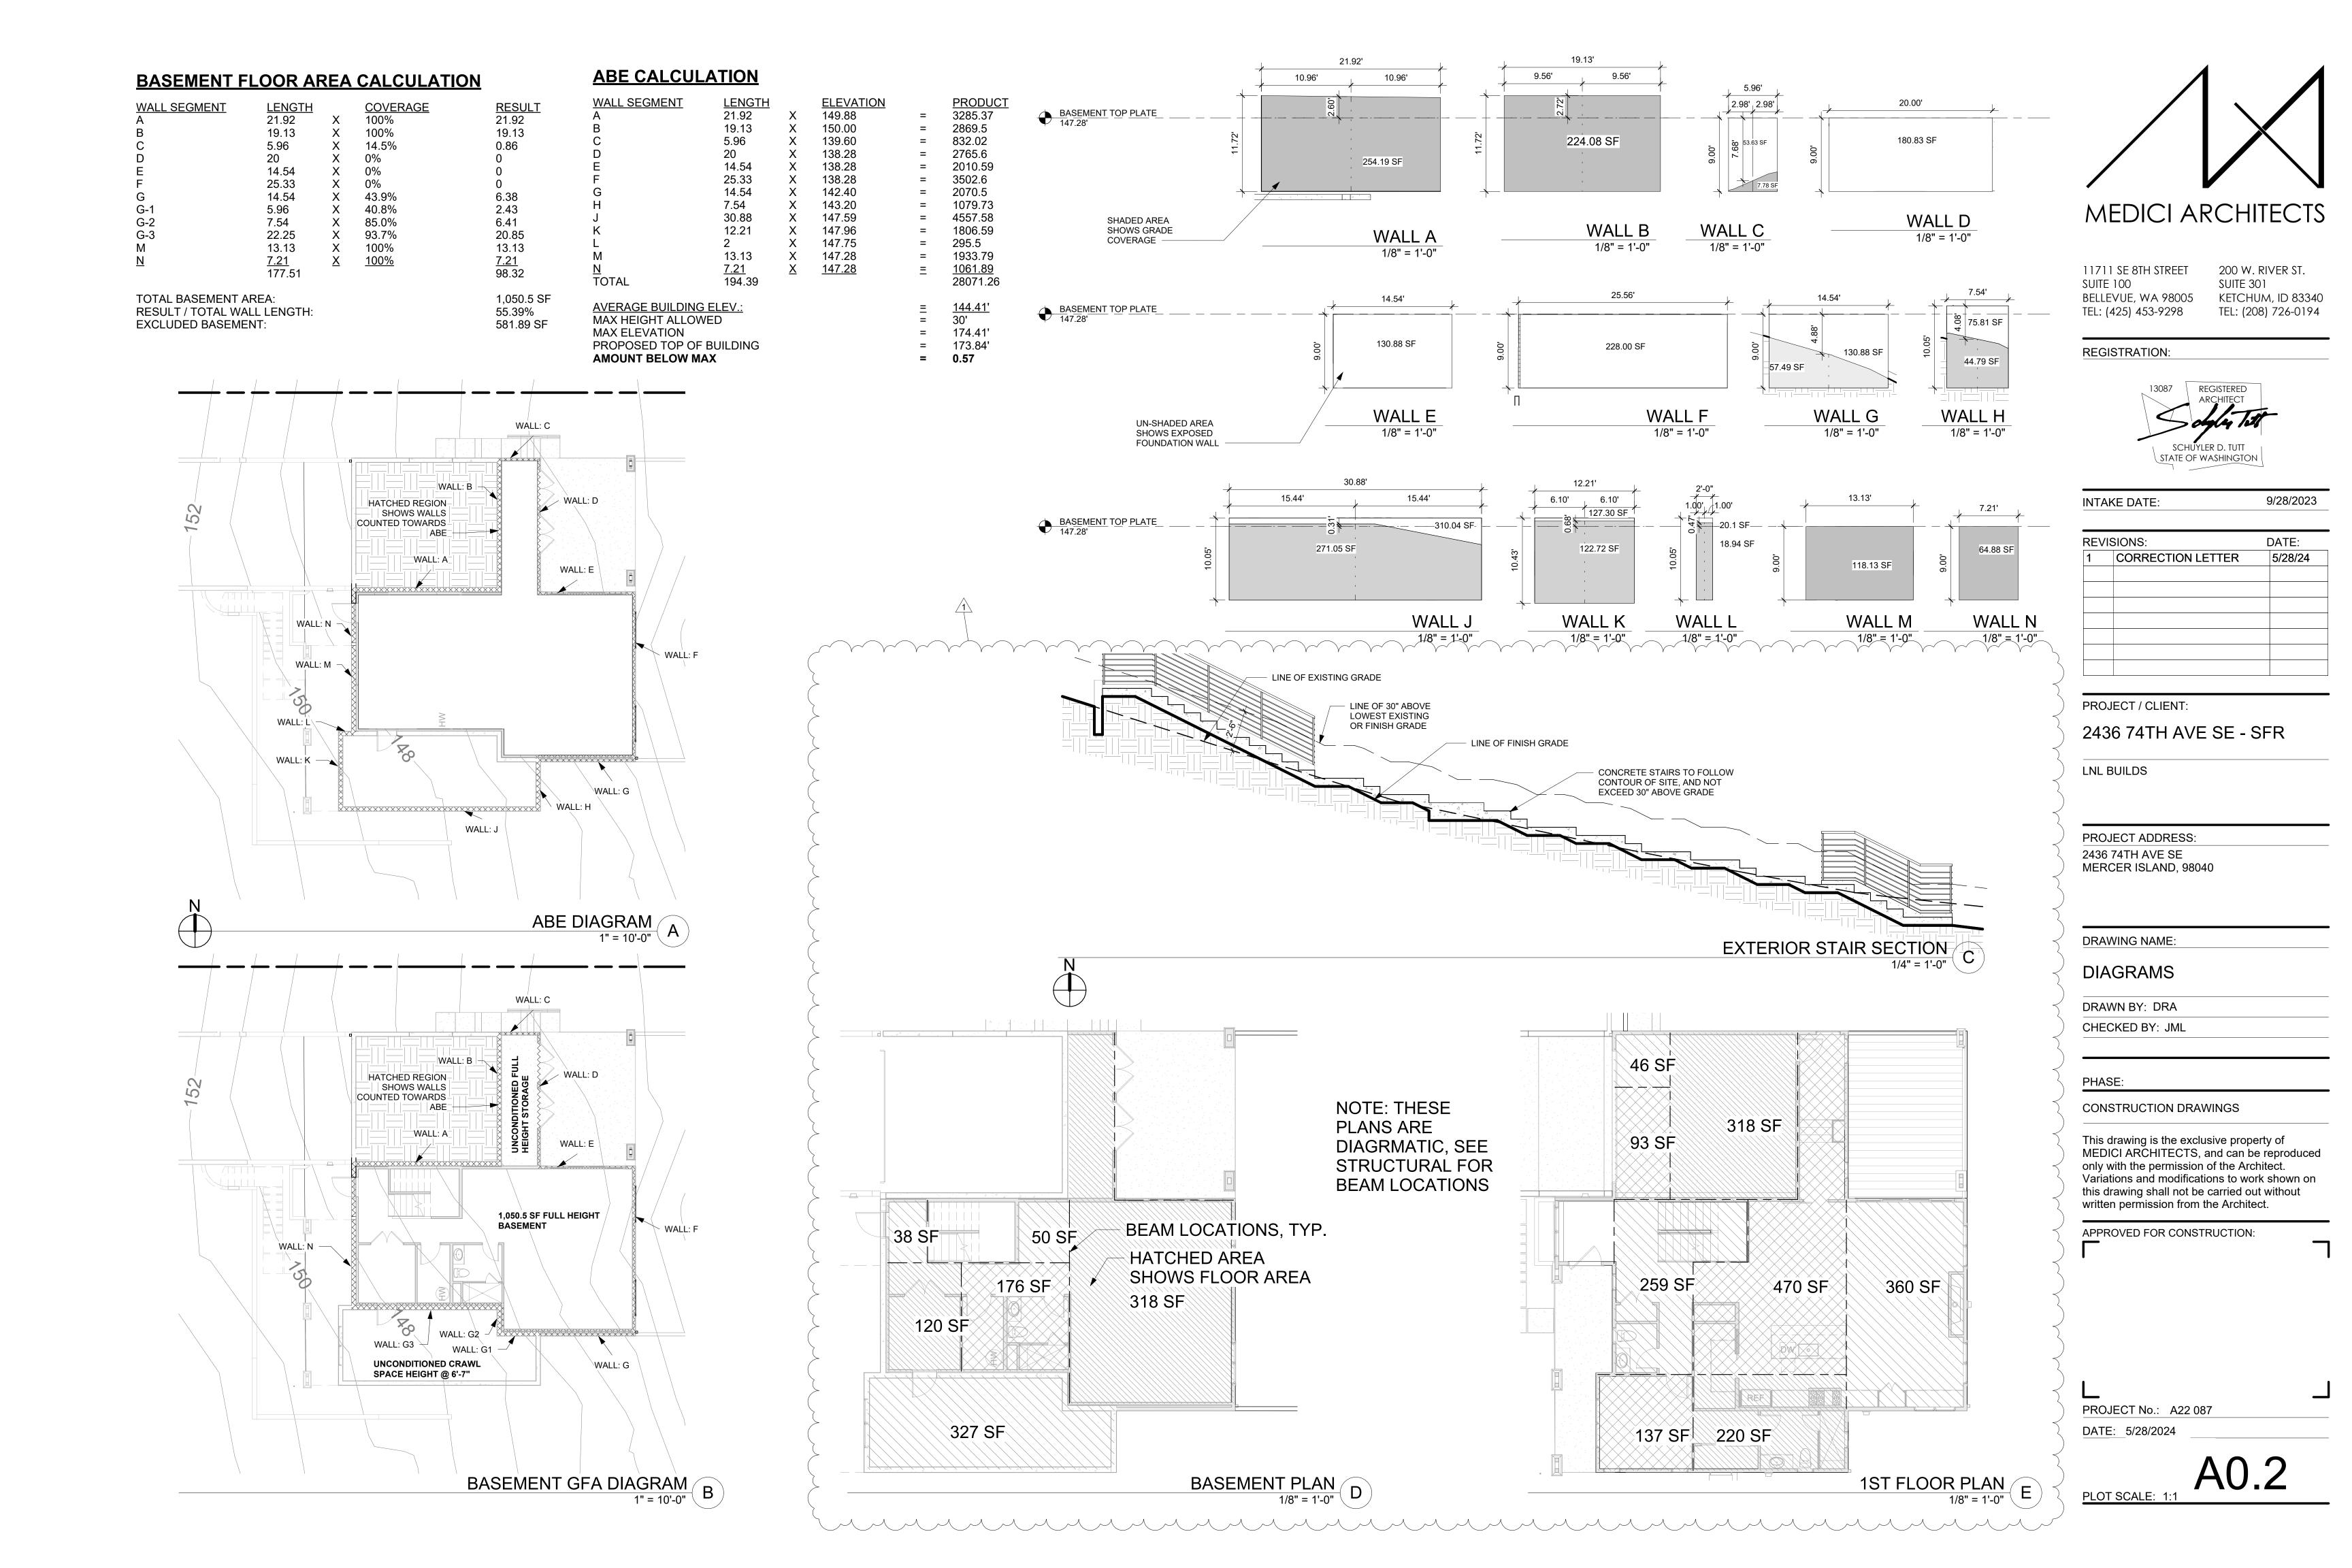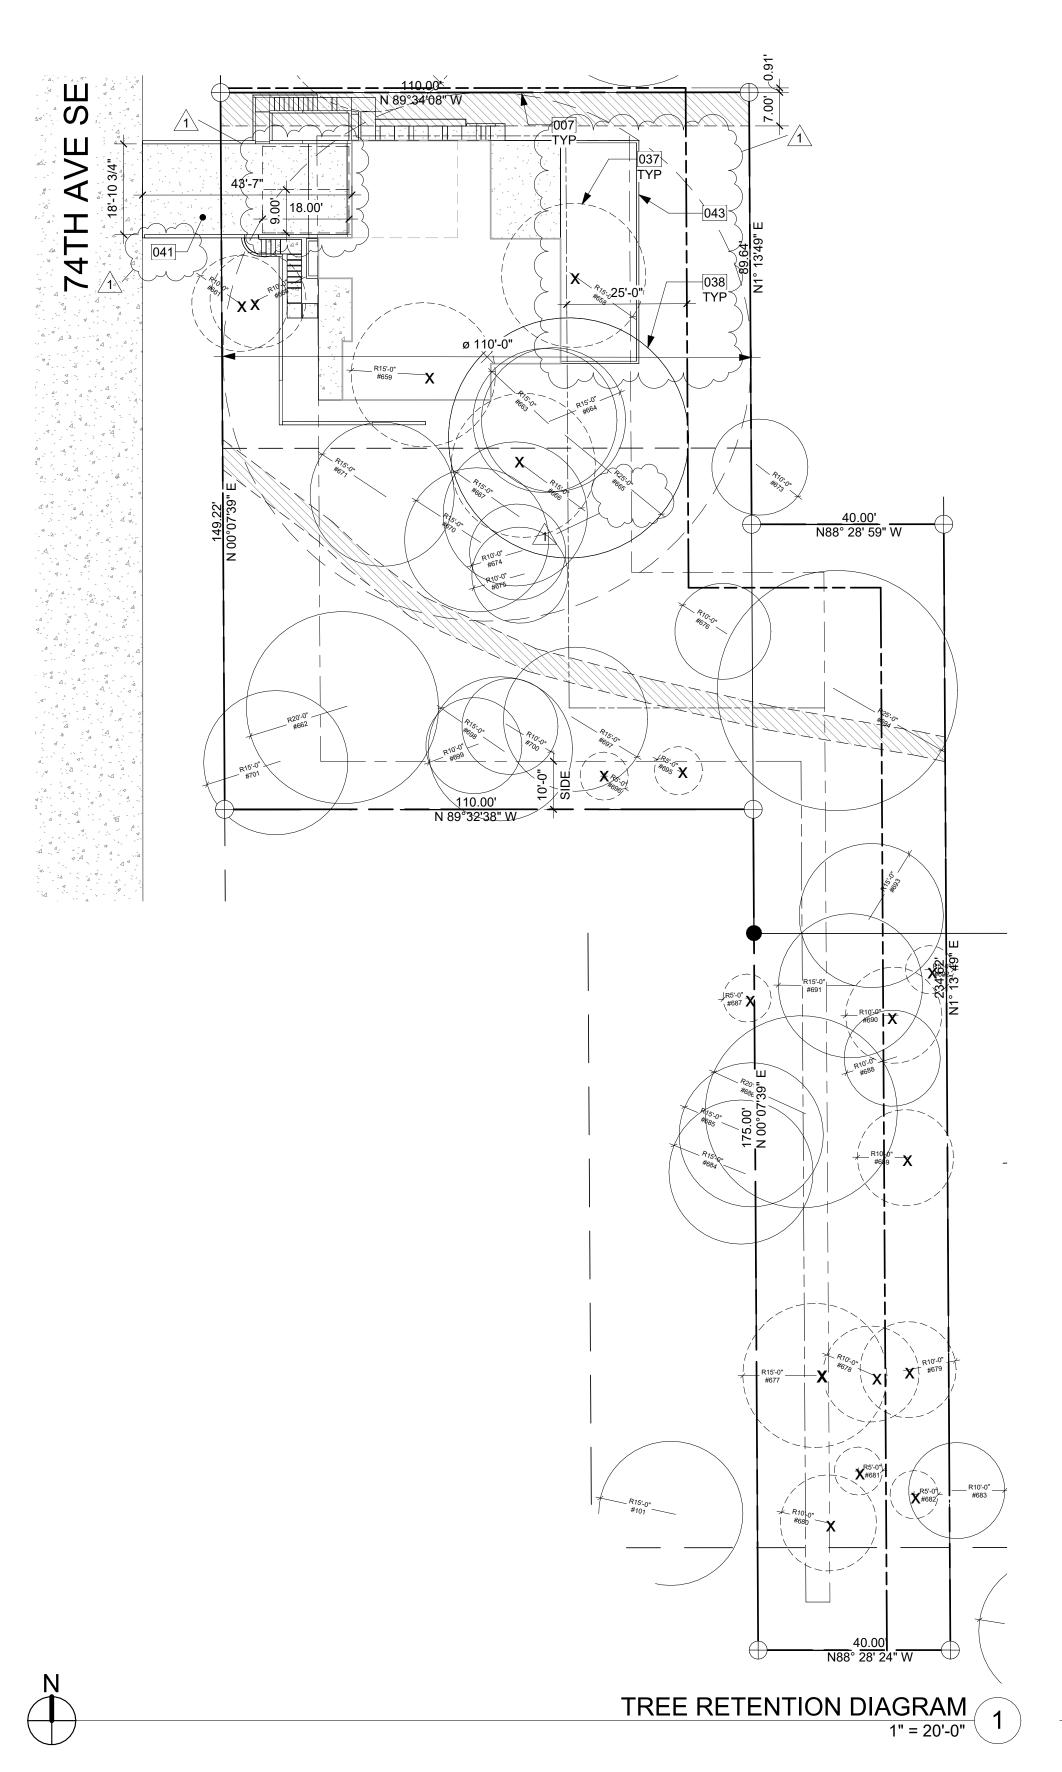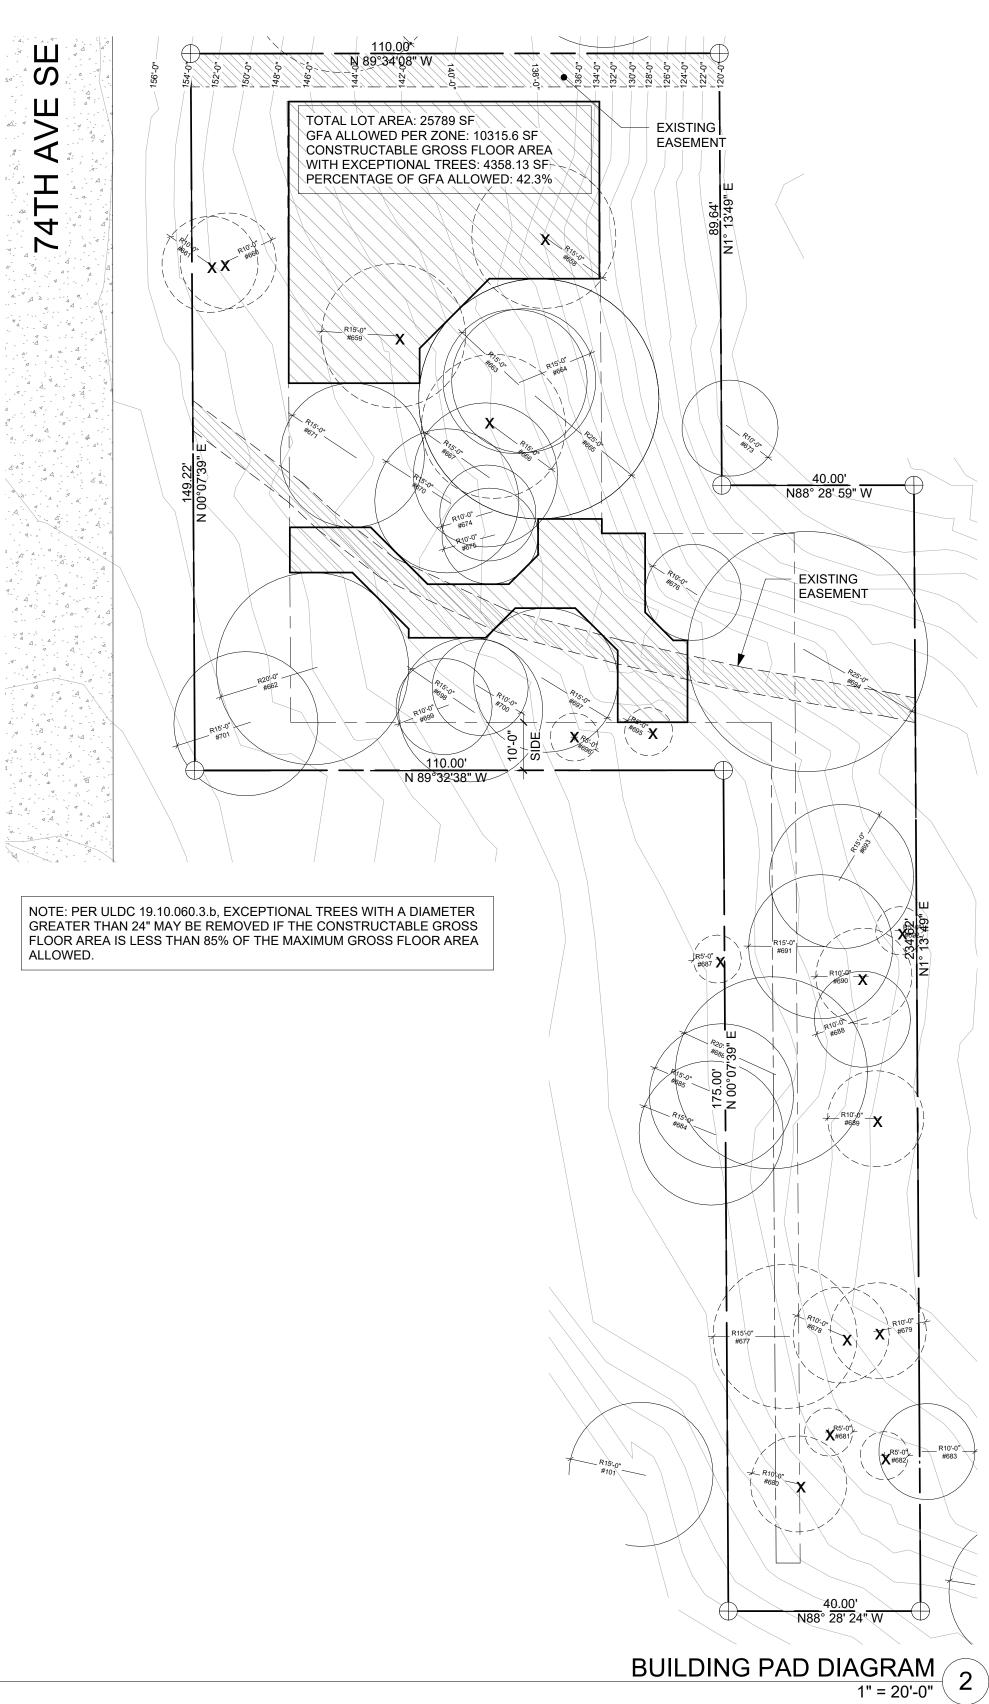PROJECT No.: A22 087 DATE: 5/28/2024







TREE DENSITY CALCULATION

ONSITE TR			00000			
TREE	NUMBER	EXCEPTIONAL	SPECIES	ACTION		<u>PRIORITY</u>
EXISTING	#658	YES (GROVE)	COTTONWOOD	REMOVE	22	2
EXISTING	#659	N/A	MAPLE BIGLEAF	REMOVE	18	4
EXISTING	#660	YES	WILLOW	REMOVE	16	3
EXISTING	#661	YES	WILLOW	REMOVE	14	3
EXISTING	#662	LARGE	MAPLE BIGLEAF	RETAIN	21	3
EXISTING	#663	YES (GROVE)	COTTONWOOD	RETAIN	20	2
EXISTING	#664	YES (GROVE)	COTTONWOOD	RETAIN	27	2
EXISTING	#665	YES	COTTONWOOD	RETAIN	37	2
EXISTING	#666	N/A	COTTONWOOD	REMOVE	24	4
EXISTING	#667	YES (GROVE)	COTTONWOOD	RETAIN	29	2
EXISTING	#668	YES (GROVE)	COTTONWOOD	RETAIN	22	3
EXISTING	#669	YES (GROVE)	COTTONWOOD	RETAIN	30	3 2
EXISTING	#670	YES (GROVE)	COTTONWOOD	RETAIN	24	2
EXISTING	#671	YES (GROVE)	MAPLE BIGLEAF	RETAIN	15	3
EXISTING	#673	YES (GROVE)	MAPLE BIGLEAF	RETAIN	12	3
EXISTING	#674	YES (GROVE)	CEDAR WESTERN-RED	RETAIN	10	2
EXISTING	#675	YES (GROVE)	CEDAR WESTERN-RED	RETAIN	12	
EXISTING	#676	LARĜE	MAPLE BIGLEAF	RETAIN	10	2 2
EXISTING	#677	YES	CEDAR WESTERN-RED	REMOVE	35	3
EXISTING	#678	N/A	COTTONWOOD	REMOVE	18	4
EXISTING	#679	N/A	ALDER RED	REMOVE	14	4
EXISTING	#680	N/A	MAPLE BIGLEAF	REMOVE	14	4
EXISTING	#681	N/A	ALDER RED	REMOVE	10	4
EXISTING	#682	N/A	ALDER RED	REMOVE	14	4
EXISTING	#683	LARGE	ALDER RED	RETAIN	12	3
EXISTING	#686	LARGE	CEDAR WESTERN-RED		20	2
EXISTING	#687	N/A	CHERRY	REMOVE	11	4
EXISTING	#688	YES	WILLOW	RETAIN	12	4
EXISTING	#689	N/A	ALDER RED	REMOVE	18	4
EXISTING	#690	N/A	WILLOW	REMOVE	19	4
EXISTING	#691	LARGE	MAPLE BIGLEAF	RETAIN	13	2
EXISTING	#692	N/A	CEDAR WESTERN-RED	REMOVE	15	4
EXISTING	#693	LARGE	MAPLE BIGLEAF	RETAIN	12	2
EXISTING	#694	LARGE	COTTONWOOD	RETAIN	33	3
EXISTING	#695	N/A	MAPLE BIGLEAF	REMOVE	37	4
EXISTING	#696	N/A	MAPLE BIGLEAF	REMOVE	22	4
EXISTING	#697	N/A	MAPLE BIGLEAF	RETAIN	22	4
EXISTING	#698	N/A	MAPLE BIGLEAF	RETAIN	20	4
EXISTING	#699	LARGE	CEDAR WESTERN-RED		13	2
EXISTING	#700	N/A	COTTONWOOD	REMOVE	21	3
EXISTING	#701	LARGE	CEDAR WESTERN-RED		24	2
EXISTING	#9582	N/A		REMOVE	8	4
EXISTING	#9583	YES	WILLOW	REMOVE	8	3
_,		0			•	•

TOTAL EXISTING TREES

SUPPLEI	MENTAL TREE	S	
<u>TREE</u>	<u>NUMBER</u>	<u>SPECIES</u>	<u>ACTIOI</u>
SUP.	#A	MAPLE BIGLEAF	ADD
SUP.	#B	MAPLE BIGLEAF	ADD
SUP.	#C	MAPLE BIGLEAF	ADD

TOTAL PROPOSED SUPPLEMENTAL TREES

OFFSITE TREES TREE NUMBER EXISTING #101 EXISTING #102 EXISTING #684 EXISTING #685	EXCEPTIONAL LARGE LARGE LARGE LARGE	SPECIES DOUGLAS-FIR MAPLE BIGLEAF CEDAR WESTER CEDAR WESTER	N-RED	<u>DBH</u> 25 22 25 12
PRIORITY 1 TREES RE PRIORITY 2 TREES RE PRIORITY 3 TREES RE PRIORITY 4 TREES RE	TAINED/REMOVEI	D D	0/0 14/0 6/5 <u>3/14</u>	0% RETAINED 100% RETAINED 54% RETAINED 17% RETAINED
TOTAL EXISTING TREI (EXEMPTED TREI COUNTED EXISTING TO PROPOSED RETAINED	<u>EES)</u> REES		42 <u>-17</u> 25 23	92% RETAINED

EXCEPTIONAL TREES REMOVED SUPPLEMENTAL TREES REQUIRED

- A MINIMUM OF 30% OF TREES WITH A DIAMETER OF 10" OR GREATER SHALL BE RETAINED PER MICC 19.10.060.2.a.
- PER ARBORIST REPORT, TREE PRESERVATION PRIORITY HAS BEEN GIVEN TO EACH MARKED TREE. TREES UNDER PRIORITY 4 ARE NOT CONSIDERED A LARGE TREE PER MICC 19.10.060.2.a.
- PRIORITY 1: HIGH PRIORITY FOR PROTECTION PRIORITY 2: GOOD OR FAIR CONDITION TREE WORTH PROTECTING, BUT NOT
- VALUABLE
- PRIORITY 3: POOR CONDITION AVERAGE TREE, NOT OWRTH ANY SPECIAL PROTECTION MEASURES.
- D. PRIORITY 4: TREES THAT SHOULD BE REMOVED UNDER MOST CIRCUMSTANCES.

3. TREE REPLACEMENT RATIO TO FOLLOW TABLE WITHIN MICC 19.10.070.A.


MICC 19.10.060 TREE REMOVAL

Retention of exceptional trees. Development proposals specified under subsection (a)(1) of this section shall retain exceptional trees with a diameter of 24 inches or more. Exceptional trees with a diameter of 24 inches or more that are retained shall be credited towards compliance with the retention requirements of subsection (A)(2) of this section. Removal of exceptional trees with a diameter of 24 inches or more, shall be limited to the following circumstances:

a.Retention of an exceptional tree(s) with a diameter of 24 inches or more will result in an unavoidable hazardous situation; or


b.Retention of an exceptional tree(s) with a diameter of 24 inches or more will limit the constructable gross floor area to less than 85 percent of the maximum gross floor area allowed under chapter 19.02

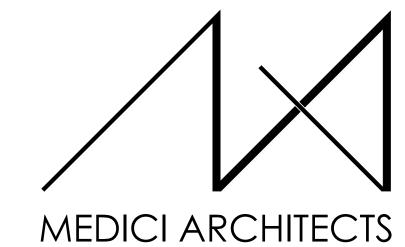c.Retention of an exceptional tree(s) with a diameter of 24 inches or more will prevent creation of a residential lot through a subdivision or short subdivision that is otherwise allowed by this title.



11711 SE 8TH STREET 200 W. RIVER ST. SUITE 301 SUITE 100 KETCHUM, ID 83340 BELLEVUE, WA 98005 TEL: (425) 453-9298 TEL: (208) 726-0194

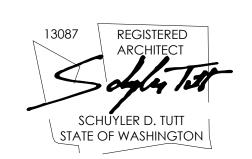REGISTRATION:



9/28/2023 INTAKE DATE:

REV	ISIONS:	DATE:
1	CORRECTION LETTER	5/28/24

PROJECT / CLIENT:

2436 74TH AVE SE - SFR

LNL BUILDS

PROJECT ADDRESS: 2436 74TH AVE SE MERCER ISLAND, 98040

DRAWING NAME:

TREE RETENTION DIAGRAM

DRAWN BY: DRA CHECKED BY: JML

PHASE:

CONSTRUCTION DRAWINGS

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APPROVED FOR CONSTRUCTION:

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PROJECT No.: A22 087	
DATE: 5/28/2024	

DIVISION 1 - GENERAL REQUIREMENTS:

THE GENERAL CONTRACTOR SHALL REVIEW THE CONSTRUCTION DOCUMENTS TO COMPLETE THE WORK AND NOTIFY THE ARCHITECT OF RESOLUTION FOR ALL DISCREPANCIES BETWEEN ARCHITECTURAL DRAWINGS, STRUCTURAL DRAWINGS AND CIVIL DRAWINGS PRIOR TO CONSTRUCTION.

DO NOT SCALE DRAWINGS - NOTIFY ARCHITECT OF DIMENSIONS IN QUESTION.

THE GENERAL CONTRACTOR IS RESPONSIBLE FOR CHECKING AND REVIEWING THE BUILDING DEPARTMENT APPROVED SET OF CONSTRUCTION DOCUMENTS. THE ARCHITECT SHALL BE PROMPTLY NOTIFIED OF REQUIRED CHANGES; AT THAT TIME, THE ARCHITECT WILL INITIATE APPROPRIATE ACTION.

THE GENERAL CONTRACTOR IS RESPONSIBLE FOR DISSEMINATING ALL INFORMATION CONTAINED IN THE DRAWINGS, SPECIFICATIONS AND BID DOCUMENTS TO EACH SUBCONTRACTOR.

INSTALLATION OF MATERIALS:

ALL PRODUCTS IN THE DRAWINGS OR INTERIOR SPECIFICATIONS SHALL BE INSTALLED IN STRICT ACCORDANCE WITH THE MANUFACTURER'S CURRENT PUBLISHED INSTRUCTIONS. MANUFACTURER'S INSTRUCTIONS IN CONFLICT WITH THE CONTRACT DOCUMENTS SHALL BE BROUGHT TO THE ATTENTION OF THE ARCHITECT PRIOR TO COMMENCEMENT OF THE WORK. PRODUCTS NOT PROVIDED WITH INSTALLATION INSTRUCTIONS SHALL BE INSTALLED IN ACCORDANCE WITH THE BEST TRADE PRACTICES OF THE INDUSTRY. IN ANY CASE, WORKERS EXPERIENCED AND SKILLED IN THE INSTALLATION OF THESE ITEMS SHALL INSTALL ALL PRODUCTS.

APPROVAL OF SUBSTITUTIONS:

THE GENERAL CONTRACTOR SHALL SUPPORT SUBSTITUTION REQUESTS FOR SPECIFIED MATERIALS WITH COMPLETE DATA, DRAWINGS AND SAMPLES AS NECESSARY FOR REVIEW BY THE ARCHITECT AND OWNER. ALLOW TIME FOR INVESTIGATION BEFORE A DECISION MUST BE MADE. WHEN THE ARCHITECT APPROVES A SUBSTITUTION, IT IS WITH THE UNDERSTANDING THAT THE GENERAL CONTRACTOR GUARANTEES THE SUBSTITUTED ARTICLE TO BE EQUAL OR BETTER THAN THE ONE SPECIFIED. ANY CHANGES TO THE CONTRACT SHALL BE DONE BY CHANGE ORDER.

THE GENERAL CONTRACTOR SHALL VERIFY ALL DIMENSIONS AND CONDITIONS BEFORE PROCEEDING. ANY VARIATION FROM THE DRAWINGS AND DIMENSION DISCREPANCIES SHALL BE BROUGHT TO THE ATTENTION OF THE ARCHITECT. PRIOR TO ANY FIELD CHANGES THERE MUST BE APPROVAL FROM THE ARCHITECT.

SITE EXCAVATION, BACKFILL, AND FINISH GRADING: EXCAVATION SITE TO GRADES AS SHOWN ON DRAWINGS (NOTIFY ARCHITECT OF ANY DEVIATIONS). REMOVE ALL EXCESS MATERIAL FROM SITE. DO NOT ASSUME ON-SITE MATERIAL ACCEPTABLE FOR BACKFILL. PLACE WASHED GRAVEL AS SHOWN. PROVIDE COMPACT FILL UNDER SLABS PER STRUCTURAL ENGINEERS SPECIFICATIONS. FINISH-GRADE SITE FOR LAWN.

EXTERIOR CONCRETE STAIRS ARE SHOWN DIAGRAMATICALLY, AND TO FOLLOW THE CONTOUR OF THE SITE WHILE COMPLYING WITH IRC R311. THE GENERAL CONTRACTOR TO VERIFY ALL DIMENSIONS AND CONDITIONS BEFORE PROCEEDING, AND SHALL BRING TO THE ATTENTION OF THE ARCHITECT ANY FIELD CONDITIONS THAT HAVE NOT BEEN DOCUMENTED.

EXISTING UTILITIES TO REMAIN, EXCEPT AS NOTED.

CONNECT ALL DOWNSPOUTS TO STORM SYSTEM PER CIVIL DRAWINGS.

DIVISION 3 - CONCRETE

PATCH ROCK PACKETS WHEN ABOVE GRADE WITH SACK FINISH. SEE

STRUCTURAL GENERAL NOTES FOR SUPPLEMENTAL INFORMATION.

CAST-IN-PLACE ARCHITECTURAL CONCRETE ALL CONCRETE SHALL BE MIXED, PROPORTIONED CONVEYED, AND PLACED IN ACCORDANCE WITH IRC SECTIONS R402.2 AND R403. PROVIDE NEW CONCRETE PATIO AND WALKWAY WITH CONTROL JOINTS AS INDICATED ON DRAWINGS. PREPARE GRADE, FILL, AND COMPACT AND SOFT AREAS. SEE STRUCTURAL PLANS AND NOTES.

DIVISION 4 - MASONRY: THIN BRICK MASONRY VENEER MECHANICALLY ATTACHED TO WALL PER MANUFACTURER, TO BE APPROVED BY OWNER.

DIVISION 5 - METALS:

METAL FABRICATIONS:

CUSTOM-FABRICATED METAL ITEMS INCLUDING EXTERIOR AND INTERIOR RAILINGS AND HANDRAILS TO BE APPROVED BY OWNER AND ARCHITECT, INSTALLED BY CONTRACTOR. ALL EXPOSED STRUCTURAL METAL CONNECTORS TO BE POWDER COATED, UNLESS NOTED OTHERWISE. COLOR TO BE DETERMINED. PROVIDE NEOPRENE GASKET AT ALL DISSIMILAR METAL CONNECTIONS, TYP. STRUCTURAL STEEL AND METAL FABRICATION REFER TO AND COMPLY WITH STRUCTURAL ENGINEERING NOTES, SPECIFICATION AND DRAWINGS. PROVIDE SHOP DRAWINGS SHOWING DETAILS OF FABRICATION, ASSEMBLY AND INSTALLATION INCLUDING TEMPLATES FOR ANCHOR BOLT PLACEMENT. GRIND SMOOTH EXPOSED WELDS. STEEL FINISHES:

EXTERIOR STEEL UNLESS NOTED OTHERWISE - GALVANIZED, INCLUDING ALL BOLTS, NUTS AND WASHERS. INTERIOR STEEL - SEE SHOP DRAWINGS

DIVISION 6 - WOODS & PLASTICS:

REFER TO AND COMPLY WITH STRUCTURAL ENGINEERING NOTES, SPECIFICATION AND DRAWINGS. PROVIDE BLOCKING FOR PLUMBING FIXTURES, BATH ACCESSORIES AND ELECTRICAL DEVICES.

PER R317.4 WOOD/PLASTIC COMPOSITES USED IN EXTERIOR DECK BOARDS. STAIRS TREADS, HANDRAILS AND GUARD RAIL SYSTEMS SHALL BEAR A LABEL INDICATING THE REQUIRED PERFORMANCE LEVELS AND DEMONSTRATING COMPLIANCE WITH THE PROVISIONS OF ASTM D 7032.

PRESSURE TREATED LUMBER AND PLYWOOD WITH WATER-BORN PRESERVATIVES FOR WOOD TO MASONRY, WOOD TO STRUCTURAL STEEL CONTACT AND AS SPECIFICALLY NOTED IN THE DRAWINGS. STRUCTURALLY GLUED LAMINATED UNITS: REFER TO AND COMPLY WITH STRUCTURAL ENGINEERING NOTES, SPECIFICATION AND DRAWINGS. SEAL ALL SURFACES, INCLUDING CUT ENDS AND DRILLED BOLT HOLES PRIOR TO PLACING MEMBERS. ALL EXPOSED TO WEATHER UNITS TO BE TREATED.

COMPLY WITH AWI QUALITY STANDARDS "CUSTOM", UNLESS INDICATED OTHERWISE. USE ONLY SEASONED LUMBER. CONCEAL FASTENERS WHEREVER POSSIBLE, EXCEPT WHERE EXPOSED FASTENERS ARE SHOW. HOT-DIP GALVANIZED OR STAINLESS STEEL FASTENERS FOR WORK EXPOSED TO EXTERIOR AND HIGH HUMIDITY. INSTALL EXTERIOR TRIM WITH MINIMAL POSSIBLE NUMBER OF JOINTS. CENTER JOINTS OVER VERTICAL MEMBERS WHEREVER POSSIBLE. STAGGER JOINTS IN ADJACENT RELATED MEMBERS. COPING TO RETURN. MITER AT CORNERS TO PRODUCE TIGHT FITTING JOINTS. USE SCARF JOINTS FOR END TO END JOINTS, INSTALL WITH FLUSH APPEARANCE. KERF BACKS AS REQUIRED TO AVOID WARPING. HAND SELECT LUMBER FOR INTERIOR TRIM OF SIMILAR GRAIN AND COLORATION. PRE-STAIN SEAL AND FINISH PER OWNER.

STAIRWAY CONSTRUCTION: CONSTRUCT ALL STAIRS IN ACCORDANCE WITH IRC SECTION R311.7, AND AS DETAILED IN THESE DRAWINGS.

INSTALL FIRE BLOCKING BOTH VERTICAL AND HORIZONTAL IN CONCEALED SPACES PER IRC SECTION R302.11.

INSTALL DRAFTSTOPPING IN ACCORDANCE WITH IRC R302.12.

FIRESTOP SYSTEMS SHALL BE PROVIDED AT THROUGH PENETRATIONS OF FIRE-RESISTANCE-RATED ASSEMBLIES, PER IRC R302.4.

DIVISION 7 - THERMAL & MOISTURE PROTECTION:

EXTERIOR WALLS SHALL BE PROVIDED WITH A WATER-RESISTANT BARRIER PER IRC R703.1.1.

FOUNDATION WALL DAMPROOFING:

APPLY ASPHALTIC EMULSION TO ALL BELOW-GRADE FOUNDATION WALLS. ALI BELOW-GRADE FOUNDATION WALLS GREATER THAN 48" HIGH SHALL ALSO BE PROTECTED WITH DRAINAGE MATTING (MIRADRAIN, DELTA-DRAIN, ENKADRAIN, OR APPROVED EQUAL).

FOUNDATION WALL WATERPROOFING:

ALL BELOW-GRADE FOUNDATION WALLS TO BE SPRAYED WITH GRAYWALL WATERPROOFING BY RUBBER POLYMER CORPORATION. THE MEMBRANE SHALL BE APPLIED TO A MINIMUM THICKNESS OF 40-MILS TO EXTERIOR SURFACES WHICH ARE CLEAN AND DRY, AND THE AMBIENT AIR TEMPERATURE IS 15° F OR ABOVE. FILL HONEYCOMBED AREAS, CRACKS, AND TIE-HOLES WITH NON-SHRINKING GROUT BEFORE APPLYING THE MEMBRANE.

ALL FOUNDATION WALLS GREATER THAN 48" HIGH (BELOW GRADE) SHALL ALSO BE PROTECTED BY DELTA-DRAIN DAMPPROOFING MEMBRANE BY COSELLA-DORKEN PRODUCTS, INC. SUPPLY ALL SYSTEM COMPONENTS INCLUDING DELTA-MS SHEET BARRIER, DELTA TERMINATION BAR, DELTA MOLDING STRIP, DELTA PLUG-AND-NAIL, AND ALL APPLICABLE SEALANTS.

SEE PLANS AND ENERGY CODE NOTES FOR SPECIFIC BUILDING ENVELOPE REQUIREMENTS PER 2018 WSEC.

ACOUSTIC INSULATION: PER OWNER SPECIFIED LOCATIONS.

ICYNENE PROSEAL (MD-C-200V3) SPRAY FOAM INSULATION: MEDIUM-DENSITY, HFC 365/227 BLOWN, CONFORMING TO THE FOLLOWING: THERMAL RESISTANCE (1 IN. OF MATERIAL / R-VALUE / IN @75 DEG F): ASTM

- C 518; 7.1 HR. SQFT. DEG F/BTU. AIR PERMEANCE (FOR 1 IN. OF MATERIAL): ASTM E 2178: LESS THAN 0.02
- L/S.M 2 @75 PA. WATER VAPOR TRANSMISSION (FOR 1.5 INCHES OF MATERIAL): ASTM E 96;
- 0.97 PERM.
- RESISTANCE TO FUNGAL GROWTH: ASTM C 1338: NO GROWTH. PRODUCT EMISSIONS: COLLABORATIVE FOR HIGH PERFORMANCE SCHOOLS (CHPS) "LOW-EMITTING" MATERIAL PER CA SECTION 01350 CRITERIA. ICYNENE PROSEAL (MD-C-200V3) FOAMED-IN-PLACE INSULATION 07 21 19-5 ICYNENE PROSEAL (MD-C-200V3) - USA LATEST REVISION: MAY 13.
- FLAME SPREAD & SMOKE DEVELOPED RATING: ASTM E 84 A. FLAME SPREAD: 25 B. SMOKE DEVELOPMENT: 300.

- MATERIAL PERFORMANCE: PROVIDE BUILDING WRAPS THAT ARE WATER-RESISTIVE BARRIERS AND AIR BARRIER MATERIALS HAVING AN AIR PERMEANCE NOT TO EXCEED 0.004 CUBIC FEET PER MINUTE PER SQUARE FOOT UNDER A PRESSURE DIFFERENTIAL OF 0.3 IN. WATER (1.57 PSF) (0.02
- L/SM @ 75 PA.) WHEN TESTED IN ACCORDANCE WITH ASTM E 2178. MECHANICALLY-FASTENED, MEMBRANE AIR BARRIERS: MATERIAL SHALL MEET REQUIREMENTS OF ICC-ES AC38, "ACCEPTANCE CRITERIA FOR WATER-RESISTIVE BARRIERS", CCMC TECHNICAL GUIDE 07102, "SHEATHING, MEMBRANE, BREATHER-TYPE", CCMC TECHNICAL GUIDE 07273, "AIR BARRIER MATERIALS" AND TEST REPORTS FROM ACCREDITED
- CONNECTIONS TO ADJACENT MATERIALS: PROVIDE CONNECTIONS TO PREVENT AIR LEAKAGE AT THE FOLLOWING LOCATIONS: 1. WALLS, INCLUDING PENETRATIONS, TIES AND ANCHORS; 2. WALLS, WINDOWS CURTAIN WALLS OR DOORS; 3. DIFFERENT WALL ASSEMBLIES, AND FIXED OPENINGS WITHIN THOSE ASSEMBLIES; 4. WALL AND ROOF CONNECTIONS; 5. WALL CONTROL AND EXPANSION JOINTS; 6. WALL PIPE AND DUCT PENETRATIONS; AND 7. WALL SEISMIC AND EXPANSION JOINTS.

A. FIBER CEMENT PLANK HORIZONTAL LAP SIDING W/ 6" EXPOSURE (HARDIPLANK SELECT CEDARMILL LAP SIDING, OR SIMILAR), PAINTED

- COLOR PER OWNER. FIBER CEMENT PANEL (HARDIPANEL SMOOTH VERTICAL SIDING, OR SIMILAR) RAINSCREEN PAINTED TO MATCH WINDOW FRAME FIBER CEMENT VERTICAL SIDING W/ 12" EXPOSURE (HARDIPANEL VERTICAL
- SIDING SIERRA 8, OR SIMILAR) RAINSCREEN. PAINTED COLOR PER OWNER. ENGINEERED T&G HORIZONTAL RAINSCREEN SIDING (RESYSTA™, OR APPROVED BY OWNER) W/ 4" EXPOSURE. INSTALL PER MANUFACTURER. STONE MASONRY VENEER MECHANICALLY ATTACHED TO WALL AND
- INSTALLED PER MANUFACTURER RECOMMENDATION. COLOR & PATTERN PER OWNER. THIN BRICK MASONRY VENEER MECHANICALLY ATTACHED TO WALL AND
- INSTALLED PER MANUFACTURER RECOMMENDATION, COLOR & PATTERN

WINDOW TRIM: FIBER CEMENT 1x6 (HARDITRIM, OR SIMILAR), PAINTED COLOR BY OWNER.

OUTSIDE VERTICAL TRIM: TAMLYN XTREME REVEAL XOCR

INSIDE VERTICAL TRIM: TAMLYN XTREME TRIM LOW PROVILE PLANK INSIDE CORNER (XICLP34).

CLEAR CEDAR T&G W/ 4" EXPOSURE, SEAL & STAIN ALL SIDES BEFORE INSTALLING AT ALL CUTS.

EXTERIOR STRUCTURAL WOOD SEALER:

STAIN EXPOSED WOOD BEAMS, OUTLOOKERS, COLUMNS, KNEE BRACES, RAFTER TAILS, ETC. WITH 2-COATS MINIMUM BENJAMIN MOORE "MOORWOOD" ALKYD SEMI-TRANSPARENT DECK AND SIDING STAIN OR EQUAL. COLOR TO BE DETERMINED. VERIFY W ARCHITECT / OWNER.

WATERPROOF DECK:

PLYWOOD SURFACE: 3/4" T&G, EXTERIOR GRADE B/C OR BETTER, INSTALLED B SIDE UP; PRIMER: TUFFLEX TUFF-POXY PRIMER #2 OR #3; BASE MEMBRANE: TUFFLEX SOLVENT FREE "TUFF"; AGGREGATE BINDING TOP COAT: TUFFLEX COLORCOAT AR (COLOR - ROCKY GRAY); TOP COAT: TUFFLEX COLORCOAT AL-ESTER TOP COAT (COLOR - ROCKY GRAY). INSTALLATION PER MANUFACTURER'S SPECIFICATION OVER SLOPED RIGID INSÚLATION. DECK TO BE 3/4" MIN CEDAR BOARDS OVER RIPPED PT 2x CONTINUOUS SLEEPERS.

ROOFING MATERIAL:

MEMBRANE: MANUFACTURER: WEATHERBOND, OR BY OWNER STYLE: MECHANICALLY FASTENED TPO, OR BY OWNER COLOR: GRAY, TO BE APPROVED BY OWNER. FASTENERS: PER MANUFACTURER.

COMPOSITION SHINGLE: MANUFACTURER:

PER OWNER STYLE: PER OWNER COLOR: PER OWNER FASTENERS: PER MANUFACTURER

STANDING SEAM METAL MANUFACTURER

UNDERLAYMENT:

WALL TRAYS:

VALLEY FLASHING:

TAYLOR METAL PRODUCTS, OR BY OWNER. PREMIER-LOCK, OR BY OWNER. DARK BRONZE, TO BE APPROVED BY OWNER. PER MANUFACTURER.

FASTENERS:

STYLE:

COLOR:

ICE & WATER SHIELD: INSTALL 36" WIDE ACROSS ALL HIPS AND VALLEYS, AND (2) 36" WIDE COURSES AT ALL FAVES. TYPE 30 PER ASTM D-226 28 GAUGE, ENAMELED, MIN. 24" "W"-FLASHING 26 GAUGE, ENAMELED, MIN. 6" TROUGH ROOF TO WALL FLASHING: 26 GAUGE, ENAMELED, MIN. 4" COMP.

PIPE FLASHING: 26 GAUGE, ENAMELED, MIN. 12" SKIRT CHIMNEY & SKYLIGHT FLSHNG: 26 GAUGE, ENAMELED SADDLE WITH DIVERTER WHERE WIDTH EXCEEDS 2 FEET IN-WALL COUNTER FLASHING: 26 GAUGE, ENAMELED 7-BAR FLASHING * DELIVER AND INSTALL PER IRC SECTION R905

LAP EAVE FLASHING INTO POWDER COATED ALUMINUM SQUARE GUTTER WITH MATCHING DOWNSPOUTS CONNECTED TO STORM DRAIN AND RUN TO APPROVED DISCHARGE, PER CIVIL. CUSTOM FABRICATED RAKE AT GUTTER END. DOWNSPOUT LOCATIONS PER PLANS.

PROVIDE LOW-PROFILE EAVE (RIDGEVENT20 BY AIR VENT INC, OR APPROVED EQUAL), RIDGE, AND RAKE VENTING AS WELL AS HAT-VENTS WHERE SHOWN. UN-VENTED SINGLE-JOIST ROOF CAVITY, PROVIDE ICYNENE PROSEAL (MD-C-200 v3) CLOSED-CELL WATER-BASED SPRAY FOAM INSULATION, APPLIED IN DIRECT CONTACT WITH UNDERSIDE OF ROOF SHEATHING.

PROVIDE FLASHING AND OTHER WEATHER PROTECTION PER IRC SECTIONS R903 AND R905. VALLEY FLASHING SHALL BE ENAMELED METAL WITH V-CRIMP TYPICAL TESTING LABORATORIES SHALL BE MADE AVAILABLE UPON REQUEST. ROOF-TO-MASONRY CONDITIONS SHALL HAVE ENAMELED STEPFLASH AND COUNTERFLASH.

DIVISION 8 - DOORS AND WINDOWS:

ALL EXTERIOR DOORS SHALL BE SELECTED BY OWNER. COLOR TO BE DETERMINED. PROVIDE CONTINUOUS INTERLOCKING METAL WEATHER-STRIPPING, BRASS ANODIZED METAL THRESHOLD, CYLINDER ENTRY LOCK ACCESS AND DEADBOLT DRILLING. DOUBLE-GLAZED SAFETY GLASS, WITH LOW-E (COLOR TO MATCH WINDOWS), AS INDICATED ON DRAWINGS. PROVIDE SCREENS AT SLIDING DOORS ONLY WHEN INDICATED ON DRAWINGS. PROVIDE INNOTECH OR EQUAL AS APPROVED BY ARCHITECT / OWNER.

ALL INTERIOR DOORS BY OWNER, CLEAR COATED (BOTH SIDES) WOOD VENEER OR PAINTED BOTH SIDES. VERIFY W/ OWNER. ALL POCKET- AND SURFACE-SLIDER DOORS PREMIUM TRACK AND ROLLER HARDWARE. VERIFY W/OWNER.

SEE ELEVATIONS FOR PANEL PATTERN, CLOPAY INSULATED STEEL BASE DOOR WITH WINDOW STYLE OPTIONS, STYLE TO BE SELECTED BY OWNER.

-EXTERIOR DOORS: TO BE SELECTED BY OWNER, KEY LOCK EXTERIOR, KNOB LOCK INTERIOR. WITH SEPARATE DEAD BOLT TO MATCH, TO BE DETERMINED BY OWNER. -INTERIOR DOORS: TO BE SELECTED BY OWNER. PROVIDE PRIVACY LOCKS AT ALL BATHROOMS AND BEDROOMS; PASSAGE LATCH AT ALL OTHERS UNLESS NOTED OTHERWISE; MATCHING HINGES TO MATCH LATCH SETS. VERIFY W/OWNER. PROVIDE 2 PAIR BUTTS ON ALL 8'-0" HIGH DOORS, 1-1/2 PAIR BUTTS ON 6'-8" OR 7'-0" DOORS. PROVIDE DOOR-STOPS TO MATCH HARDWARE.

ALL WINDOWS TO BE DOUBLE-PANED, VINYL, ANODIZED DARK BRONZE FINISH, WITH INSULATED LOW-E GLAZING. WINDOW PERFORMANCE AND CONSTRUCTION TO CONFORM WITH IRC SECTION R609. SIMULATED DIVIDED LITES SHALL HAVE 1" BEAD STOP PROFILE. HARDWARE FINISH SHALL MATCH DOOR HARDWARE. ALL CASEMENT OPENINGS SHALL HAVE ROTO HARDWARE. ALL OPENINGS WEATHER-STRIPPED BY MANUFACTURER; GENERAL CONTRACTOR SHALL INSTALL "Z"-FLASHING AT HEADS OF ALL WINDOWS AND SEAL WINDOW PERIMETER PER MANUFACTURER'S SPECIFICATIONS. PROVIDE INSECT SCREENS AT ALL OPERABLE LOCATIONS. EGRESS SHALL BE PROVIDED FROM ALL SLEEPING ROOMS PER IRC SECTION R310. GENERAL CONTRACTOR SHALL REVIEW ALL TEMPERED GLASS.

CRAWL SPACE & ATTIC ACCESS DOOR SIZE AND LOCATION PER PLAN.

SKYLIGHTS:

AS REQUIRED.

DIVISION 9 - INTERIOR FINISHES:

SMOOTH FINISH 1/2" GWB ON INTERIOR WALLS; 5/8" GWB ON CEILINGS. PROVIDE GYPSUM DRYWALL CONSTRUCTION FIRE RESISTANT RATINGS INDICATED INSTALL WATER- RESISTANT BACKING BOARD IN POOL ROOM, BATHROOMS, & OTHER SIMILAR "WET" AREAS NOT OTHERWISE INDICATED TO RECEIVE "WONDERBOARD" & TILE. INSTALL COMPOUND IN 3 COATS. PREFILL OF CRACKS RECOMMENDED BY MANUFACTURE. SAND AFTER FINAL 2 COATS. ATTACHMENTS: SCREW (ABSOLUTELY NO NAILS)

ACCESSORIES AND TAPE: AS RECOMMENDED BY GYPSUM BOARD MANUFACTURE & AS INDICATED IN THE DRAWINGS. JOINT COMPOUND: UNITED STATES GYPSUM CO. USE WATER-RESISTANT JOINT COMPOUND WITH WATER RESISTANT BACKING BOARD. FINISH: SMOOTH-WALLS. REGLETS AND BEADS: VERIFY WITH ARCHITECT & OWNER

TO BE SELECTED BY OWNER. APPLY (3) COATS SWEDISH FINISH. INSTALL FLUSH WOODEN FLOOR GRILLES PER MECHANICAL REQUIREMENTS FOR AIR VENTING.

VERIFY LOCATION OF GRILLES WITH ARCHITECT & OWNER.

BUILT-IN CABINETRY: VERIFY W/ OWNER.

INTERIOR STONE WORK/ HARD SURFACE COUNTERTOPS: WHERE APPLICABLE, COMPLY WITH RECOMMENDATION CONTAINED IN NATIONAL GRANITE QUARRIES ASSOC., INC. (NBGQA), STONE SLAB; NOT YET DETERMINED. VERIFY WITH OWNER. GROUT: HYDROMENT, COLOR AS SELECTED BY OWNER. SEALANTS: AS RECOMMENDED BY INSTALLER.

INTERIOR WOOD TRIM:

ALL INTERIOR WOOD TRIM TO BE MDF UNLESS NOTED OTHERWISE. VERIFY

ENTIRE RESIDENCE FIRST FLOOR SHALL HAVE A 1/2 X 5 VERIFY W/OWNER MDF BASEBOARD TRIM. ROOMS WITH CERAMIC TILE FLOORING SHALL HAVE A CERAMIC TILE BASE. VERIFY W/OWNER.

COMPLY WITH MORTAR AND GROUT MATERIALS AND INSTALLATION STANDARD OF THE AMERICAN NATIONAL STANDARDS INSTITUTE (ANSI) STANDARD SPECIFICATION FOR CERAMIC TILE AND MANUFACTURER'S INSTRUCTIONS FOR GLASS MESH MORTAR UNITS (WONDERBOARD) PER MANUFACTURE'S REQUIREMENT AT BATHROOMS, VERIFY EXPOSED EDGE OF THE TILE MEETING CARPET, WOOD, OR RESILIENT FLOORING, UNLESS OTHERWISE INDICATED. **GROUT:** HYDROMENT, COLOR AS SELECTED BY OWNER.

SEALANTS: ONE -PART MILDEW-RESISTANT SILICONE SEALANTS PER MANUFACTURER.

VERIFY ALL FINISH WITH OWNER PRIOR TO PROCEEDING. COLORS WILL BE

PAINT SPECIFICATIONS:

SELECTED BY OWNER FROM STANDARD COLOR AVAILABLE FOR THE COATINGS REQUIRED. APPLY REQUIRED PRIME COAT TO MATERIALS. PROVIDE BARRIER COATS OVER INCOMPATIBLE PRIMERS WHERE REQUIRED. PROVIDE FINISH COATS WHICH ARE COMPATIBLE WITH PRIMERS. SAND LIGHTLY BETWEEN LACQUER COATS. APPLY ADDITIONAL COATS UNTIL PAINT FILM IS OF UNIFORM FINISH, COLOR AND APPEARANCE.

PRIMED AND PAINTED METAL: FIRST COAT: POLY-AMIDE EPOXY SECOND COAT: ALIPHATIC POLYESTER FINISH COAT: URETHANE GALVANIZED STEEL: EXPOSED EXTERIOR GALVANIZED STEEL LEFT UNPAINTED. EXTERIOR: DECKING, SIDING, EXTERIOR CEDAR TRIM & SOFFIT BOARDS: SEE SPECIFICATION - DIVISION 6 - WOOD AND PLASTICS SECTION.

TO BE SELECTED BY OWNER. WOOD LACQUER DOORS: TWO COATS TINTED SEMI-TRANSPARENT UV RESISTANT LACQUER. - COLOR TO BE SELECTED BY OWNER. INTERIOR WOOD TRIM: TWO COASTS CLEAR SEMI-GLOSS TRANSPARENT UV RESISTANT LACQUER OR PRIME AND TWO COATS OIL BASED SEMI-GLOSS ENAMEL. REVIEW WITH OWNER LOCATIONS OF PAINT VERSUS LACQUER. GWB: FIRST COAT: PVA SEALER-PRIMER SECOND COAT: INTERIOR FLAT LATEX

WOOD PAINTED DOORS: PRIME & TWO COATS BENJAMIN MOORE IMPREVO. COLOR

LATEX (SEMI-GLOSS AT WET LOCATIONS). INTERIOR WOOD PANELS: TWO COATS SHOP APPLIED CLEAR TINTED SEMI-FRANSPARENT UV RESISTANT LACQUER. TOUCH UP FIELD CUTS AS REQUIRED. VERIFY W/OWNER.

(SEMI-GLOSS LATEX ENAMEL IN WET LOCATIONS) THIRD COAT: INTERIOR FLAT

DIVISION 10 - SPECIALTIES:

VERIFY W/OWNER SPECS. FOR ALL MIRRORS, TOWEL BARS, TOILET PAPER DISPENSERS AND ANY OTHER ACCESSORIES, WHETHER SHOWN ON PLANS OR

NOT. PROVIDE BLOCKING FOR ALL ACCESSORIES AS INDICATED ON DRAWINGS.

STORAGE SYSTEMS: CONSULT WITH OWNER ON CLOSET STORAGE SYSTEMS.

GARAGE DOOR OPENERS: N/A

DIVISION 11 - EQUIPMENT:

<u>DIVISION 12 - FURNISHINGS:</u> N/A

DIVISION 13 - SPECIAL CONSTRUCTION: N/A

DIVISION 14 - CONVEYING SYSTEMS: N/A **DIVISION 15 - MECHANICAL:**

HEATING AND VENTILATION: ENERGY STAR RATED GAS WATER HEATER MIN UEF 0.91. HEAT PUMP WITH MIN HSPF OF 10.0. MAX HEAT EQUIPMENT OUTPUT <u>64,413 Btu/HR</u>. ALL HABITABLE LIVING SPACES SHALL BE SERVED BY HEADS, TO BE APPROVED BY OWNER. ALL

EQUIPMENT INSTALLED PER MANUFACTURER RECOMMENDATION.

OR DUCTS TO BE CONSIDERED INSIDE A CONDITIONED SPACE, ALL DUCT SYSTEMS SHALL BE LOCATED COMPLETEY WITHIN THE CONTINUOUS AIR BARRIER AND WITHIN THE BUILDING THERMAL ENVELOPE, OR WHERE METALIIC DUCTS ARE LOCATED OUTSIDE THE CONDITIONED SPACE, THEY MUST HAVE BOTH TRANSVERSE AND LONGITUDINAL JOINTS SEALED WITH MASTIC. IF FLEX DUCTS ARE USED, THEY CANNOT CONTAIN SPLICES.

GARAGE/ CARPORT DUCTS:

PROVIDE EXHAUST FANS WHERE SHOWN ON FLOOR PLANS.

PROVIDED BY MECHANICAL CONTRACTOR; VERIFY LOCATION(S) W/OWNER.

GAS APPLIANCE FIREPLACES:

MODEL BY OWNER. INSTALL PER MANUFACTURER'S REQUIREMENTS. PER IRC R1004.2. FACTORY BUILT HEARTH EXTENTIONS FOR APPROVED FACTORY-BUILT FIREPLACES SHALL BE INSTALLED IN ACCORDANCE WITH THE LISTING OF THE FIREPLACE. THE HEARTH EXTENTION SHALL BE READILY DISTINGUISHABLE FROM THE SURROUNDING FLOOR AREA. FRAMING CLEARANCES PER SELECTED UNIT. PLUMBING:

UNCONDITIONED SPACE SHALL HAVE A THERMAL RESISTANCE OF R-10 FOR THE

HEATER BASE PER WSEC. PROVIDE SEISMIC STRAPS PER THE UPC. DRAIN HOT

WATER TANK PRESSURE-RELIEF VALVE TO OUTSIDE OF BUILDING OR TO FLOOR

PROVIDE RETICULATING PUMP AND PLUMB FOR INSTANT HOT WATER. SOURCES

OF IGNITION MUST BE KEPT AT LEAST 18" ABOVE FLOOR LINE. PROVIDE PLUMBING

DRAIN (PROVIDE 1" MINIMUM AIR GAP) USING HARD-DRAWN COPPER PIPING.

ALL PLUMBING TO BE INSTALLED PER THE UPC. WATER HEATERS IN

TO ALL FIXTURES SHOWN ON DRAWINGS. PROVIDE INSULATION FOAM AT ALL

SEPARATE FIRE PERMIT IS REQUIRED.

FLOOR, ROOF, AND WALL PLUMBING PENETRATIONS. SPRINKLER SYSTEM: A NFPA 13R FIRE SPRINKLER SPRINKLER SYSTEM IN COMPLIANCE WITH NFPA 13R AND COMI STANDARDS SHALL BE INSTALLED THROUGHT THE RESIDENCE. A

NFPA 72 AND COMI STANDARDS SHALL BE INSTALLED THROUGHOUT THE

FIRE ALARM SYSTEM A NFPA 72 - CHAPTER 29 MONITORED FIRE ALARM SYSTEM IN COMPLIANCE WITH

RESIDNCE. A SEPARATE FIRE PERMITE IS REQUIRED. DIVISION 16 - ELECTRICAL: ALL WORK SHALL CONFORM TO CURRENT AND APPLICABLE CODES AND SHALL BE COORDINATED WITH THE GENERAL CONTRACTOR. ELECTRICAL CONTRACTOR SHALL VERIFY REQUIREMENTS TO WIRE AND HOOK UP ALL EXHAUST FANS. APPLIANCES, FURNACES, AIR CONDITIONERS AND ALL OTHER EQUIPMENT REQUIRING ELECTRICAL SERVICE. ELECTRICAL CONTRACTOR SHALL VERIFY AND

ACQUIRE APPROVAL OF PANEL DISTRIBUTION AND SERVICE FROM OWNER AND

PROVIDE INSULATION FOAM AT ALL FLOOR, ROOF, AND WALL ELECTRICAL

GENERAL CONTRACTOR PRIOR TO INSTALLATION.

PENETRATIONS.

LIGHTING FIXTURE LAMPS:

ALL INCANDESCENT LAMPS RECESSED INTO INSULATED AREAS SHALL BE APPROVED FOR ZERO-CLEARANCE INSULATION COVER. ALL FLUORESCENT LAMPS SHALL BE FULL-SPECTRUM.

ELEVATOR: N/A

ATTIC SPACES: N/A

SMOKE & CARBON MONOXIDE DETECTORS:

SEE FLOOR PLANS. PROVIDE AND INSTALL SMOKE DETECTORS PER IRC SECTION R314. HARDWIRE 110-VOLT UNIT WITH BATTERY BACKUP. IN ALTERATIONS, REPAIRS & ADDITIONS PROVIDE AND INSTALL ADDITIONALLY PER IRC SECTION R314. PROVIDE & INSTALL CARBON MONOXIDE DETECTORS PER IRC SECTION R315 SMOKE ALARMS SHALL BE INSTALLED NOT LESS THAN 3' FROM THE DOOR OR OPENING OF A BATHROOM THAT CONTAINS A BATHTUB OR SHOWER. PHOTOELECTRIC SMOKE ALARMS SHALL BE INSTALLED NOT LESS THAN 6' FROM A COOKING APPLIANCE. IONIZATION SMOKE ALARMS SHALL BE INSTALLED NOT LESS THAN 20' FROM A COOKING APPLIANCE, OR NOT LESS THAN 10' WHEN EQUIPPED WITH AN ALARM-

WALL MOUNTED LIGHT FIXTURES: ALL WALL MOUNTED FIXTURES SHALL BE MOUNTED +80" FROM FINISH FLOOR TO CENTERLINE OF FIXTURE, UNLESS NOTED OTHERWISE. AT BOTTOM LIGHT VALENCE, LIGHT FIXTURE SHALL BE MOUNTED AT +84" AND TOP OF MIRROR SHALL

BE AT +80".

PROVIDE WATERPROOF DUPLEX OUTLETS UNDER THE EAVES WHERE SHOWN IN DRAWINGS. COLOR SHALL BE APPROVED BY ARCHITECT & OWNER. EAVES EXTENDING TO WITHIN 5' OF A PROPERTY LINE OR ASSUMED PROPERTY LINE SHALL BE CONSTRUCTED OF NOT LESS THAN 1-HR FIRE-RESISTANCE-RATED CONSTRUCTION, PER IRC 302.1.

BUILT-IN IRONING BOARD: N/A

PROVIDE WIRED DOOR CHIME & PUSH BUTTON; STYLE & COLOR TO BE DETERMINED. VERIFY W/OWNER.

VERIFY AND PROVIDE TELEPHONE, CABLE, AND INTERNET REQUIREMENTS PER

PROVIDE RECESSED SOUND SPEAKERS PER OWNER.

<u>GROUND FAULT CIRCUIT INTERRUPTER PROTECTION:</u> GROUND FAULT INTERRUPTER REQUIRED IN ALL BATHROOMS, ON OR ABOVE COUNTERTOPS WITHIN SIX FEET OF ANY SINK, IN ALL ACCESSIBLE GARAGE AREAS, IN ALL CRAWL SPACES, ALL OUTDOOR AREAS, AND ANY OTHER LOCATIONS AS REQUIRED BY THE NEC.

SWITCHES/OUTLETS AND COVER PLATES: ALL SWITCHES AND OUTLETS SHALL BE BLOCKED OUT FROM OPENINGS SUCH

DECORATIVE MOLDING, UNLESS NOTED OTHERWISE. SUPPLY AND INSTALL COVER PLATES ON ALL ELECTRICAL, TELEPHONE, AND CABLE OUTLETS. ALL COVER PLATES SHALL BE DECORA OR EQUAL; COLOR TO BE DETERMINED.

THAT COVER PLATES WILL NOT CONFLICT WITH DOOR AND WINDOW TRIM OR

ENERGY CODE COMPLIANCE NOTES: THE BUILDING THERMAL ENVELOPE SHALL BE INSTALLED IN ACCORDANCE WITH THE MANUFACTURER'S INSTRUCTIONS AND THE CRITERIA LISTED IN

- THE BUILDING SHALL BE TESTED AND VERIFIED TO HAVE AN AIR LEAKAGE RATE NOT EXCEEDING 1.5 AIR CHANGES PER HOUR.
- FIREPLACES SHALL HAVE TIGHT-FITTING FLUE DAMPERS AND OUTDOOR COMBUSTION AIR. INSULATION FOR HOT WATER PIPE SHALL HAVE A MINIMUM R-3.

<u>DUCT LEAKAGE TEST</u> RESULTS SHALL BE PROVIDED TO THE BUILDING INSPECTOR AND HOME OWNER PRIOR TO THE APPROVED FINAL INSPECTION. DUCTS SHALL BE LEAK TESTED IN ACCORDANCE WITH WSU RS-33, USING THE MAXIMUM DUCT LEAKAGE RATES SPECIFIED. DUCT TIGHTNESS SHALL BE VERIFIED

BY EITHER OF THE FOLLOWING: 1. POSTCONSTRUCTION TEST: TOTAL LEAKAGE SHALL BE LESS THAN OR EQUAL TO 4 ACH (113.3 L/MIN) PER 100 SQUARE FEET (9.29 M2) OF CONDITIONED FLOOR AREA WHEN TESTED AT A PRESSURE DIFFERENTIAL OF 0.1 INCHES W.G. (25 PA) ACROSS THE ENTIRE SYSTEM, INCLUDING THE MANUFACTURER'S AIR HANDLER ENCLOSURE. ALL REGISTER BOOTS SHALL BE TAPED OR OTHERWISE SEALED DURING THE TEST. LEAKAGE TO OUTDOORS SHALL BE LESS THAN OR EQUAL TO 4 CFM (133.3 L/MIN) PER 100 SQUARE FEET OF CONDITIONED FLOOR

2. ROUGH-IN TEST: TOTAL LEAKAGE SHALL BE LESS THAN OR EQUAL TO 4 CFM (113.3 L/MIN) PER 100 SQUARE FEET (9.29 M2) OF CONDITIONED FLOOR AREA WHEN TESTED AT A PRESSURE DIFFERENTIAL OF 0.1 INCHES W.G. (25 PA) ACROSS THE SYSTEM, INCLUDING THE MANUFACTURER'S AIR HANDLER ENCLOSURE. ALL REGISTERS SHALL BE TAPED OR OTHERWISE SEALED DURING THE TEST. IF THE AIR HANDLER IS NOT INSTALLED AT THE TIME OF THE TEST. TOTAL LEAKAGE SHALL BE LESS THAN OR EQUAL TO 3 CFM (85 L/MIN) PER 100 SQUARE FEET (9.29 M2) OF CONDITIONED FLOOR AREA. THE TEST RESULTS SHALL BE POSTED ON THE RESIDENTIAL ENERGY COMPLIANCE CERTIFICATE (WSEC 401.3). THIS SHALL BE PRESENT TO THE INSPECTOR AS A SIGNED AFFIDAVIT DOCUMENTING THE DUCT LEAKAGE TESTING RESULTS.

AIR HANDLERS LOCATED ENTIRELY WITHIN THE BUILDING THERMAL ENVELOPE.

EXCEPTION: THE TOTAL LEAKAGE TEST IS NOT REQUIRED FOR DUCTS AND

DUCTS LOCATED IN CRAWL SPACES DO NOT QUALIFY FOR THIS EXCEPTION. 2. A RESIDENTIAL ENERGY COMPLIANCE CERTIFICATE COMPLYING WITH WSEC R401.3 IS REQUIRED TO BE COMPLETED BY THE DESIGN PROFESSIONAL OR BUILDER AND PERMANENTLY POSTED WITHIN 3' OF THE ELECTRICAL PANEL PRIOR

TO THE FINAL INSPECTION.

3. MINIMUM 90% OF ALL INTERIOR LUMINAIRES SHALL BE HIGH EFFICACY LUMINAIRES AND ALL EXTERIOR LIGHTING SHALL BE HIGH EFFICIENCY LUMINAIRES. 4. ADDITIONAL ENERGY EFFICIENCY REQUIREMENTS PER WSEC R406 MUST BE

5. EACH DWELLILNG UNIT IS REQUIRED TO BE PROVIDED WITH AT LEAST ONE

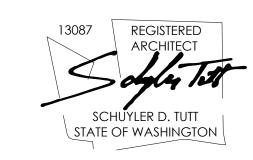
PROGRAMMABLE THERMOSTAT FOR THE REGULATION OF TEMPERATURE.

PROJECT No.: A22 087

MEDICI ARCHITECTS

11711 SE 8TH STREET 200 W. RIVER ST. SUITE 100 SUITE 301 KETCHUM, ID 83340 BELLEVUE, WA 98005 TEL: (425) 453-9298 TEL: (208) 726-0194

REGISTRATION:



9/28/2023 **INTAKE DATE: REVISIONS:** DATE: CORRECTION LETTER 5/28/24

PROJECT / CLIENT:

2436 74TH AVE SE - SFR

LNL BUILDS

PROJECT ADDRESS: 2436 74TH AVE SE

MERCER ISLAND, 98040

DRAWING NAME:

GENERAL NOTES

DRAWN BY: DRA

CHECKED BY: JML


PHASE:


CONSTRUCTION DRAWINGS

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APPROVED FOR CONSTRUCTION:

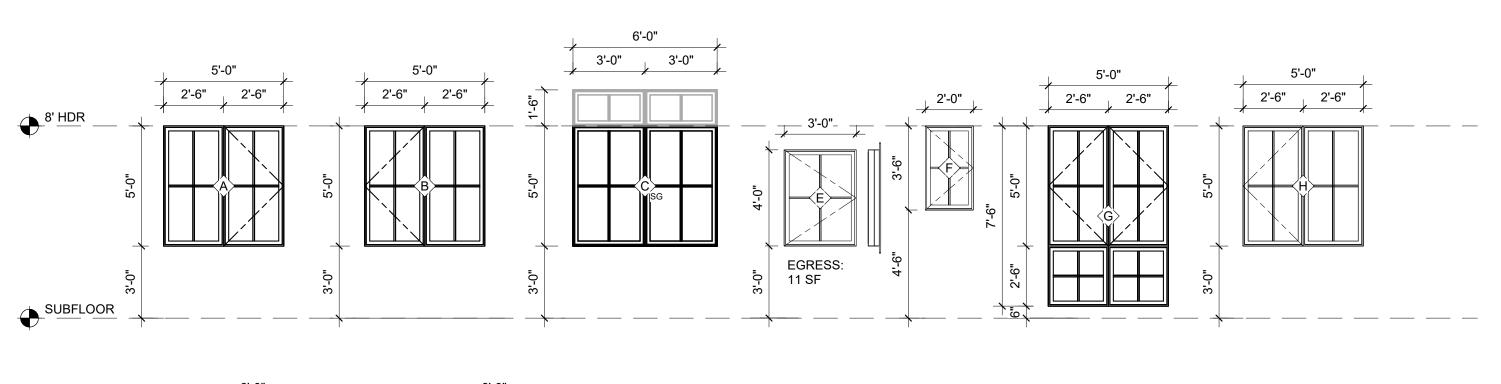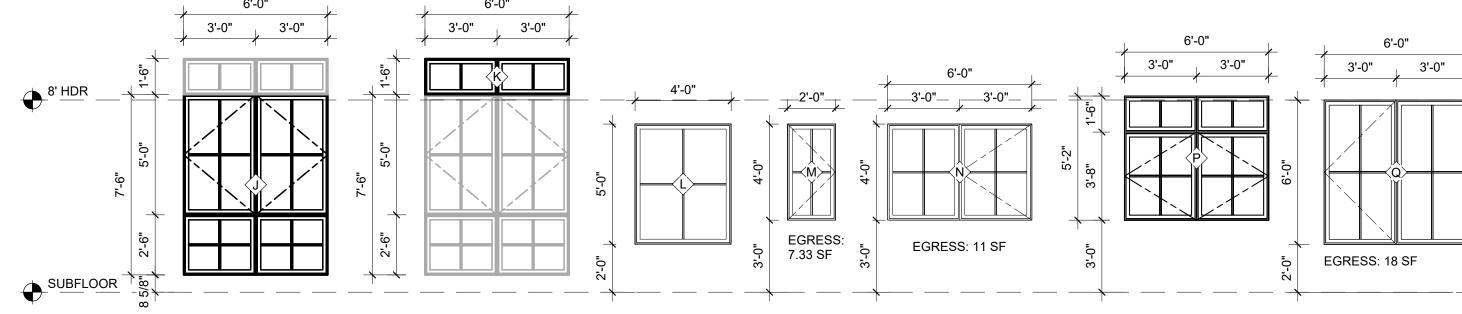DATE: 5/28/2024





8' HDR 8' -	 	 	
iguplus			

→ SUBFLOOR			
$oldsymbol{oldsymbol{\psi}}$ — — — — —	 	 	

NOTE: DOOR HEADER TO ALIGN WITH ADJACENT WINDOW HEADER

12'-0"	3'-0" 3'-0" 2'-6" 4'-0"	4'-0" 2'-0" 2'-0" 3'-6"
SUBFLOOR SUBFLOOR	3'-0" .0-1.8 .0-1.8	16'-0" 2'-10" 3'-10" 10

6'-0" 3'-0" 3'-0"	3'-0"			
	2'-8"	2'-6"	2'-0"	
$\begin{array}{c c} \bullet & & & \\ \bullet & \bullet & & \\ \bullet & & & \\ \bullet & & & \\ \end{array}$	□ 0- 13 □ 0- 8 □ 14 → 14 → 14 → 14 → 14 → 14 → 14 → 14		(19) Or (20)	
SUBFLOOR				


	WINDOW SCHEDULE											
NO	QTY	LOCATION	WIDTH	HEIGHT	AREA	MANUF.	U-VALUE	OPERATION	SCRE	EN S	G HARDWARE	COMMENTS
A	1	BONUS ROOM	5'-0"	5'-0"	25 SF	TBD	0.28	CASE / FIXED	Y/N	No	TBD	
В	1	BONUS ROOM	5'-0"	5'-0"	25 SF	TBD	0.28	CASE / FIXED	Y/N	No	TBD	
С	1	ENTRY	6'-0"	5'-0"	30 SF	TBD	0.28	FIXED	N	Ye	s TBD	
D	2	VARIOUS	3'-0"	3'-8"	22 SF	TBD	0.28	CASE	Y	<v es</v 		EGRESS PER PLAN
E	3	VARIOUS	3'-0"	4'-0"	36 SF	TBD	0.28	CASE	Υ	No	TBD	EGRESS PER PLAN
F	7	VARIOUS	2'-0"	3'-6"	49 SF	TBD	0.28	CASE	Y	<v es</v 	ari TBD >	
G	2	LIVING	5'-0"	7'-6"	75 SF	TBD	0.28	CASE / FIXED	Y/N	No	TBD	
Н	1	KITCHEN	5'-0"	5'-0"	25 SF	TBD	0.28	CASE / FIXED	Y/N	No	TBD	
J	1	ENTRY	6'-0"	7'-6"	45 SF	TBD	0.28	CASE / FIXED	Y/N	No	TBD	
K	2	ENTRY	6'-0"	1'-6"	18 SF	TBD	0.28	FIXED	N	No	TBD	
L	2	ENTRY	4'-0"	5'-0"	40 SF	TBD	0.28	FIXED	N	No	TBD	
М	10	VARIOUS	2'-0"	4'-0"	80 SF	TBD	0.28	CASE	Y	No	TBD	EGRESS PER PLAN
N	7	VARIOUS	6'-0"	4'-0"	168 SF	TBD	0.28	CASE / FIXED	Y/N	No	TBD	EGRESS PER PLAN
Р	1	BED 02	6'-0"	5'-2"	31 SF	TBD	0.28	CASE / FIXED	Y/N	No	TBD	
Q	1	BED 04 / OFFICE	6'-0"	6'-0"	36 SF	TBD	0.28	FIXED	N	No	TBD	
TOT	AL WIN	IDOW AREA: 753 SF			705 SF		0.28		UA =	210.84		
TOT	AL SKY	'LIGHT AREA: 0					0.5		UA =	0	NOTE: SEE A0.3 8	& A4.0~A4.1 FOR WINDOW DIVISIONS.
								TOT	AL UA =	210.84		

								EXTERIOR DOC	OR SCHEDULE			
NO	C	OTY LOCATION	WIDTH	HEIGHT	AREA	MANUF.	U-VALUE	DOC	R TYPE	OPERATION	SG	COMMENTS
01	2	BONUS ROOM	12'-0"	8'-0"	192 SF	TBD	0.28	SLIDING GLASS		OXXO	Yes	ALL GLAZING DOORS, TRANSOMS, AND SITELITES TO BE SAFETY GLASS
02	2	CRAWL SPACE HATCH	3'-0"	3'-0"	18 SF	TBD	0.28	FLUSH SWINGIN	NG	X	No	INSULATE TO R-21 (WALL)
04	2	EXTERIOR STORAGE	6'-0"	8'-0"	96 SF	TBD	0.28	FLUSH SWINGIN	NG	XX	No	
06	1	ENTRY	4'-0"	8'-0"	32 SF	TBD	0.28	PIVOT		Х	Yes	ALL GLAZING DOORS, TRANSOMS, AND SITELITES TO BE SAFETY GLASS
07	1	GARAGE	16'-0"	7'-0"	112 SF	TBD	0.28	OVERHEAD GAF	RAGE	Х	Yes	ALL GLAZING DOORS, TRANSOMS, AND SITELITES TO BE SAFETY GLASS
80	1	GARAGE	2'-10"	7'-0"	19.8 SF	TBD	0.28	FLUSH SWINGIN	NG	X	No	20-MIN INSULATED FIRE RATED W/SELF-CLOSER
Exteri	terior Door Total: 9 469.8 SF											
TOT	OTAL EXTERIOR DOOR AREA: 469.8-112= 357.8 SF 0.28 UA = 100.18											

						INTERIOR DOOR SCHEDL	ILE
NO	QTY	LOCATION	WIDTH	HEIGHT	MANUF.	DOOR TYPE	COMMENTS
03	1	MECH	3'-0"	8'-0"	TBD	SOLID SWINGING FLUSH	
)5	3	VARIOUS	2'-6"	8'-0"	TBD	SOLID SWINGING FLUSH	
)6	1	STORAGE	5'-0"	8'-0"	TBD	DOUBLE SOLID SWINGING FLUSH	
9	1	COAT	4'-0"	8'-0"	TBD	DOUBLE SOLID SWINGING FLUSH	
0	1	DINING	3'-0"	8'-0"	TBD	SURFACE SOLID SLIDER	
1	1	CLOSET	6'-0"	8'-0"	TBD	DOUBLE SOLID SLIDER	
12	1	VARIOUS	2'-8"	8'-0"	TBD	SOLID SWINGING FLUSH	
3	1	VARIOUS	2'-8"	7'-0"	TBD	SOLID SWINGING FLUSH	
14	1	PANTRY	3'-0"	8'-0"	TBD	SOLID SINGLE POCKET	
15	1	PRIMARY WC	2'-6"	7'-0"	TBD	SOLID SWINGING FLUSH	
16	2	VARIOUS	2'-8"	7'-0"	TBD	SOLID SWINGING FLUSH	
17	4	VARIOUS	2'-6"	7'-0"	TBD	SOLID SWINGING FLUSH	
18	2	VARIOUS	3'-0"	7'-0"	TBD	SOLID SWINGING FLUSH	
19	1	HALLWAY	2'-0"	7'-0"	TBD	SOLID SWINGING FLUSH	
20	1	BATH 02	2'-6"	7'-0"	TBD	SOLID SINGLE POCKET	
nterio	or Doo	r Total: 22					

SCHEDULES NOTES

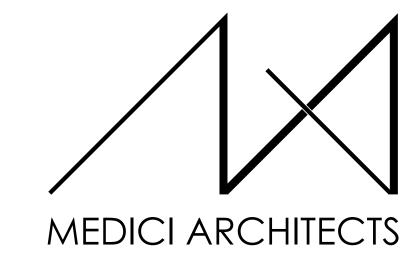
- GENERAL CONTRACTOR SHALL PROVIDE MANUFACTURER'S DATA ON ALL WINDOWS AND EXTERIOR DOORS SHOWING COMPLIANCE WITH THE 2018 WASHINGTON STATE ENERGY CODE.
- OPERATION SHOWN ON SCHEDULE IS GENERIC. WINDOW AND DOOR OPERATION PER ELEVATIONS. ALL EXTERIOR TRUE DIVIDED FIXED TRANSOM GLAZING TO BE POSITIONED
- AT UPPER SASH.
- ALL WINDOWS AND GLAZING IN DOORS TO BE NFRC CERTIFIED AND LABELED.
- DIMENSIONS INDICATE NOMINAL SIZE. ROUGH OPENING PER MANUFACTURER RECOMMENDATIONS.
- SAFETY GLAZING SHALL BE INSTALLED IN HAZARDOUS LOCATIONS AS DEFINED IN IRC R308.4 AND SHALL BEAR A MANUFACTURER'S DESIGNATION THAT IS VISIBLE AT FINAL INSTALLATION. SAFETY GLASS ON ELEVATIONS IS INDICATED WITH "SG".
- VERIFY ALL DOOR AND WINDOW TYPES & HARDWARE W/ OWNER PRIOR TO ORDERING.
- ALL EXTERIOR DOOR AND WINDOW FRAMES TO BE METAL. VERIFY W/
- EMERGENCY EGRESS AND RESCUE OPENINGS SHALL MEET THE REQUIREMENTS OF IRC SECTION R310.
- ALL DOORS STANDARD JAMB DIMENSION 4-1/2" FROM HINGE TO ADJACENT
- FRAMING UNLESS OTHERWISE NOTED.
- SURFACE SLIDER DOOR PANELS TO BE 6" WIDER AND 2" TALLER THAN THEIR OPENING.
- WINDOW FALL PROTECTION IS REQUIRED WHERE THE TOP OF THE SILL OF AN OPERABLE WINDOW IS LOCATED LESS THAN 24" ABOVE THE ADJACENT FINISHED FLOOR AND MORE THAN 72" ABOVE THE FINISHED GRADE OR SURFACE BELOW ON THE EXTERIOR OF THE BUILDING.
- WHERE WINDOW FALL PROTECTION IS REQUIRED, WINDOW OPENING CONTROL DEVICES SHALL BE PROVIDED PER IRC R312.2, IN COMPLIANCE WITH ASTM F2090.
- WHERE WINDOW FALL PROTECTION IS PROVIDED, OPENING CONTROL DEVICES SHALL NOT REDUCE THE NET CLEAR OPENING AREA OF WINDOW UNITS THAT SERVE AS EMERGENCY EGRESS AND RESCUE OPENINGS.



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REGISTRATION:



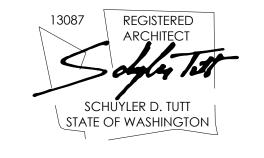9/28/2023 INTAKE DATE: **REVISIONS**: DATE:

PROJECT / CLIENT:

2436 74TH AVE SE - SFR

LNL BUILDS

PROJECT ADDRESS: 2436 74TH AVE SE MERCER ISLAND, 98040

DRAWING NAME:

SCHEDULES

DRAWN BY: DRA


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FOUNDATION PLAN 1/4" = 1'-0"

KEY NOTES

PROPOSED PROPERTY LINE IN BLA PERMIT, SEE PERMIT 2LLA_23001 16"x8" CRAWL SPACE VENT AND PREFABRICATED GALVANIZED VENT WELLS AS REQUIRED TO ENSURE AIR FLOW PER IRC SECTION 408.1 AND WITH BAFFLES TO ENSURE UNOBSTRUCTED VENT AREA, TYP. ENSURE VENTS ARE NOT IN CONFLICT WITH STRUCTURAL FLOOR FRAMING OR HOLD-DOWNS. BAR GRATING ON TOP AS NECESSARY. STEMWALL & FOOTING PER STRUCTURAL. CRAWL SPACE ACCESS PER R408.4. PERIMETER WALL 16"x24" MIN. OPENING WITH R-21 INSULATION. CONCRETE SLAB (4" MIN. OR PER STRUCTURAL) OVER GRAVEL OR CRUSHED ROCK (4" MIN. OR PER GEOTECH) OVER FIRM UNDISTURBED SOIL. REINFORCING PER STRUCTURAL. EXTERIOR SLABS TO RECEIVE BROOM FINISH AND TO SLOPE 1/4" PER FOOT AWAY FROM BUILDING. CONCRETE SLAB (4" MIN. OR PER STRUCTURAL) OVER VAPOR BARRIER (6

MIL MIN. OR PER GEOTECH &/OR ENVELOPE CONSULTANT) OVER |CONTINUOUS R-10 RIGID INSULATION OVER GRAVEL OR CRUSHED ROCK (4" MIN. OR PER GEOTECH) OVER FIRM UNDISTURBED SOIL. REINFORCING PÈR CONCRETE SLAB (4" MIN. OR PER STRUCTURAL) OVER GRAVEL OR

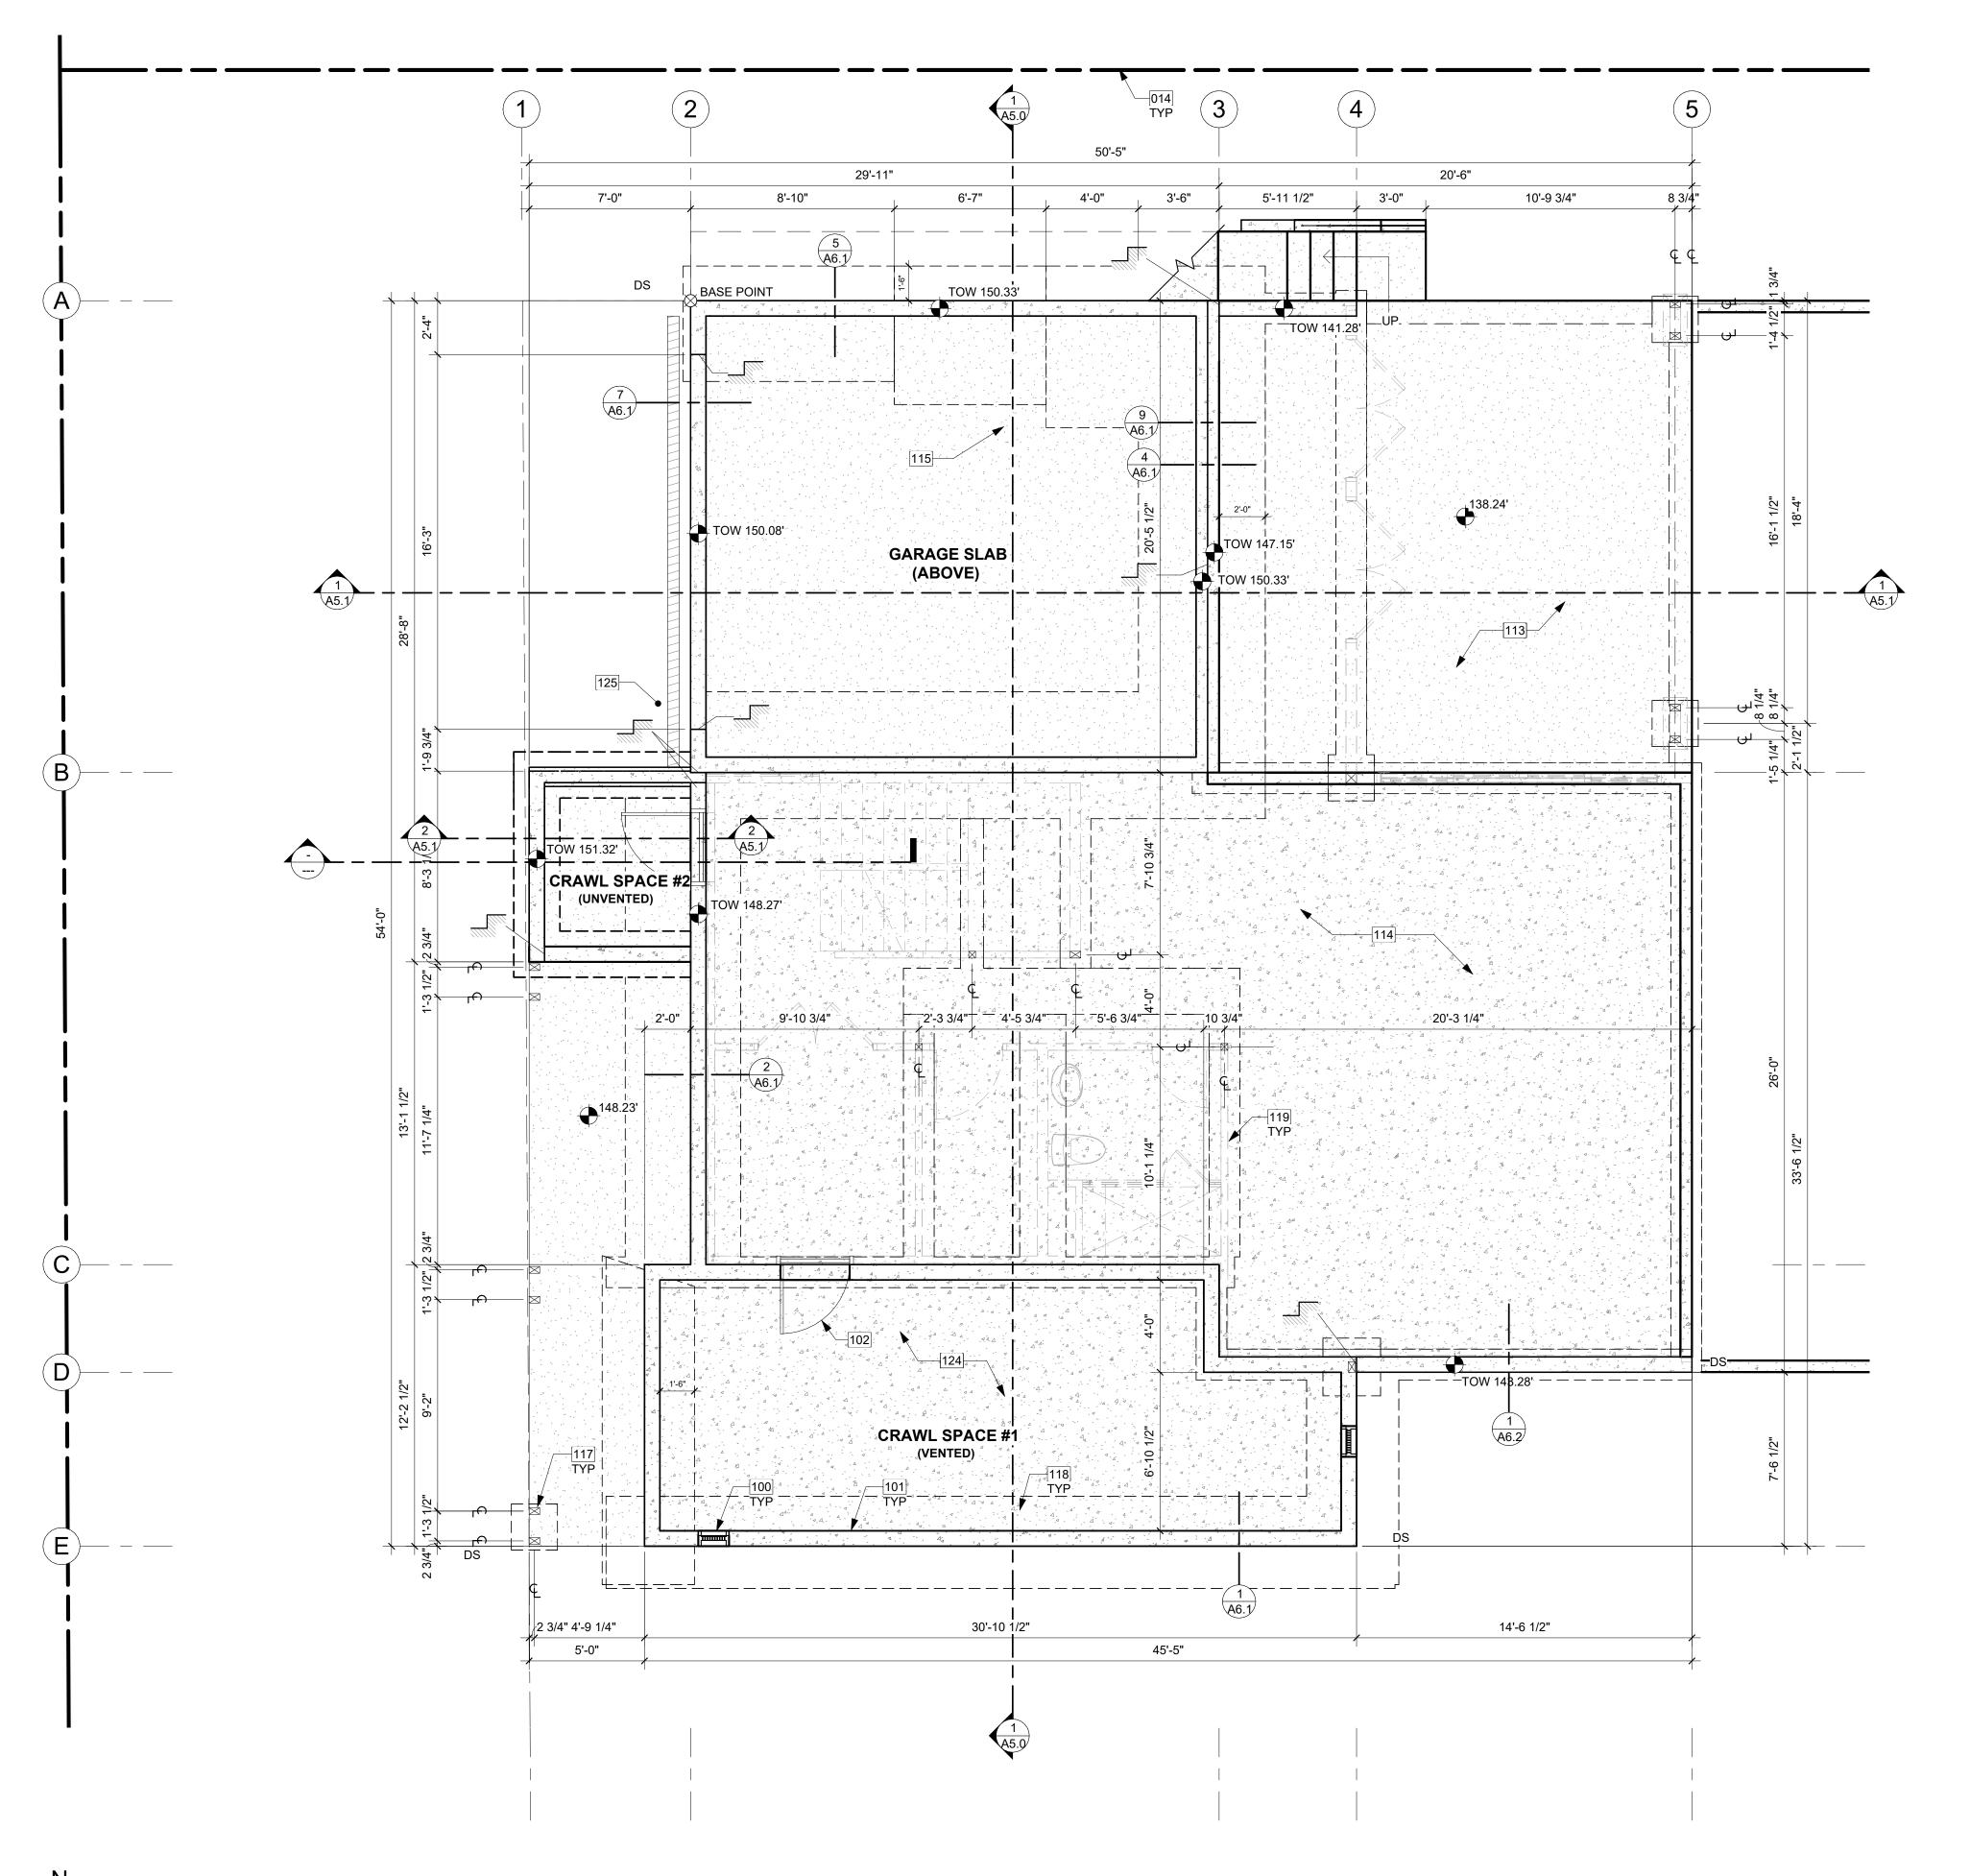CRUSHED ROCK (4" MIN. OR PER GEOTECH) OVER FIRM UNDISTURBED SOIL. REINFORCING PER STRUCTURAL. POSTS AND FOOTING PER STRUCTURAL

CRAWLSPACE FOUNDATION PER STRUCTURE. 18" MIN CRAWLSPACE W/ 6 MIL BLACK VAPOR BARRIER, CLASS 1 VAPOR RETARDER OVER GRADE AND

DASHED LINE OF FOOTINGS PER STRUCTURAL, TYP. DASHED LINE OF WALLS ABOVE, TYP.

TRENCH DRAIN ABOVE PER CIVIL

CRAWL SPACE VENTILATION

CS #1 AREA=

CS #1 VENTILATION REQUIRED:

BE INSTALLED, PER IRC R408.2.

CS #1 NET VENT AREA =

VENTS REQUIRED =

CS #1 PROVIDE:



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		\\\\\\\\\\\\\\\\\\\\\\\\\\\\\\\\\\\\\\
CS #2 AREA=	44.99 SF	
CS #2 VENTILATION REQUIRED:	1 CF/MIN FOR EVERY 50 SF	
USE:	MECHANICAL VENTILATION	
VENTILATION RATE REQUIRED =	44.99 SF / 50 SF = .9 CF	1 CF/MIN
CS #2 PROVIDE:	1 CF/MIN FAN	

CS #1 TOTAL MIN. VENTILATION PROVIDED = 147 SI IS GREATER THAN 142.77 REQ. NOTE: IF VENTILATION IS REDUCED TO 1 SI/1500 SF, A CLASS I VAPOR RETARDER

SHALL BE PROVIDED OVER ENTIRE GROUND SURFACE AND A RADON VENT SHALL

(297.43 SF x 144 SI) / 300 = 142.77 SI

2 VENTS

147 SI

16"x8" FOUNDATION VENTS

98.0 SI (-25%) = 73.5 SI

142.77 SI / 73.5 SI =

(2) 16"x8" VENTS =

NOTE: EXPOSSED EARTH TO BE COVERED WITH CONTINUOUS CLASS 1 VAPOR RETARDER. JOINTS TO BE OVERLAPPED BY 6 INCHES AND SHALL BE SEALED OR TABED. EDGES SHALL EXTEND AT LEAST 6 INCHES UP STEM WALL, ATTACHED AND SEALED TO THE STEM WALL. A RADON SYSTEM SHALL BE INSTALLED THAT MEETS THE REQUIREMENTS OF WSRC R408.3.

DRAWING NAME:

FOUNDATION PLAN

DRAWN BY: DRA CHECKED BY: JML

PHASE:

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Variations and modifications to work shown on

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SHORING AND SUCH OTHER RELATED WORK AS REQUIRED, SHALL BE CONDUCTED BY THE CONTRACTOR. STOP WORK IF RECOMMENDED EXCAVATION CUT OR BEARING SOIL CHANGES OCCUR IN EITHER HORIZONTAL OR VERTICAL DIRECTION AND NOTIFY IMMEDIATELY THE GEOTECHNICAL ENGINEER AND STRUCTURAL ENGINEER. AT WHICH POINT THE ENGINEERS SHALL DETERMINE CAUSE OF DISPLACEMENT AND DEVELOP AND IMPLEMENT REMEDIAL MEASURES.

FOOTINGS SHALL BEAR ON SOLID UNDISTURBED EARTH (CONTROLLED, COMPACTED STRUCTURAL FILL OR BOTH). DEPTH OF FOOTINGS TO BE DETERMINED BY STRUCTURAL ENGINEER. FOUNDATION EXCAVATION,

BACKFILL AND COMPACTION SHALL CONFORM TO SPECIFICATION REQUIREMENTS. THIS CONSTRUCTION WORK, INCLUDING DRAINAGE,

REFER TO STRUCTURAL PLANS FOR ALL FRAMING & FOUNDATION INFORMATION ALL IMPERVIOUS SURFACES TO BE GRADED TO SLOPE AND DRAIN AWAY

FROM THE STRUCTURE MIN. 1/4" PER FOOT.

FOUNDATION PLAN NOTES

- UNVENTED CRAWL SPACES SHALL SATISFY IRC R408.3 WITH: A CONTINUOUS CLASS I VAPOR RETARDER WITH JOINTS LAPPED BY 6" MINIMUM AND SEALED OR TAPED. THE EDGES OF THE VAPOR RETARDER SHALL EXTEND AT LEAST 6" UP THE STEM WALL AND SHALL BE ATTACHED OR SEALED TO THE STEMWALL.
- A RADON SYSTEM THAT MEETS THE REQ'S OF IRC APPENDIX F. MECHANICAL VENTILATION AT A MIN. RATE OF 1 CFM PER 50 SQ FT.

SYMBOL LEGEND

SEE TITLE SHEET A0.0 FOR COMPLETE SYMBOL INDEX.

STRUCTURAL PLAN


TOW 119.12' TOP OF WALL ELEVATION

WALL ABOVE NEW DIAGRAMMATIC FOUNDATION WALL & FOOTING. VERIFY SIZE WITH STRUCTURAL. NEW SLAB ON GRADE POST AND PLINTH - VERIFY SIZE AND TYPE WITH

DATE: 5/28/2024

PLOT SCALE: 1:1

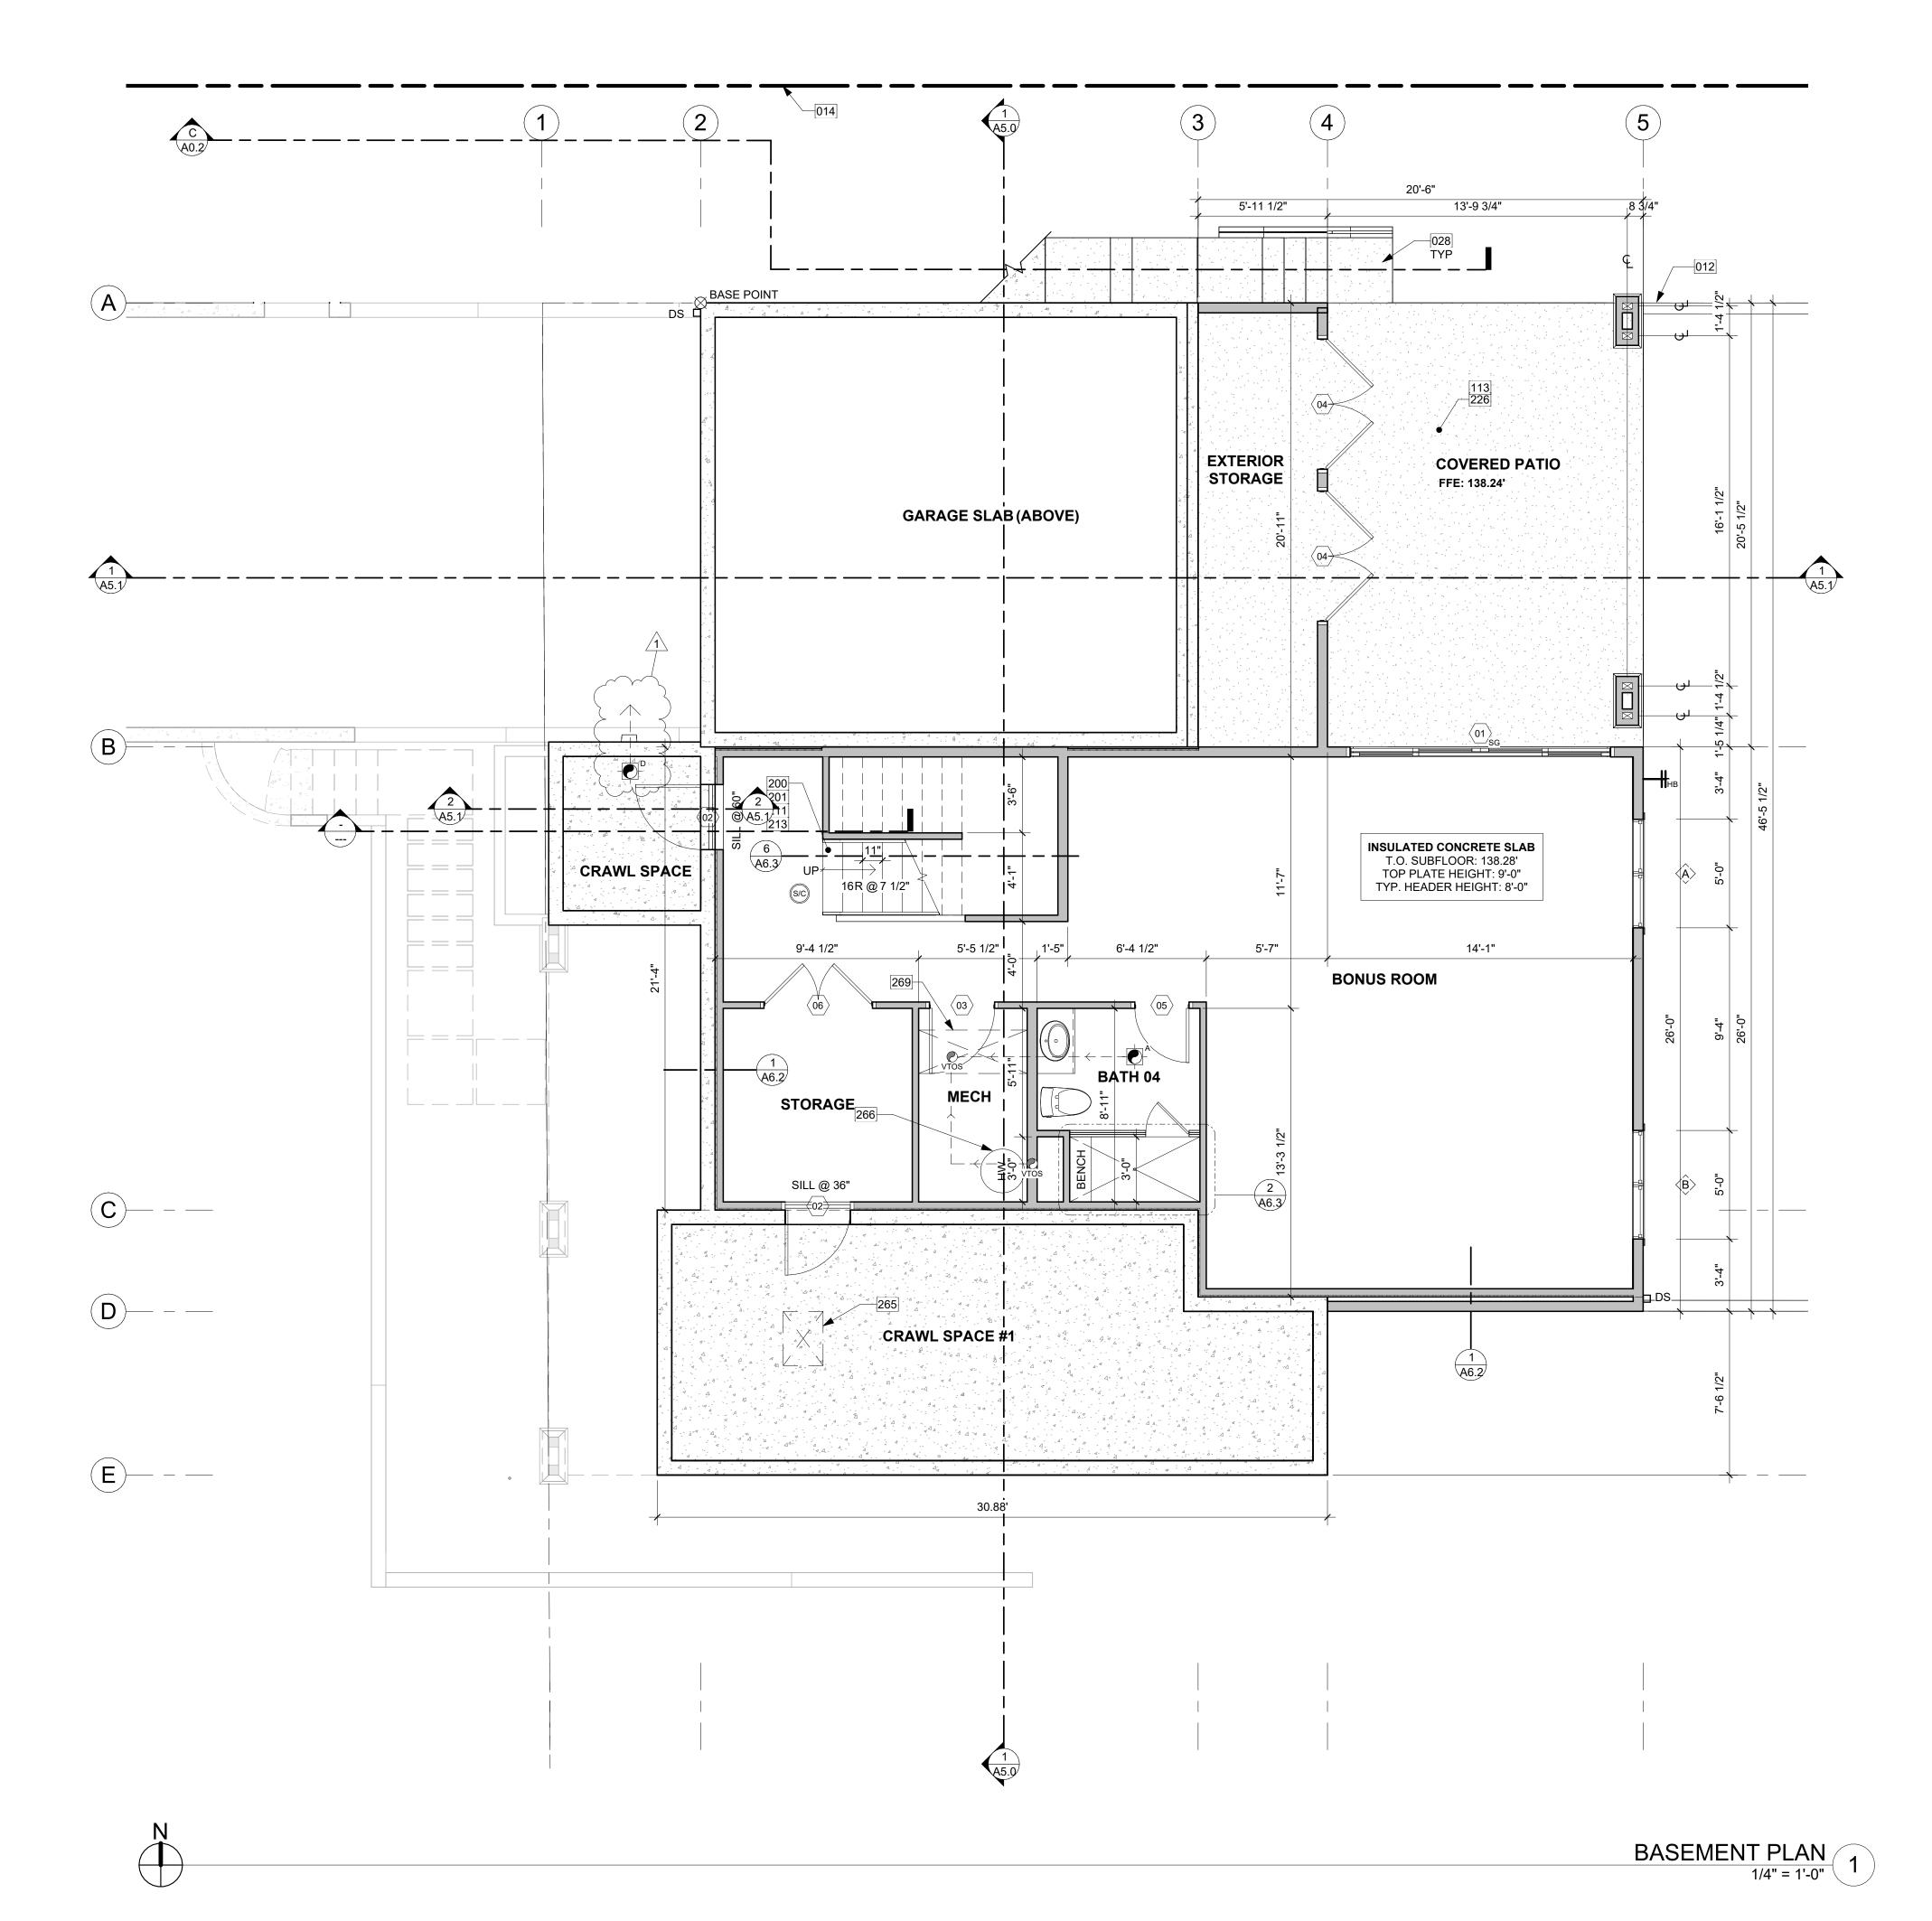PROJECT No.: A22 087



012 SETBACK LINE 014 PROPOSED PROPERTY LINE IN BLA PERMIT, SEE PERMIT 2LLA 23001. 028 HARDSCAPE STEPS DRAWN DIAGRAMATICALLY; TO FOLLOW SITE CONTOURS PROVIDE HANDRAILINGS TO ANY PORTION OF EXTERNAL STAIRS THAT EXCEED 4 RISERS.

CONCRETE SLAB (4" MIN. OR PER STRUCTURAL) OVER GRAVEL OR CRUSHED ROCK (4" MIN. OR PER GEOTECH) OVER FIRM UNDISTURBED SOIL. REINFORCING PER STRUCTURAL. EXTERIOR SLABS TO RECEIVE BROOM FINISH AND TO SLOPE 1/4" PER FOOT AWAY FROM BUILDING.

PROVIDE INTERIOR STAIRWAY ILLUMINATION PER IRC SECTION R303.7. STAIRWAYS SHALL BE PROVIDED WITH AN ARTIFICIAL LIGHT SOURCE TO ILLUMINATE THE LANDINGS AND TREADS. THE LIGHT SOURCE SHALL BE CAPABLE OF ILLUMINATION LEVELS NOT LESS THAN 1 FOOT-CANDLE (11 LUX) AS MEASURED AT THE CENTER OF TREADS AND LANDINGS.

WOOD STAIR W/ TREADS AND RISERS CONFORMING TO IRC R311.7.5. SEE STRUCTURAL DRAWINGS FOR FRAMING AND CONNECTIONS. HANDRAIL, WALL MOUNT. PER R311.7.8.2, HANDRAILS SHALL NOT PROJECT MORE THAN 4-1/2" ON EITHER SIDE OF THE STAIRWAY. PER R311.7.8.1, HANDRAILS HEIGHT MEASURED VERTICALLY FROM THE SLOPED PLANE ADJOINING THE TREAD NOSING OR FINISH SURFACE OF RAMP SLOPE, SHALL

BE MIN. 34" AND MAX. 38". GUARDRAIL, TOP OF WALL MOUNT - DEFERRED SUBMITTAL. MIN. HEIGHT 36" PER IRC SECTION R312.1.2. REQUIRED GUARDS SHALL NOT HAVE OPENINGS FROM THE WALKING SURFACE TO THE REQUIRED GUARD HEIGHT WHICH ALLOW PASSAGE OF A SPHERE 4" IN DIAM. IRC SECTION R312.1.3 EXCEPTIONS: 1) THE TRIANGULAR OPENINGS AT THE OPEN SIDE OF STAIR, FORMED BY RISER, TREAD AND BOTTOM RAIL OF A GUARD, SHALL NOT ALLOW PASSAGE OF A SPHERE OF 6" IN DIAM. 2) GUARDS ON THE OPEN SIDE OF STAIRS SHALL NOT HAVE OPENINGS WHICH ALLOW PASSAGE OF A SPHERE 4-3/8" IN DIAM. PER TABLE R301.5 MINIMUM UNIFORMLY DISTRIBUTED LIVE LOADS - GUARDRAIL AND HANDRAIL 200 PER SQUARE FOOT.

CONNECTIONS PER STRUCTURAL TYPICAL GUARDRAIL DETAILS. TOP OF EXTERIOR SURFACE TO BE 1/2" LOWER THAN THE INTERIOR FLOOR. TYP. PER R311.3.1, FINISH FLOOR AT REQUIRED EGRESS DOORS SHALL BE NOT MORE THAN 1-1/2" LOWER THAN THE TOP OF THE THRESHOLD EXCEPT AT EXTERIOR LOCATION WHICH SHALL BE NOT MORE THAN 7-3/4" BELOW THE TOP OF THE THRESHOLD.

PLENUM ACCESS: MIN. 22"x30" PER IRC SECTION R807.1 ENERGY STAR RATED GAS WATER HEATER WITH MINIMUM UEF OF 0.91.

PROVIDE WHOLE HOUSE VENTILATION PER M1505.4 USING LAUNDRY ROOM

EXHAUST FAN PER 1505.4.1.2 (WA) AND TABLE 1505.4.3(1) & (3) (WA); PROVIDE

ROOM PER M1503.6**

(CONTINUOUS)

PROVIDE SOLID BLOCKING OVER SUPPORTS.

DOOR JAMB 4.5" FROM CORNER TYP., U.N.O.

EXTERIOR WALLS TO BE 2x6 STUDS @ 16" O.C., U.N.O.

• SHALL BE 110V INTERCONNECTED W/ BATTERY BACKUP. • SHALL SOUND AN ALARM AUDIBLE IN ALL SLEEPING ROOMS. • SHALL BE INSTALLED ON EACH FLOOR AND IN ALL BEDROOMS. • SHALL BE INSTALLED IN EACH LOCATION WHERE THERE IS A CEILING

LIMITING DEVICE FOR TUBS TO PROVIDE MAX. 120°F HOT WATER

FOOTINGS SHALL BEAR ON SOLID UNDISTURBED EARTH (CONTROLLED, COMPACTED STRUCTURAL FILL OR BOTH). DEPTH OF FOOTINGS TO BE DETERMINED BY STRUCTURAL ENGINEER. FOUNDATION EXCAVATION, BACKFILL AND COMPACTION SHALL CONFORM TO SPECIFICATION REQUIREMENTS. THIS CONSTRUCTION WORK, INCLUDING DRAINAGE, SHORING AND SUCH OTHER RELATED WORK AS REQUIRED, SHALL BE CONDUCTED BY THE CONTRACTOR. STOP WORK IF RECOMMENDED EXCAVATION CUT OR BEARING SOIL CHANGES OCCUR IN EITHER HORIZONTAL OR VERTICAL DIRECTION AND NOTIFY IMMEDIATELY THE

GEOTECHNICAL ENGINEER AND STRUCTURAL ENGINEER. AT WHICH POINT THE ENGINEERS SHALL DETERMINE CAUSE OF DISPLACEMENT AND

DRAWINGS, ALSO SEE MANUFACTURER'S SPECS.

DEVELOP AND IMPLEMENT REMEDIAL MEASURES.

SMOKE & CARBON MONOXIDE DETECTORS:

CHANGE OF GREATER THAN 24"

TEMPERATURE.

CONTROLS PER 1505.4.2. COMPLÝ WITH WSEC R403.6. BÁSEMENT ÉXHAUST FAN TO

BATH & MINIMUM LOCAL EXHAUST RATE TO BE 50 CFM

KITCHEN MINIMUM LOCAL EXHAUST RATE TO BE 100 CFM

DRAFT EXHAUST FAN, PER M1503.2

UNVENTED MINIMUM LOCAL EXHAUST RATE TO BE 1 CFM

** MAKEUP AIR IS NOT REQUIRED IF ALL GAS APPLIANCES IN THE HOUSE HAVE A DIRECT VENT OR MECHANICAL DRAFT VENT SYSTEM, PER MODIFICATION M1503.6.

CONTRACTOR SHALL VERIFY ALL NOTES, DIMENSIONS & CONDITIONS

SEE STRUCTURAL DRAWINGS FOR ALL POSTS, BEAMS AND HEADERS.

SEE SHEETS A0.3, A4.0 & A4.1 FOR WINDOW & DOOR HEADER HEIGHTS

ALL WOOD IN CONTACT WITH CONCRETE TO BE PRESSURE TREATED.

INSTALL SIMPSON CONC. TO WOOD HOLDOWNS PER STRUCTURAL

PROVIDE FIRE BLOCKING @ ALL PLUMBING PENETRATIONS.

WINDOWS & DOORS ARE SHOWN & NOTED AS NOMINAL SIZES.

LAUNDRY MIN. 210 CFM (INTERMITTENT) - TO FUNCTION AND BE LABELED AS WHOLE HOUSE FAN (4-5 BEDROOMS

(INTERMITTENT) PROVIDED BY RANGE HOOD OR DOWN

IF OVER 400 CFM, MAKEUP AIR IS REQUIRED IN THE SAME

4501<6000 SF) TO OPERATE 50% OF TIME IN EACH 4-HOUR

DASHED LINE OF MECHANICAL CHASE ABOVE.

HOUSE VENTILATION

SYMBOL LOCATION MINIMUM FAN REQUIREMENTS

POWDER (INTERMITTENT)

COMPLY WITH WSRC R408.3.

CRAWL

FLOOR PLAN NOTES

PRIOR TO CONSTRUCTION.

ABOVE FINISHED FLOOR.

SPACE


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PROJECT / CLIENT:

2436 74TH AVE SE - SFR

LNL BUILDS

PROJECT ADDRESS: 2436 74TH AVE SE MERCER ISLAND, 98040

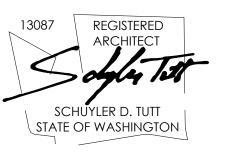DRAWING NAME:

BASEMENT PLAN

DRAWN BY: DRA CHECKED BY: JML

PHASE:

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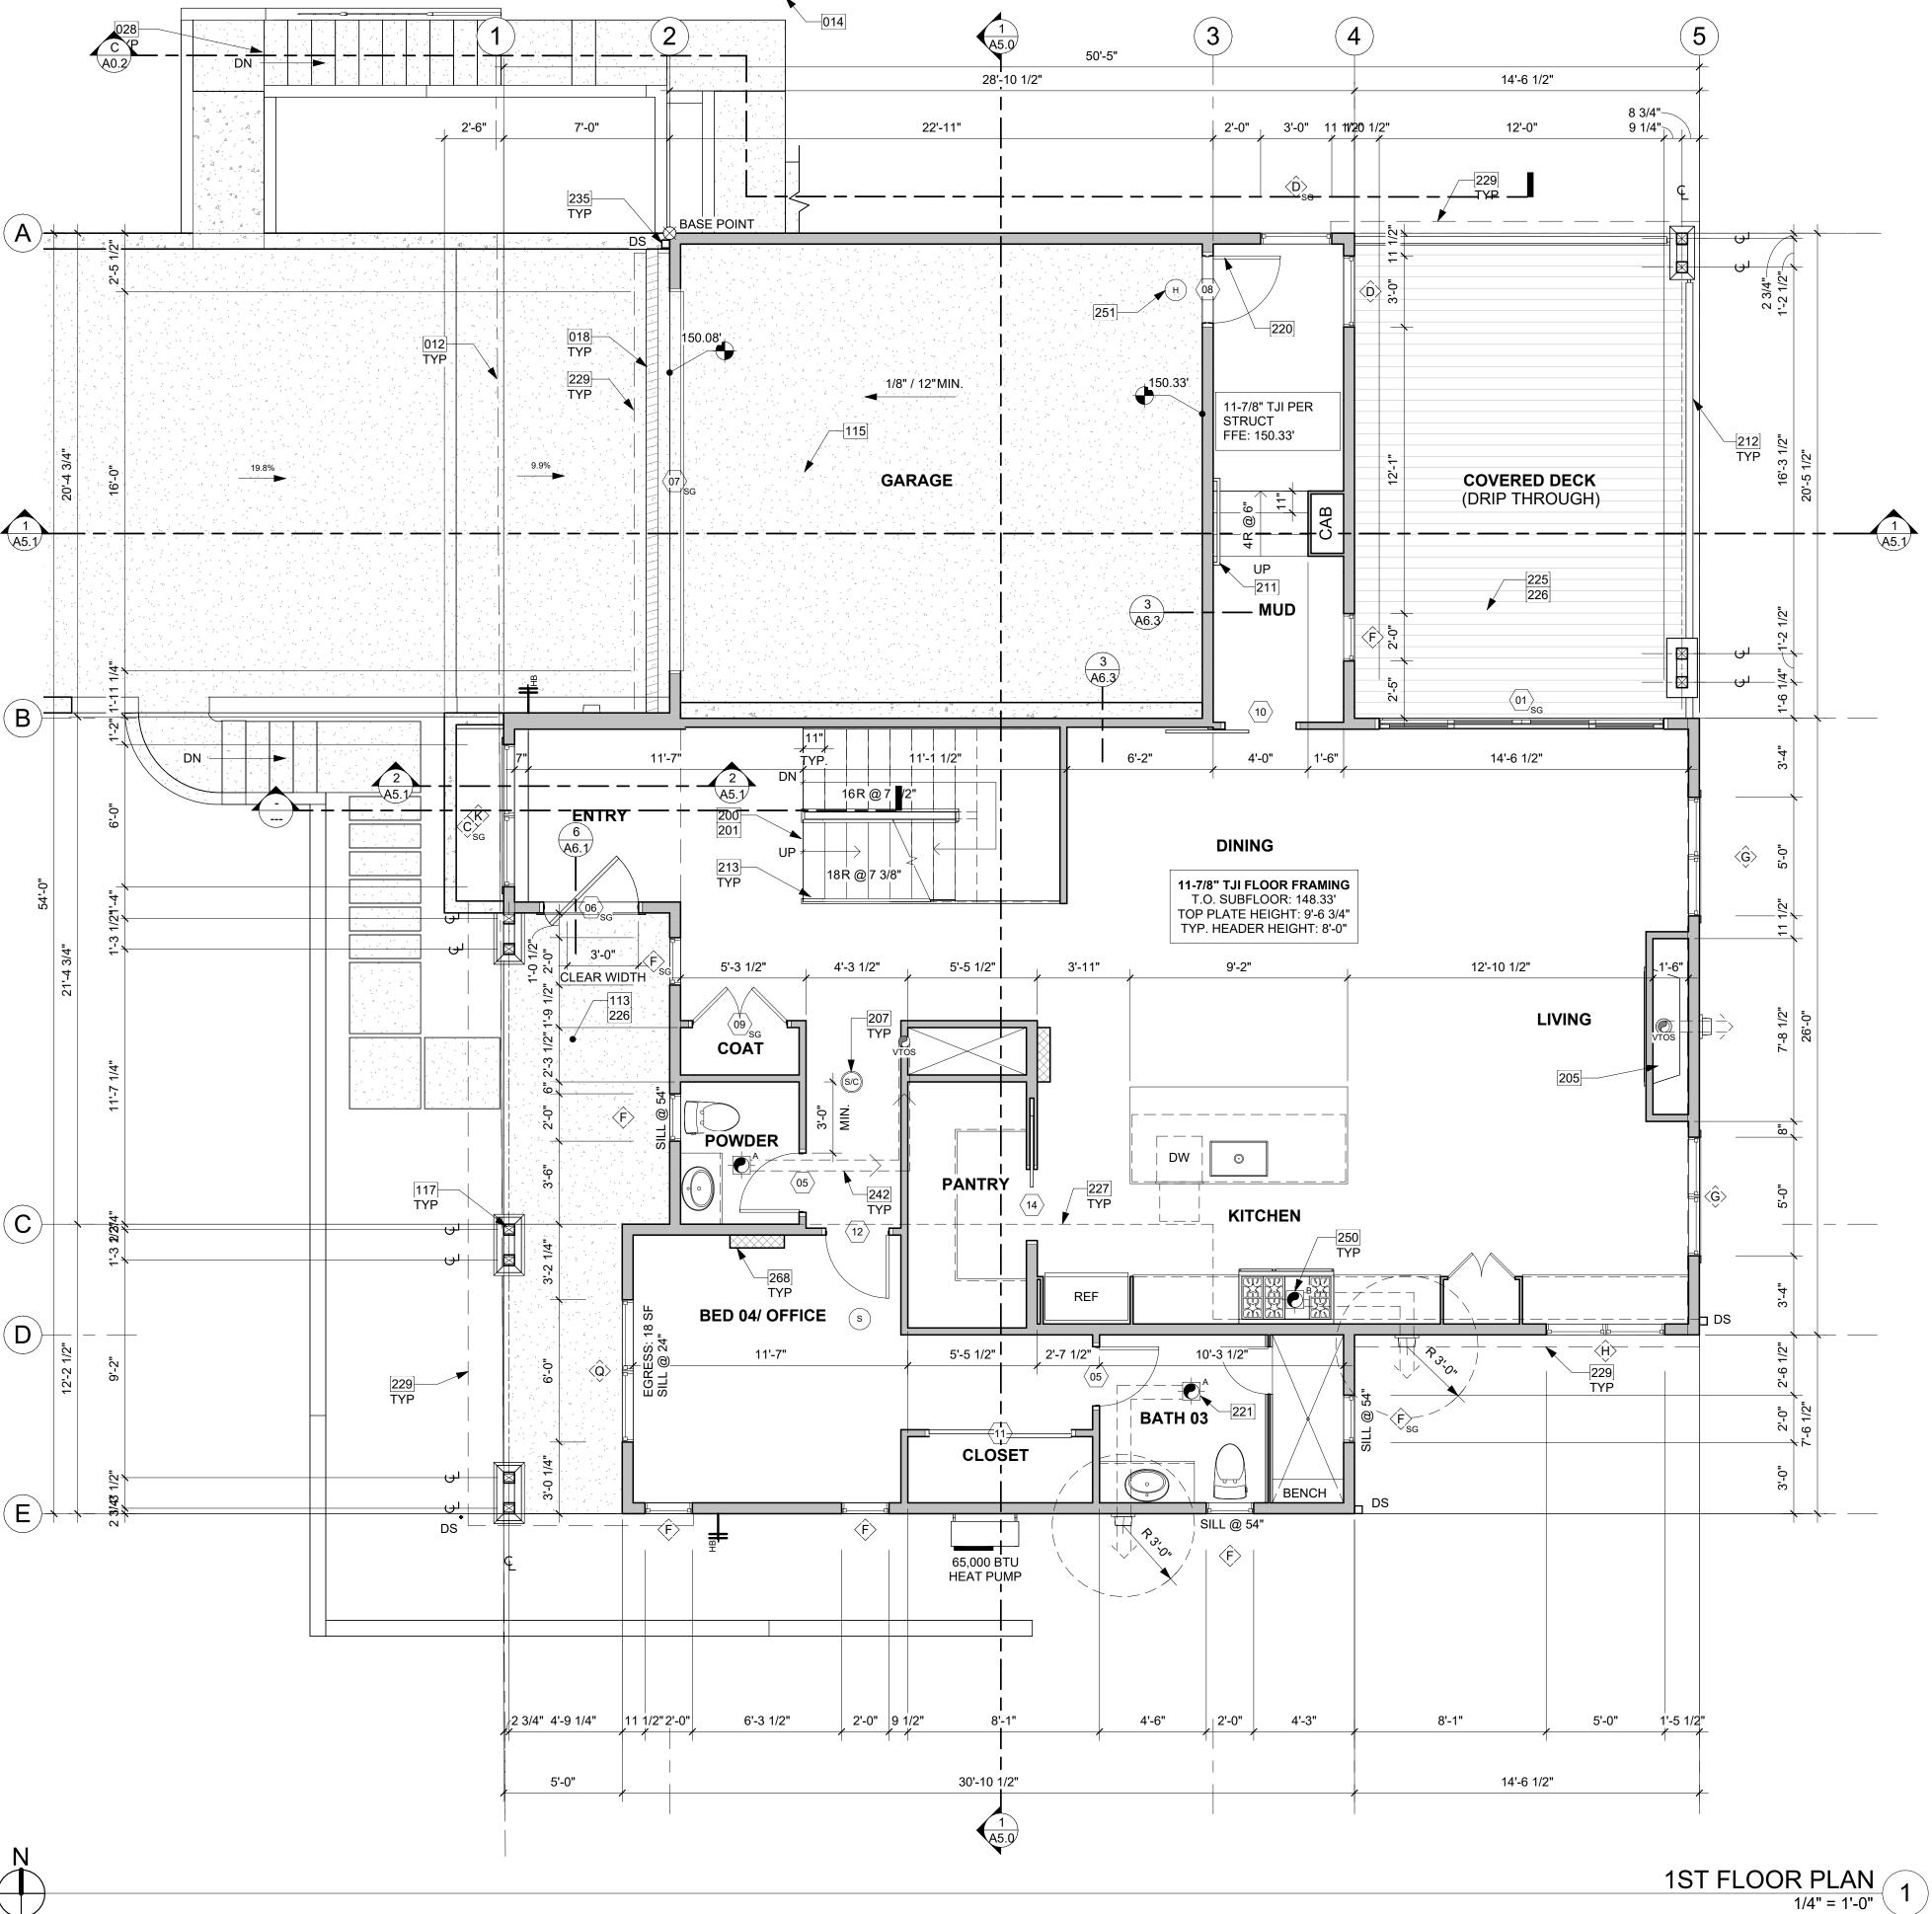
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PROJECT No.: A22 087 DATE: 5/28/2024

PLOT SCALE: 1:1

SYMBOL LEGEND

SEE TITLE SHEET A0.0 FOR COMPLETE SYMBOL INDEX.



012	SETBACK LINE
014	PROPOSED PROPERTY LINE IN BLA PERMIT, SEE PERMIT 2LLA_23001.
018	TRENCH DRAIN: SEE DETAILS AND CIVIL.
028	HARDSCAPE STEPS DRAWN DIAGRAMATICALLY; TO FOLLOW SITE CONTOURS. PROVIDE HANDRAILINGS TO ANY PORTION OF EXTERNAL STAIRS THAT EXCEED 4 RISERS.
113	CONCRETE SLAB (4" MIN. OR PER STRUCTURAL) OVER GRAVEL OR CRUSHED ROCK (4" MIN. OR PER GEOTECH) OVER FIRM UNDISTURBED SOIL. REINFORCING PER STRUCTURAL. EXTERIOR SLABS TO RECEIVE BROOM FINISH AND TO SLOPE 1/4" PER FOOT AWAY FROM BUILDING.
115	CONCRETE SLAB (4" MIN. OR PER STRUCTURAL) OVER GRAVEL OR CRUSHED ROCK (4" MIN. OR PER GEOTECH) OVER FIRM UNDISTURBED SOIL. REINFORCING PER STRUCTURAL.
117	POSTS AND FOOTING PER STRUCTURAL.
200	PROVIDE INTERIOR STAIRWAY ILLUMINATION PER IRC

- SECTION R303.7. STAIRWAYS SHALL BE PROVIDED WITH AN ARTIFICIAL LIGHT SOURCE TO ILLUMINATE THE LANDINGS AND TREADS. THE LIGHT SOURCE SHALL BE CAPABLE OF ILLUMINATION LEVELS NOT LESS THAN 1 FOOT-CANDLE (11 LUX) AS MEASURED AT THE CENTER OF TREADS AND LANDINGS.
- WOOD STAIR W/ TREADS AND RISERS CONFORMING TO IRC R311.7.5. SEE STRUCTURAL DRAWINGS FOR FRAMING AND CONNECTIONS.
- GAS FIREPLACE: DIRECT VENT THROUGH WALL OR ROOF PER MANUFACTURER'S REQUIREMENTS. PER OWNER'S SELECTED UNIT, PER IRC SECTION R1004.2, FACTORY BUILT HEARTH EXTENTIONS FOR APPROVED FACTORY-BUILT FIREPLACES SHALL BE INSTALLED IN ACCORDANCE WITH THE LISTING OF THE FIREPLACE. THE HEARTH EXTENTION SHALL BE READILY DISTINGUISHABLE FROM THE SURROUNDING GLOOR AREA. FRAMING CLEARANCES PER OWNER'S SELECTED UNIT.
- SMOKE ALARM PER IRC SECTION R314.1 AND COMBINATION SMOKE & CARBON MONOXIDE ALARMS PER IRC SECTION R314.5. SHALL BE INSTALLED >3' FROM THE DOOR OF A BATHROOM THAT CONTAINS A BATHTUB OR SHOWER. IONIZATION SMOKE ALARMS SHALL NOT BE INSTALLED LESS THAN 20' HORIZONTALLY FROM A PERMANENTLY INSTALLED COOKING APPLIANCE.

KEY NOTES

211	HANDRAIL, WALL MOUNT. PER R311.7.8.2, HANDRAILS SHALL NOT PROJECT MORE THAN 4-1/2" ON EITHER SIDE OF THE STAIRWAY. PER R311.7.8.1, HANDRAILS HEIGHT MEASURED VERTICALLY FROM THE SLOPED PLANE ADJOINING THE TREAD NOSING OR FINISH SURFACE OF RAMP SLOPE, SHALL BE MIN. 34" AND MAX. 38".
212	GUARDRAIL, FASCIA MOUNT - DEFERRED SUBMITTAL. MIN. HEIGHT 36" PER IRC SECTION R312.1.2. REQUIRED GUARDS SHALL NOT HAVE OPENINGS FROM THE WALKING SURFACE TO THE REQUIRED GUARD HEIGHT WHICH ALLOW PASSAGE OF A SPHERE 4" IN DIAM. IRC SECTION R312.1.3 EXCEPTIONS: 1) THE TRIANGULAR OPENINGS AT THE OPEN SIDE OF STAIR, FORMED BY RISER, TREAD AND BOTTOM RAIL OF A GUARD, SHALL NOT ALLOW PASSAGE OF A SPHERE OF 6" IN DIAM. 2) GUARDS ON THE OPEN SIDE OF STAIRS SHALL NOT HAVE OPENINGS WHICH ALLOW PASSAGE OF A SPHERE 4-3/8" IN DIAM. PER TABLE R301.5 MINIMUM UNIFORMLY DISTRIBUTED LIVE LOADS - GUARDRAIL AND HANDRAIL 200 PER SQUARE FOOT. CONNECTIONS PER STRUCTURAL TYPICAL GUARDRAIL DETAILS.
213	GUARDRAIL, TOP OF WALL MOUNT - DEFERRED SUBMITTAL. MIN. HEIGHT 36" PER IRC SECTION R312.1.2. REQUIRED GUARDS SHALL NOT HAVE OPENINGS FROM THE WALKING SURFACE TO THE REQUIRED GUARD HEIGHT WHICH ALLOW PASSAGE OF A SPHERE 4" IN DIAM. IRC SECTION R312.1.3 EXCEPTIONS: 1) THE TRIANGULAR OPENINGS AT THE OPEN SIDE OF STAIR, FORMED BY RISER, TREAD AND BOTTOM RAIL OF A GUARD, SHALL NOT ALLOW PASSAGE OF A SPHERE OF 6" IN DIAM. 2) GUARDS ON

PASSAGE OF A SPHERE OF 6" IN DIAM. 2) GUARDS ON THE OPEN SIDE OF STAIRS SHALL NOT HAVE OPENINGS WHICH ALLOW PASSAGE OF A SPHERE 4-3/8" IN DIAM. PER TABLE R301.5 MINIMUM UNIFORMLY DISTRIBUTED LIVE LOADS - GUARDRAIL AND HANDRAIL 200 PER SQUARE FOOT. CONNECTIONS PER STRUCTURAL TYPICAL GUARDRAIL DETAILS.

220	20 MIN. FIRE RATED DOOR W/ SELF CLOSER. INSULATED.
221	BATH FAN VENT THROUGH WALL PER MANUFACTUREF REQUIREMENTS.
225	PT DECK FRAMING PER STRUCTURAL W/ 2x CEDAR DECKING. MAINTAIN 1/8" GAP BETWEEN DECKING MEMBERS.
226	TOP OF EXTERIOR SURFACE TO BE 1/2" LOWER THAN THE INTERIOR FLOOR, TYP. PER R311.3.1, FINISH FLOOR AT REQUIRED EGRESS DOORS SHALL BE NOT MORE THAN 1-1/2" LOWER THAN THE TOP OF THE THRESHOLD EXCEPT AT EXTERIOR LOCATION WHICH

SHALL BE NOT MORE THAN 7-3/4" BELOW THE TOP OF THE THRESHOLD. SHORT DASHED LINE OF BUILDING BELOW. 229 LONG DASHED LINE OF ROOF ABOVE. 235 3" SQUARE DOWNSPOUT. TIGHTLINE ALL DOWNSPOUTS TO STORMWATER SYSTEM PER CIVIL ENGINEERING DRAWINGS, TYP.

242 MECHANICAL DUCTING COOKTOP FAN VENT THROUGH WALL PER MANUFACTURER REQUIREMENTS.

HEAT DETECTOR INSTALLED IN GARAGE PER IRC SECTION R314.2.3 AND INTERCONNECTED PER HATCHED REGION SHOWS MINI-SPLIT HEAD, TO BE

INSTALLED IN ALL LIVING AREAS.

HOUSE VENTILATION

PROVIDE WHOLE HOUSE VENTILATION PER M1505.4 USING LAUNDRY ROOM EXHAUST FAN PER 1505.4.1.2 (WA) AND TABLE 1505.4.3(1) & (3) (WA); PROVIDE CONTROLS PER 1505.4.2. COMPLY WITH WSEC R403.6. BASEMENT EXHAUST FAN TO

COMPLY WITH WSRC R408.3.			
SYMBOL	LOCATION	MINIMUM FAN REQUIREMENTS	
-A	BATH & POWDER	MINIMUM LOCAL EXHAUST RATE TO BE 50 CFM (INTERMITTENT)	
B	KITCHEN	MINIMUM LOCAL EXHAUST RATE TO BE 100 CFM (INTERMITTENT) PROVIDED BY RANGE HOOD OR DOWN DRAFT EXHAUST FAN, PER M1503.2 IF OVER 400 CFM, MAKEUP AIR IS REQUIRED IN THE SAME ROOM PER M1503.6**	
	LAUNDRY ROOM	MIN. 210 CFM (INTERMITTENT) - TO FUNCTION AND BE LABELED AS WHOLE HOUSE FAN (4-5 BEDROOMS 4501<6000 SF) TO OPERATE 50% OF TIME IN EACH 4-HOUR SEGMENT.	
-DD	UNVENTED CRAWL SPACE	MINIMUM LOCAL EXHAUST RATE TO BE 1 CFM (CONTINUOUS)	

** MAKEUP AIR IS NOT REQUIRED IF ALL GAS APPLIANCES IN THE HOUSE HAVE A DIRECT VENT OR MECHANICAL DRAFT VENT SYSTEM, PER MODIFICATION M1503.6.

FLOOR PLAN NOTES

- CONTRACTOR SHALL VERIFY ALL NOTES, DIMENSIONS & CONDITIONS PRIOR TO CONSTRUCTION.
- SEE STRUCTURAL DRAWINGS FOR ALL POSTS, BEAMS AND HEADERS. PROVIDE SOLID BLOCKING OVER SUPPORTS.
- PROVIDE FIRE BLOCKING @ ALL PLUMBING PENETRATIONS. WINDOWS & DOORS ARE SHOWN & NOTED AS NOMINAL SIZES.

DOOR JAMB 4.5" FROM CORNER TYP., U.N.O.

- SEE SHEETS A0.3, A4.0 & A4.1 FOR WINDOW & DOOR HEADER HEIGHTS ABOVE FINISHED FLOOR.
- ALL WOOD IN CONTACT WITH CONCRETE TO BE PRESSURE TREATED. EXTERIOR WALLS TO BE 2x6 STUDS @ 16" O.C., U.N.O.
- INSTALL SIMPSON CONC. TO WOOD HOLDOWNS PER STRUCTURAL DRAWINGS, ALSO SEE MANUFACTURER'S SPECS. SMOKE & CARBON MONOXIDE DETECTORS: • SHALL BE 110V INTERCONNECTED W/ BATTERY BACKUP.
- SHALL SOUND AN ALARM AUDIBLE IN ALL SLEEPING ROOMS. • SHALL BE INSTALLED ON EACH FLOOR AND IN ALL BEDROOMS. • SHALL BE INSTALLED IN EACH LOCATION WHERE THERE IS A CEILING CHANGE OF GREATER THAN 24"
- LIMITING DEVICE FOR TUBS TO PROVIDE MAX. 120°F HOT WATER
- FOOTINGS SHALL BEAR ON SOLID UNDISTURBED EARTH (CONTROLLED, COMPACTED STRUCTURAL FILL OR BOTH). DEPTH OF FOOTINGS TO BE DETERMINED BY STRUCTURAL ENGINEER. FOUNDATION EXCAVATION, BACKFILL AND COMPACTION SHALL CONFORM TO SPECIFICATION REQUIREMENTS. THIS CONSTRUCTION WORK, INCLUDING DRAINAGE, SHORING AND SUCH OTHER RELATED WORK AS REQUIRED, SHALL BE CONDUCTED BY THE CONTRACTOR. STOP WORK IF RECOMMENDED EXCAVATION CUT OR BEARING SOIL CHANGES OCCUR IN EITHER HORIZONTAL OR VERTICAL DIRECTION AND NOTIFY IMMEDIATELY THE GEOTECHNICAL ENGINEER AND STRUCTURAL ENGINEER. AT WHICH POINT THE ENGINEERS SHALL DETERMINE CAUSE OF DISPLACEMENT AND DEVELOP AND IMPLEMENT REMEDIAL MEASURES.

MEDICI ARCHITECTS

200 W. RIVER ST.

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9/28/2023


SUITE 301

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PROJECT / CLIENT:

2436 74TH AVE SE - SFR

LNL BUILDS

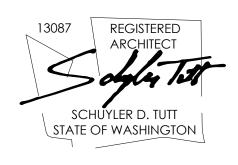PROJECT ADDRESS: 2436 74TH AVE SE MERCER ISLAND, 98040

DRAWING NAME:

1ST FLOOR PLAN

DRAWN BY: DRA

CHECKED BY: JML

PHASE:

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PROJECT No.: A22 087 DATE: 5/28/2024

PLOT SCALE: 1:1

SYMBOL LEGEND

SEE TITLE SHEET A0.0 FOR COMPLETE SYMBOL INDEX.



KEY NOTES 012 SETBACK LINE 014 PROPOSED PROPERTY LINE IN BLA PERMIT, SEE PERMIT 2LLA_23001. 200 PROVIDE INTERIOR STAIRWAY ILLUMINATION PER IRC SECTION R303.7. STAIRWAYS SHALL BE PROVIDED WITH AN ARTIFICIAL LIGHT SOURCE TO ILLUMINATE THE LANDINGS AND TREADS. THE LIGHT SOURCE SHALL BE CAPABLE OF ILLUMINATION LEVELS NOT LESS THAN 1 FOOT-CANDLE (11 LUX) AS MEASURED AT THE CENTER OF TREADS AND LANDINGS. WOOD STAIR W/ TREADS AND RISERS CONFORMING TO IRC R311.7.5. SEE STRUCTURAL DRAWINGS FOR FRAMING AND CONNECTIONS. A PROGRAMMABLE ELECTRONIC TIMER SWITCH OPERATES AN EXHAUST FAN FOR INTERMITTENT VENTILATION. MUST OPERATE AT LEAST 50% OF TIME IN EACH 4 HOUR SEGMENT PER IRC TABLE M1505.4.3(1) AND (3) SMOKE ALARM PER IRC SECTION R314.1 AND COMBINATION SMOKE & CARBON MONOXIDE ALARMS PER IRC SECTION R314.5. SHALL BE INSTALLED >3' FROM THE DOOR OF A BATHROOM THAT CONTAINS A BATHTUB OR SHOWER. IONIZATION SMOKE ALARMS SHALL NOT BE INSTALLED LESS THAN 20' HORIZONTALLY FROM A PERMANENTLY INSTALLED COOKING APPLIANCE. HANDRAIL, WALL MOUNT. PER R311.7.8.2, HANDRAILS SHALL NOT PROJECT MORE THAN 4-1/2" ON EITHER SIDE OF THE STAIRWAY. PER R311.7.8.1, HANDRAILS HEIGHT MEASURED VERTICALLY FROM THE SLOPED PLANE ADJOINING THE TREAD NOSING OR FINISH SURFACE OF RAMP SLOPE, SHALL BE MIN. 34" AND MAX. 38". GUARDRAIL, TOP OF WALL MOUNT - DEFERRED SUBMITTAL. MIN. HEIGHT 36" PER IRC SECTION R312.1.2. REQUIRED GUARDS SHALL NOT HAVE OPENINGS FROM THE WALKING SURFACE TO THE REQUIRED GUARD HEIGHT WHICH ALLOW PASSAGE OF A SPHERE 4" IN DIAM. IRC SECTION R312.1.3 EXCEPTIONS: 1) THE TRIANGULAR OPENINGS AT THE OPEN SIDE OF STAIR, FORMED BY RISER, TREAD AND BOTTOM RAIL OF A GUARD, SHALL NOT ALLOW PASSAGE OF A SPHERE OF 6" IN DIAM. 2) GUARDS ON THE OPEN SIDE OF STAIRS SHALL NOT HAVE OPENINGS WHICH ALLOW PASSAGE OF A SPHERE 4-3/8" IN DIAM. PER TABLE R301.5 MINIMUM UNIFORMLY DISTRIBUTED LIVE LOADS - GUARDRAIL AND HANDRAIL 200 PER SQUARE FOOT. CONNECTIONS PER STRUCTURAL TYPICAL GUARDRAIL DETAILS. WASHING AND DRYING MACHINES: PROVIDE FLOOR SAVER PAN WITH A TRAP SEAL PRIMER WHICH IS ACCESSIBLE FOR MAINTENANCE PER UPC 1007.1 UNDER WASHER WITH TIGHTLINE DRAIN TO SANITARY SEWER. PROVIDE DRYER BOX IN WALL FOR DRYER VENT TO PREVENT COMPROMISING DUCTWORK. VENT THROUGH ROOF. HTTP://WWW/FLOODSAVER.COM 219 SAFETY GLASS.

LONG DASHED LINE OF ROOF ABOVE.

3" SQUARE DOWNSPOUT. TIGHTLINE ALL DOWNSPOUTS TO STORMWATER SYSTEM PER CIVIL ENGINEERING DRAWINGS, TYP.

ATTIC ACCESS: MIN. 22"x30" PER IRC SECTION R807.1 DRYER FAN VENT THROUGH ROOF PER MANUFACTURER REQUIREMENTS.

BASEMENT VENTILATION TO GO UP THROUGH MECHANICAL CHASE AND VENT OUT THROUGH ROOF. HATCHED REGION SHOWS MINI-SPLIT HEAD, TO BE INSTALLED IN ALL LIVING

FAN VENT THROUGH ROOF PER MANUFACTURER REQUIREMENTS.

3" GUTTER W/ SQUARE DOWNSPOUT. POWDER COATED COLOR TBD. TIGHTLINE ALL DOWNSPOUTS TO STORMWATER SYSTEM PER CIVIL ENGINEERING DRAWINGS, TYP.

PROVIDE WHOLE HOUSE VENTILATION PER M1505.4 USING LAUNDRY ROOM EXHAUST FAN PER 1505.4.1.2 (WA) AND TABLE 1505.4.3(1) & (3) (WA): PROVIDE

ROOM PER M1503.6**

(CONTINUOUS)

PROVIDE SOLID BLOCKING OVER SUPPORTS.

DOOR JAMB 4.5" FROM CORNER TYP., U.N.O.

CONTROLS PER 1505.4.2. COMPLY WITH WSEC R403.6. BASEMENT EXHAUST FAN TO

BATH & MINIMUM LOCAL EXHAUST RATE TO BE 50 CFM

DRAFT EXHAUST FAN. PER M1503.2

UNVENTED | MINIMUM LOCAL EXHAUST RATE TO BE 1 CFM

** MAKEUP AIR IS NOT REQUIRED IF ALL GAS APPLIANCES IN THE HOUSE HAVE A DIRECT VENT OR MECHANICAL DRAFT VENT SYSTEM, PER MODIFICATION M1503.6.

CONTRACTOR SHALL VERIFY ALL NOTES, DIMENSIONS & CONDITIONS

SEE STRUCTURAL DRAWINGS FOR ALL POSTS, BEAMS AND HEADERS.

SEE SHEETS A0.3, A4.0 & A4.1 FOR WINDOW & DOOR HEADER HEIGHTS

ALL WOOD IN CONTACT WITH CONCRETE TO BE PRESSURE TREATED.

INSTALL SIMPSON CONC. TO WOOD HOLDOWNS PER STRUCTURAL

• SHALL BE INSTALLED ON EACH FLOOR AND IN ALL BEDROOMS.

LIMITING DEVICE FOR TUBS TO PROVIDE MAX. 120°F HOT WATER

• SHALL BE INSTALLED IN EACH LOCATION WHERE THERE IS A CEILING

FOOTINGS SHALL BEAR ON SOLID UNDISTURBED EARTH (CONTROLLED, COMPACTED STRUCTURAL FILL OR BOTH). DEPTH OF FOOTINGS TO BE DETERMINED BY STRUCTURAL ENGINEER. FOUNDATION EXCAVATION, BACKFILL AND COMPACTION SHALL CONFORM TO SPECIFICATION REQUIREMENTS. THIS CONSTRUCTION WORK, INCLUDING DRAINAGE, SHORING AND SUCH OTHER RELATED WORK AS REQUIRED, SHALL BE

CONDUCTED BY THE CONTRACTOR. STOP WORK IF RECOMMENDED EXCAVATION CUT OR BEARING SOIL CHANGES OCCUR IN EITHER HORIZONTAL OR VERTICAL DIRECTION AND NOTIFY IMMEDIATELY THE GEOTECHNICAL ENGINEER AND STRUCTURAL ENGINEER. AT WHICH POINT THE ENGINEERS SHALL DETERMINE CAUSE OF DISPLACEMENT AND

PROVIDE FIRE BLOCKING @ ALL PLUMBING PENETRATIONS.

EXTERIOR WALLS TO BE 2x6 STUDS @ 16" O.C., U.N.O.

• SHALL BE 110V INTERCONNECTED W/ BATTERY BACKUP. • SHALL SOUND AN ALARM AUDIBLE IN ALL SLEEPING ROOMS.

DRAWINGS, ALSO SEE MANUFACTURER'S SPECS.

DEVELOP AND IMPLEMENT REMEDIAL MEASURES.

SMOKE & CARBON MONOXIDE DETECTORS:

CHANGE OF GREATER THAN 24"

WINDOWS & DOORS ARE SHOWN & NOTED AS NOMINAL SIZES.

LAUNDRY MIN. 210 CFM (INTERMITTENT) - TO FUNCTION AND BE

MINIMUM LOCAL EXHAUST RATE TO BE 100 CFM

LABELED AS WHOLE HOUSE FAN (4-5 BEDROOMS

(INTERMITTENT) PROVIDED BY RANGE HOOD OR DOWN

IF OVER 400 CFM, MAKEUP AIR IS REQUIRED IN THE SAME

4501<6000 SF) TO OPERATE 50% OF TIME IN EACH 4-HOUR

338 HATCHED AREA SHOWS VAULTED CEILING BELOW.

HOUSE VENTILATION

SYMBOL LOCATION MINIMUM FAN REQUIREMENTS

POWDER (INTERMITTENT)

COMPLY WITH WSRC R408.3.

CRAWL

FLOOR PLAN NOTES

PRIOR TO CONSTRUCTION.


ABOVE FINISHED FLOOR.

MEDICI ARCHITECTS

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REGISTRATION:



INTAKE DATE:	9/28/2023
REVISIONS:	DATE:

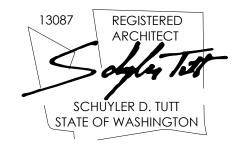PROJECT / CLIENT:

2436 74TH AVE SE - SFR

LNL BUILDS

PROJECT ADDRESS: 2436 74TH AVE SE MERCER ISLAND, 98040

DRAWING NAME:

2ND FLOOR PLAN

DRAWN BY: DRA CHECKED BY: JML

PHASE:

CONSTRUCTION DRAWINGS

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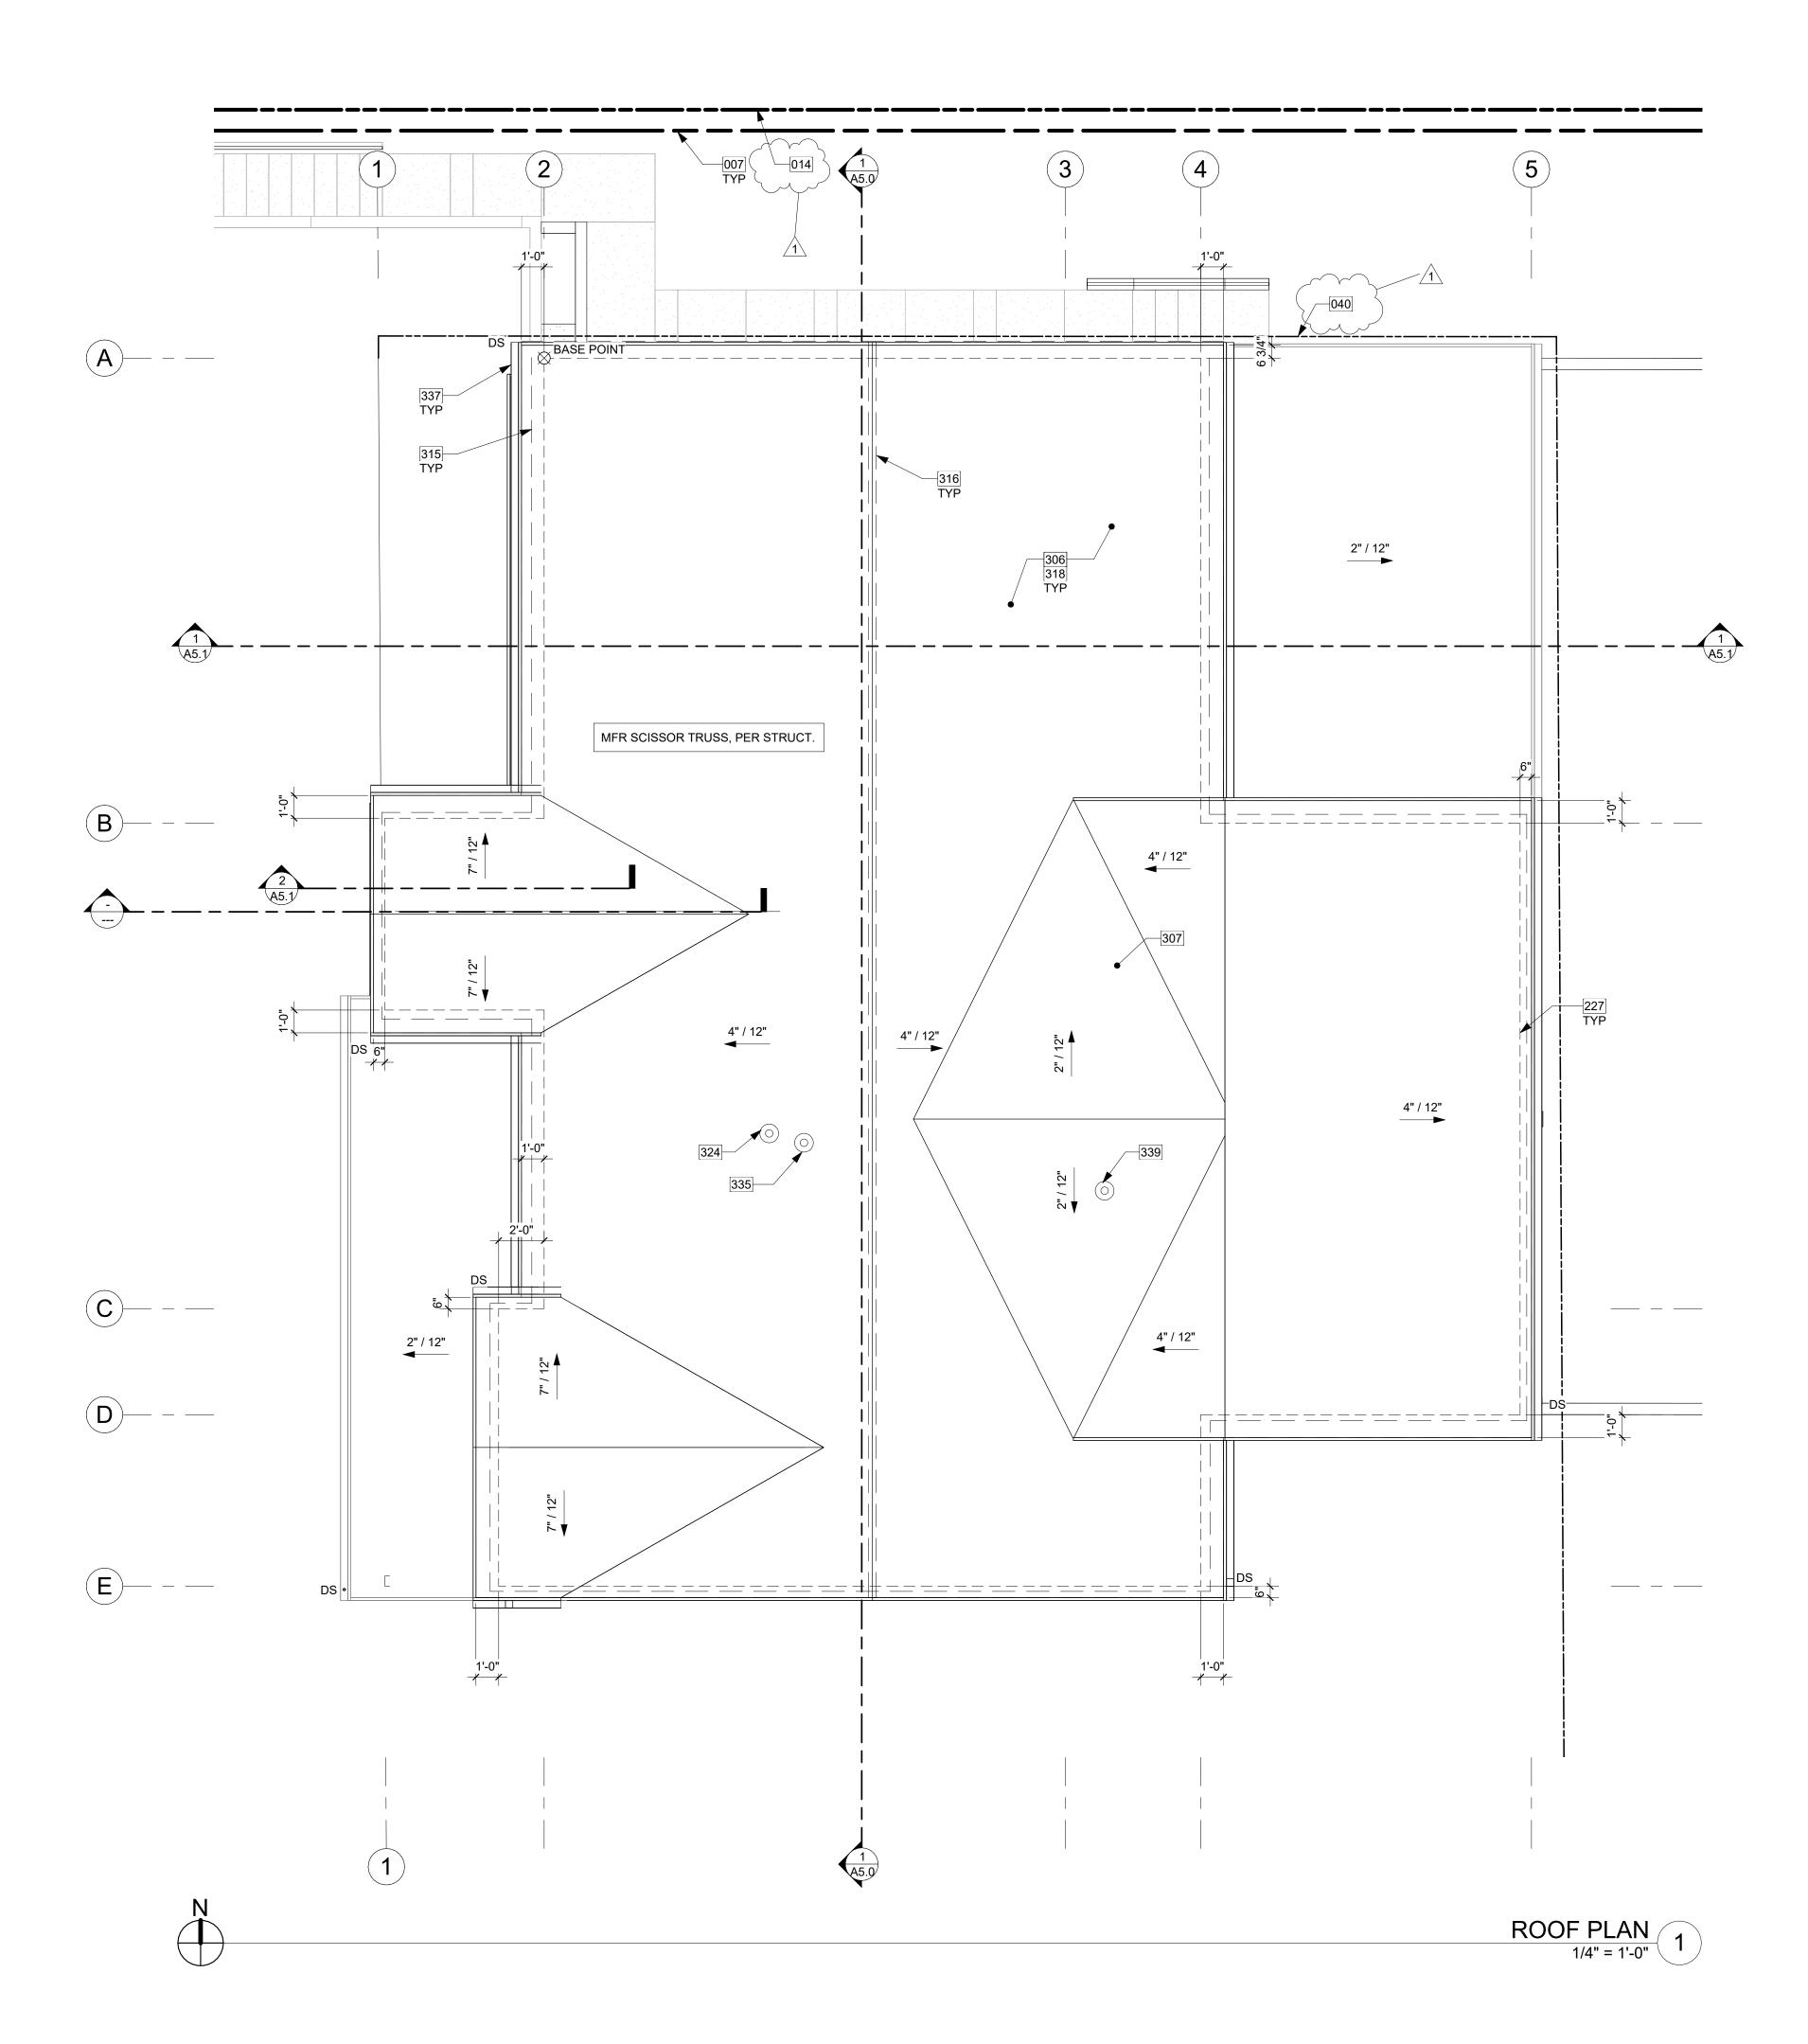
APPROVED FOR CONSTRUCTION:

PROJE	CT No.:	A22 087	
DATE:	5/28/20	24	

PLOT SCALE: 1:1

SYMBOL LEGEND

SEE TITLE SHEET A0.0 FOR COMPLETE SYMBOL INDEX.



007 EXISTING PROPERTY LINE

SYMBOL LEGEND

ROOF VENTILATION

(4) 2-1/2" DIA. HOLES PER 24": | 9.8 SI / LF - 25%

ROOF #1 TOTAL VENTILATION PROVIDED:

ROOF #1 CONSTRUCTION:

PROPOSED VENTILATION:

2" WIDE RIDGE VENT:

ROOF #1 AREA:

PROVIDE:

PROVIDE:

_ _ _ _ _ _

EAVE VENT

BUILDING BELOW

MANUFACTUERED TRUSSES

169.92 LF EAVE VENTILATION = 1248.91 SI

55.23 LF RIDGE VENTILATION = 994.14 SI

= 7.35 SI / LF

= 18 SI / LF

= 2243.05 SI

2178.8 SF

ROOF #1 VENTILATION REQUIRED: (2178.8 SF x 144 SI) / 150* = 2091.65 SI

* PER IRC R806.2, MINIMUM NET FREE VENTILATION AREA SHALL BE 1/150 OF THE AREA. AS AN ALTERNATIVE, THE NET FREE CROSS VENTILATION AREA MAY BE

REDUCED TO 1/300 WHEN BETWEEN 40-50% OF REQUIRED VENTILATION AREA IS LOCATED IN THE UPPER PORTION OF ROOF, PER IRC SECTION R806.2.2

18 SI / LF

014 PROPOSED PROPERTY LINE IN BLA PERMIT, SEE PERMIT 2LLA_23001. 040 DASHED LINE OF NEW SETBACK LINE AFTER BLA ADJUSTMENT. SEE PERMIT

227 SHORT DASHED LINE OF BUILDING BELOW.

306 COMPOSITION SHINGLE ROOFING INSTALLED PER MANUFACTURER. PER R905.2.2, DOUBLE LAYER OF UNDERLAYMENT REQUIRED IF ROOF PITCH IS SHALLOWER THAN 4:12.

307 OVERFRAMED CRICKET, UNVENTED: SLOPE MINIMUM 1/4" PER 12". MINIMUM 1/4" OVERLAYMENT PROTECTION ROOF BOARD OVER POLYISO RIGID FOAM BOARD INSULATION, SOLID PACKED AND TAPERED TO ACHIEVE MINIMUM SLOPE TO DRAIN; INSTALL ROOFING MATERIAL OVER, PER MANUFACTURER'S RECOMMENDATION.

DASHED LINE INDICATES EAVE TO RECEIVE BLOCKING WITH (4) 2 1/2" VENTING HOLES PER 24" PROVIDING 7.35 S.I. OF VENTILATION PER LINÈÁR FOOT. SEE ROOF VENT TABLE. PENETRATIONS WITHIN 3' OF PROPERTY LINES MUST BE FIRE RATED AND COMPLY WITH SECTION R302.4.

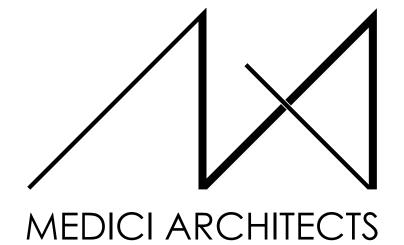
DASHED LINE INDICATES CONTINUOUS RIDGE VENT PROVIDING 18 SQUARE

INCHES OF VENTILATION PER LINEAR FOOT. SEE ROOF VENT TABLE R-49 BATT INSULATION AT VENTED ROOF. SEE SECTIONS. BAFFLE

INSULATION TO ENSURE 1" MIN. GAP FOR CROSS VENTILATION, TYP. DRYER EXHAUST VENT THROUGH ROOF PER MANUFACTURER REQUIREMENTS.

FAN VENT THROUGH ROOF PER MANUFACTURER REQUIREMENTS. 3" GUTTER W/ SQUARE DOWNSPOUT. POWDER COATED COLOR TBD. TIGHTLINE ALL DOWNSPOUTS TO STORMWATER SYSTEM PER CIVIL ENGINEERING DRAWINGS, TYP.


339 BATH VENT THROUGH ROOF PER MANUFACTURER REQUIREMENTS.



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1	CORRECTION LETTER	5/28/24

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2436 74TH AVE SE - SFR

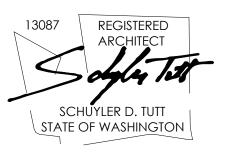LNL BUILDS

PROJECT ADDRESS: 2436 74TH AVE SE MERCER ISLAND, 98040

DRAWING NAME:

ROOF PLAN

DRAWN BY: DRA CHECKED BY: JML


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PROJECT No.: A22 087 DATE: 5/28/2024



012 SETBACK LINE


015 DASHED LINE OF EXISTING GRADE

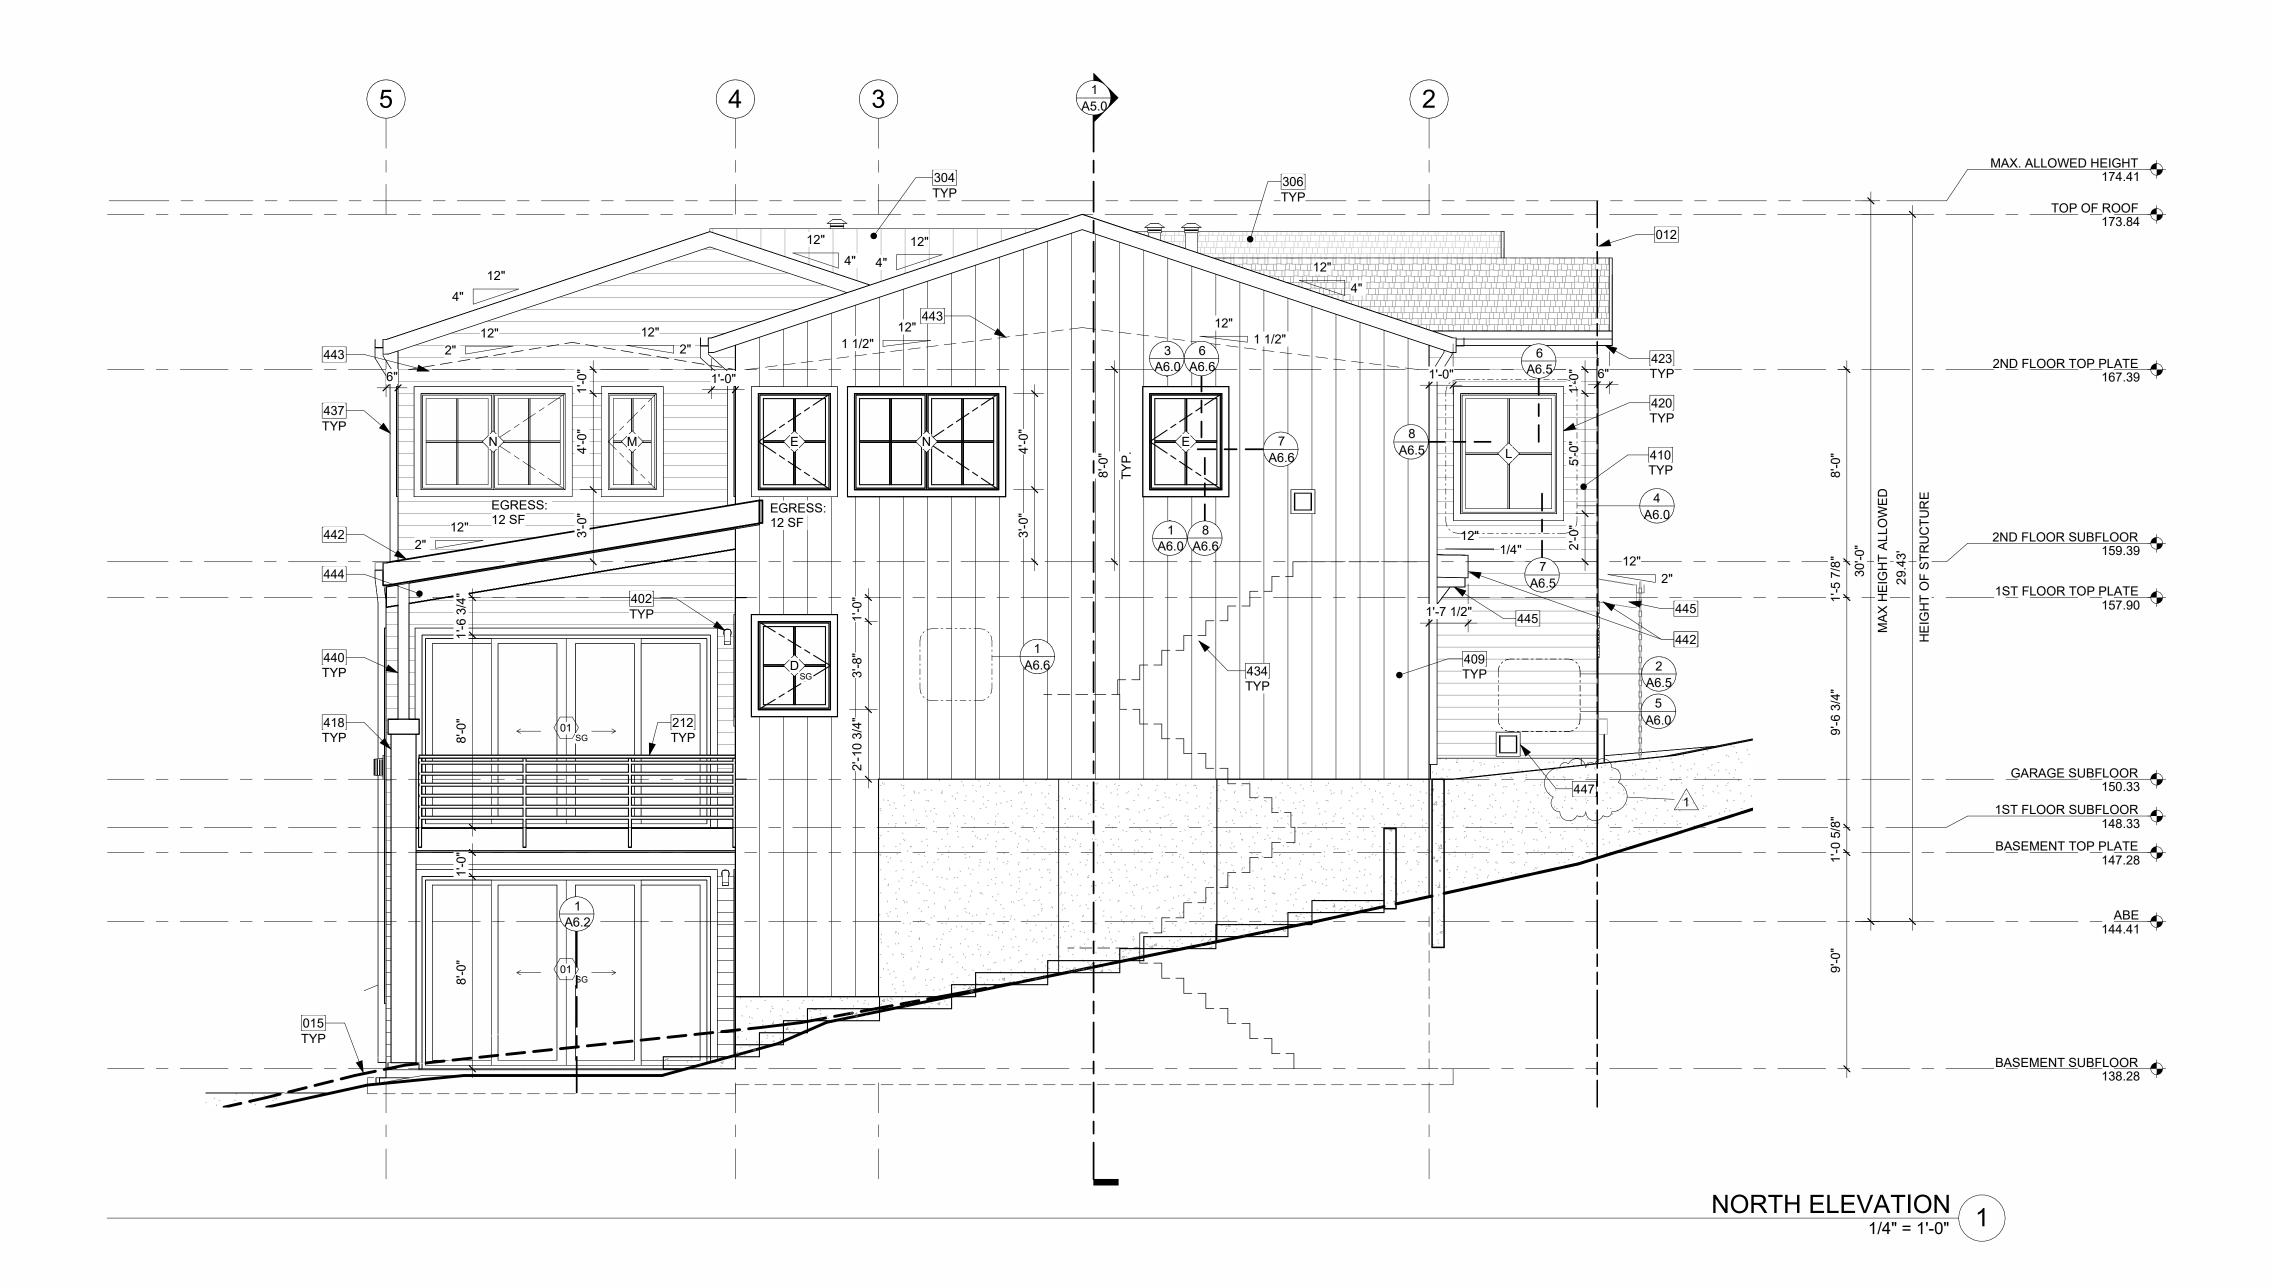- GUARDRAIL, FASCIA MOUNT DEFERRED SUBMITTAL. MIN. HEIGHT 36" PER IRC SECTION R312.1.2. REQUIRED GUARDS SHALL NOT HAVE OPENINGS FROM THE WALKING SURFACE TO THE REQUIRED GUARD HEIGHT WHICH ALLOW PASSAGE OF A SPHERE 4" IN DIAM. IRC SECTION R312.1.3 EXCEPTIONS: 1) THE TRIANGULAR OPENINGS AT THE OPEN SIDE OF STAIR, FORMED BY RISER, TREAD AND BOTTOM RAIL OF A GUARD, SHALL NOT ALLOW PASSAGE OF A SPHERE OF 6" IN DIAM. 2) GUARDS ON THE OPEN SIDE OF STAIRS SHALL NOT HAVE OPENINGS WHICH ALLOW PASSAGE OF A SPHERE 4-3/8" IN DIAM. PER TABLE R301.5 MINIMUM UNIFORMLY DISTRIBUTED LIVE LOADS GUARDRAIL AND HANDRAIL 200 PER SQUARE FOOT. CONNECTIONS PER STRUCTURAL TYPICAL GUARDRAIL DETAILS.
- 304 METAL STANDING SEAM ROOF ASSEMBLY PER IRC SECTION R905.10.

 306 COMPOSITION SHINGLE ROOFING INSTALLED PER MANUFACTURER. PER R905.2.2, DOUBLE LAYER OF UNDERLAYMENT REQUIRED IF ROOF PITCH IS SHALLOWER THAN 4:12.
- SHALLOWER THAN 4:12.

 402 LIGHTING @ ALL EXTERIOR DOORS INSTALLED PER MANUFACTURER, TYP.
 CENTER OF LIGHT SOURCE 6' FROM WALKING SURFACE OR IN SOFFIT.
 FIXTURES PER OWNER.
- FIBER CEMENT PANEL (HARDIEPANEL SMOOTH VERTICAL SIDING, OR SIMILAR)
 RAINSCREEN PAINTED, COLOR TBD. NOTE: ALL HARDIE PANEL DIVISIONS TO
 ALIGN WITH ARCHITECTURAL FEATURES AS SHOWN, TYP.
- 410 FIBER CEMENT PLANK HORIZONTAL LAP SIDING WITH 6" EXPOSURE (HARDIEPLANK SELECT CEDARMILL LAP SIDING, OR SIMILAR), PAINTED COLOR
- 418 MASONRY VENEER MECHANICALLY ATTACHED TO COLUMN AND INSTALLED PER MANUFACTURER RECOMMENDATION. COLOR AND PATTERN TBD.
- HARDIE TRIM, PAINTED COLOR TBD.
- FASCIA BOARD: 2x8 WITH POWDER COATED FLASHING, COLOR TBD.

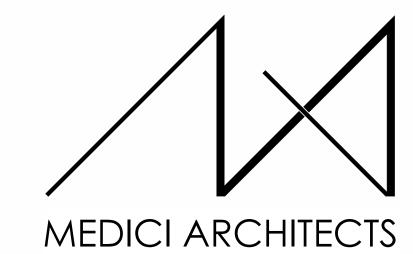
 DASHED LINE OF STAIRS.
- 437 SQUARE DOWNSPOUT. TIGHTLINE ALL DOWNSPOUTS TO STORMWATER
- SYSTEM PER CIVIL ENGINEERING DRAWINGS, TYP.
 440 PT COLUMN PER STRUCTURE.
- FASCIA BOARD: 2x12 WITH POWDER COATED FLASHING, COLOR TBD.
 DASHED LINE OF VAULTED CEILING.
- 44 ARCHITECTURAL EXPOSED 2X10 WOOD RAFTERS, PAINT COLOR TBD.
- ARCHITECTURAL EXPOSED 2X6 WOOD RAFTERS, PAINT COLOR TBD.
 CRAWL SPACE EXHAUST VENT.



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DRAWING NAME:

ELEVATIONS


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PLOT SCALE: 1:1

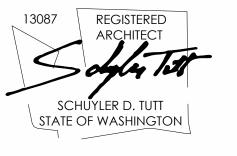A4.0



ELEVATION NOTES

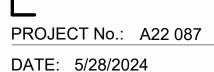- 1. VERIFY SHEAR WALL NAILING & HOLDOWNS PER STRUCTURAL PLAN &
- SCHEDULE PRIOR TO INSTALLING SIDING.
 2. WOOD SIDING SEAL & STAIN ALL SIDES BEFORE INSTALLING AND @ ALL
- WEATHER PROTECTION. EXTERIOR WALLS SHALL PROVIDE THE BUILDING WITH A WEATHER-RESISTANT EXTERIOR WALL ENVELOPE. THE EXTERIOR WALL ENVELOPE SHALL INCLUDE FLASHING AND BE CONSTRUCTED IN SUCH A MANNER AS TO PREVENT THE ACCUMULATION OF WATER WITHIN THE WALL ASSEMBLY BY PROVIDING A WATER-RESISTIVE BARRIER BEHIND THE EXTERIOR VENEER AND A MEANS FOR DRAINING WATER THAT ENTERS THE ASSEMBLY TO THE EXTERIOR. PROTECTION AGAINST
- CONDENSATION IN THE EXTERIOR WALL ASSEMBLY SHALL BE PROVIDED.

 4. PER IRC R703.8. FLASHING AT WALLS. FLASHING SHALL BE INSTALLED IN SUCH A MANNER SO AS TO PREVENT MOISTURE FROM ENTERING THE WALL OR TO REDIRECT THAT MOISTURE TO THE EXTERIOR. FLASHING SHALL BE INSTALLED AT THE PERIMETERS OF EXTERIOR DOOR AND WINDOW ASSEMBLIES, PENETRATIONS AND TERMINATIONS OF EXTERIOR WALL ASSEMBLIES, EXTERIOR WALL INTERSECTIONS WITH ROOFS, CHIMNEYS, PORCHES, DECKS, BALCONIES AND SIMILAR PROJECTIONS AND AT BUILT-IN GUTTERS AND SIMILAR LOCATIONS WHERE MOISTURE COULD ENTER THE WALL. FLASHING WITH PROJECTING FLANGES SHALL BE INSTALLED ON BOTH SIDES AND THE ENDS OF COPINGS, UNDER SILLS AND
- CONTINUOUSLY ABOVE PROJECTING TRIM.

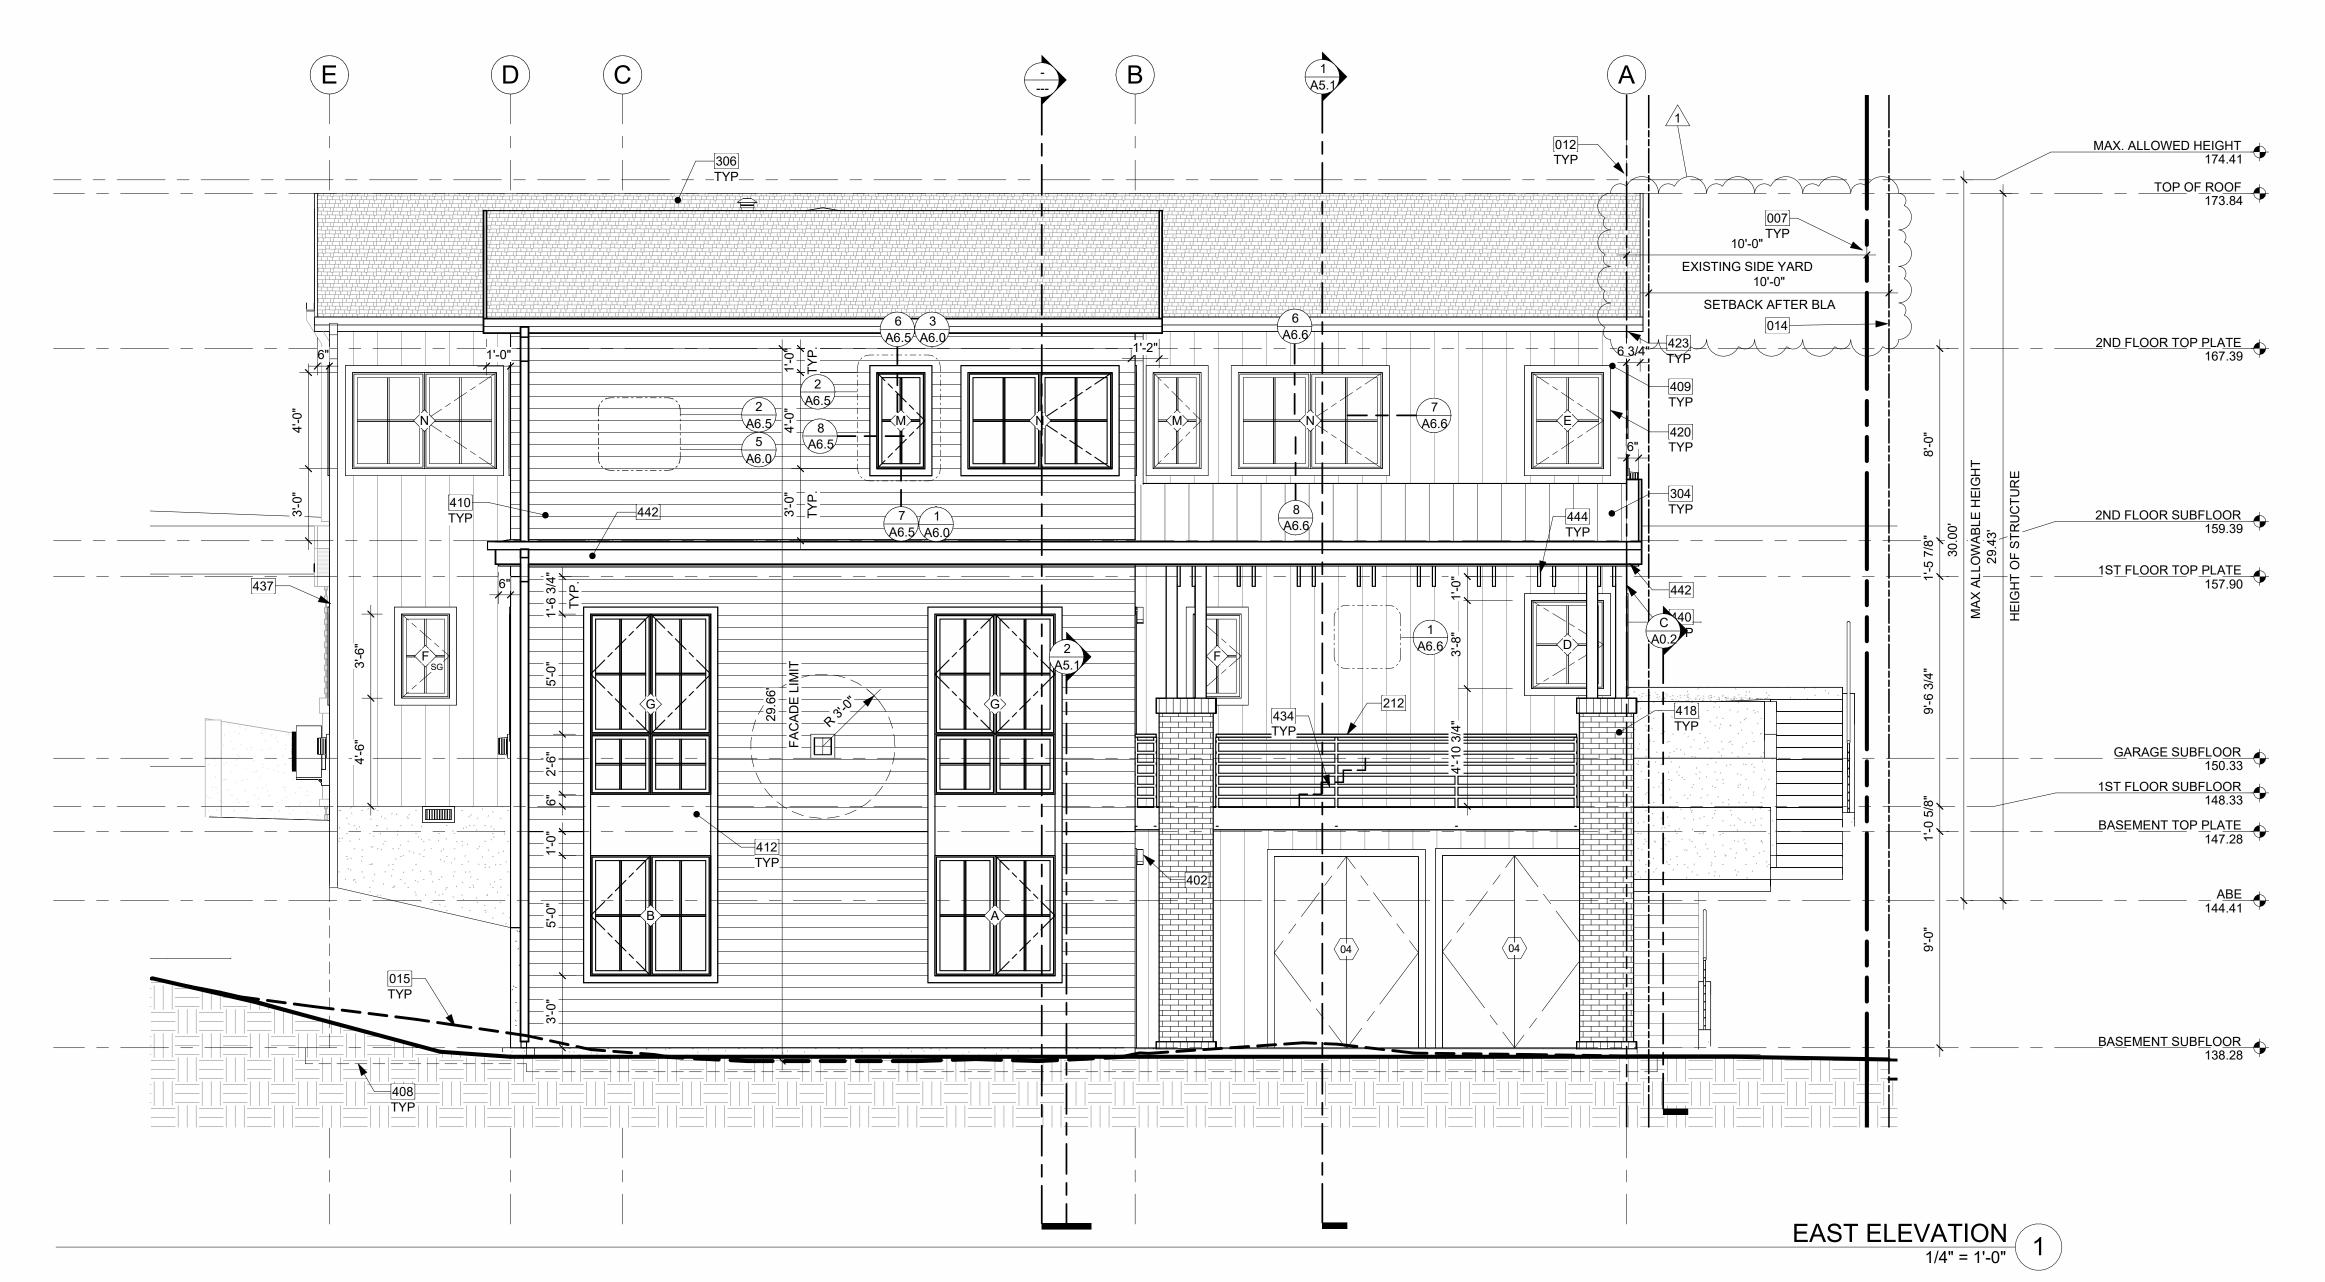
 5. PROVIDE FLASHING AT ROOF PENETRATIONS PER IRC R903.2.1. FLASHING SHALL BE INSTALLED AT WALL AND ROOF INTERSECTIONS, AT GUTTERS, WHEREVER THERE IS A CHANGE IN ROOF SLOPE OR DIRECTION AND AROUND ROOF OPENINGS. WHERE FLASHING IS OF METAL, THE METAL SHALL BE CORROSION RESISTANT.
- 7. PROVIDE WEATHER STRIPPING AT ALL EXTERIOR & GARAGE DOORS.

PROVIDE CONTINUOUS GUTTERS & DOWNSPOUTS AT EAVES PER PLANS,

- CAULK ALL EXTERIOR JOINTS & PENETRATIONS.

 8. WINDOWS AND DOORS SHALL BE INSTALLED IN ACCORDANCE WITH
- APPROVED MANUFACTURER'S INSTRUCTIONS.

 SEE GENERAL NOTES SHEET A0.3 FOR ADDITIONAL NOTES.




- 007 EXISTING PROPERTY LINE
- 012 SETBACK LINE
- 014 PROPOSED PROPERTY LINE IN BLA PERMIT, SEE PERMIT 2LLA_23001.
- 015 DASHED LINE OF EXISTING GRADE
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- 412 IN-FILL FIBER CEMENT PANEL (HARDIEPANEL SMOOTH VERTICAL SIDING, OR SIMILAR) RAINSCREEN PAINTED TO MATCH WINDOW COLOR.
- MASONRY VENEER MECHANICALLY ATTACHED TO COLUMN AND INSTALLED PER MANUFACTURER RECOMMENDATION. COLOR AND PATTERN TBD.
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- ARCHITECTURAL EXPOSED 2X10 WOOD RAFTERS, PAINT COLOR TBD.


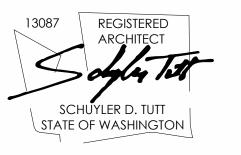
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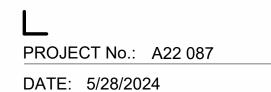
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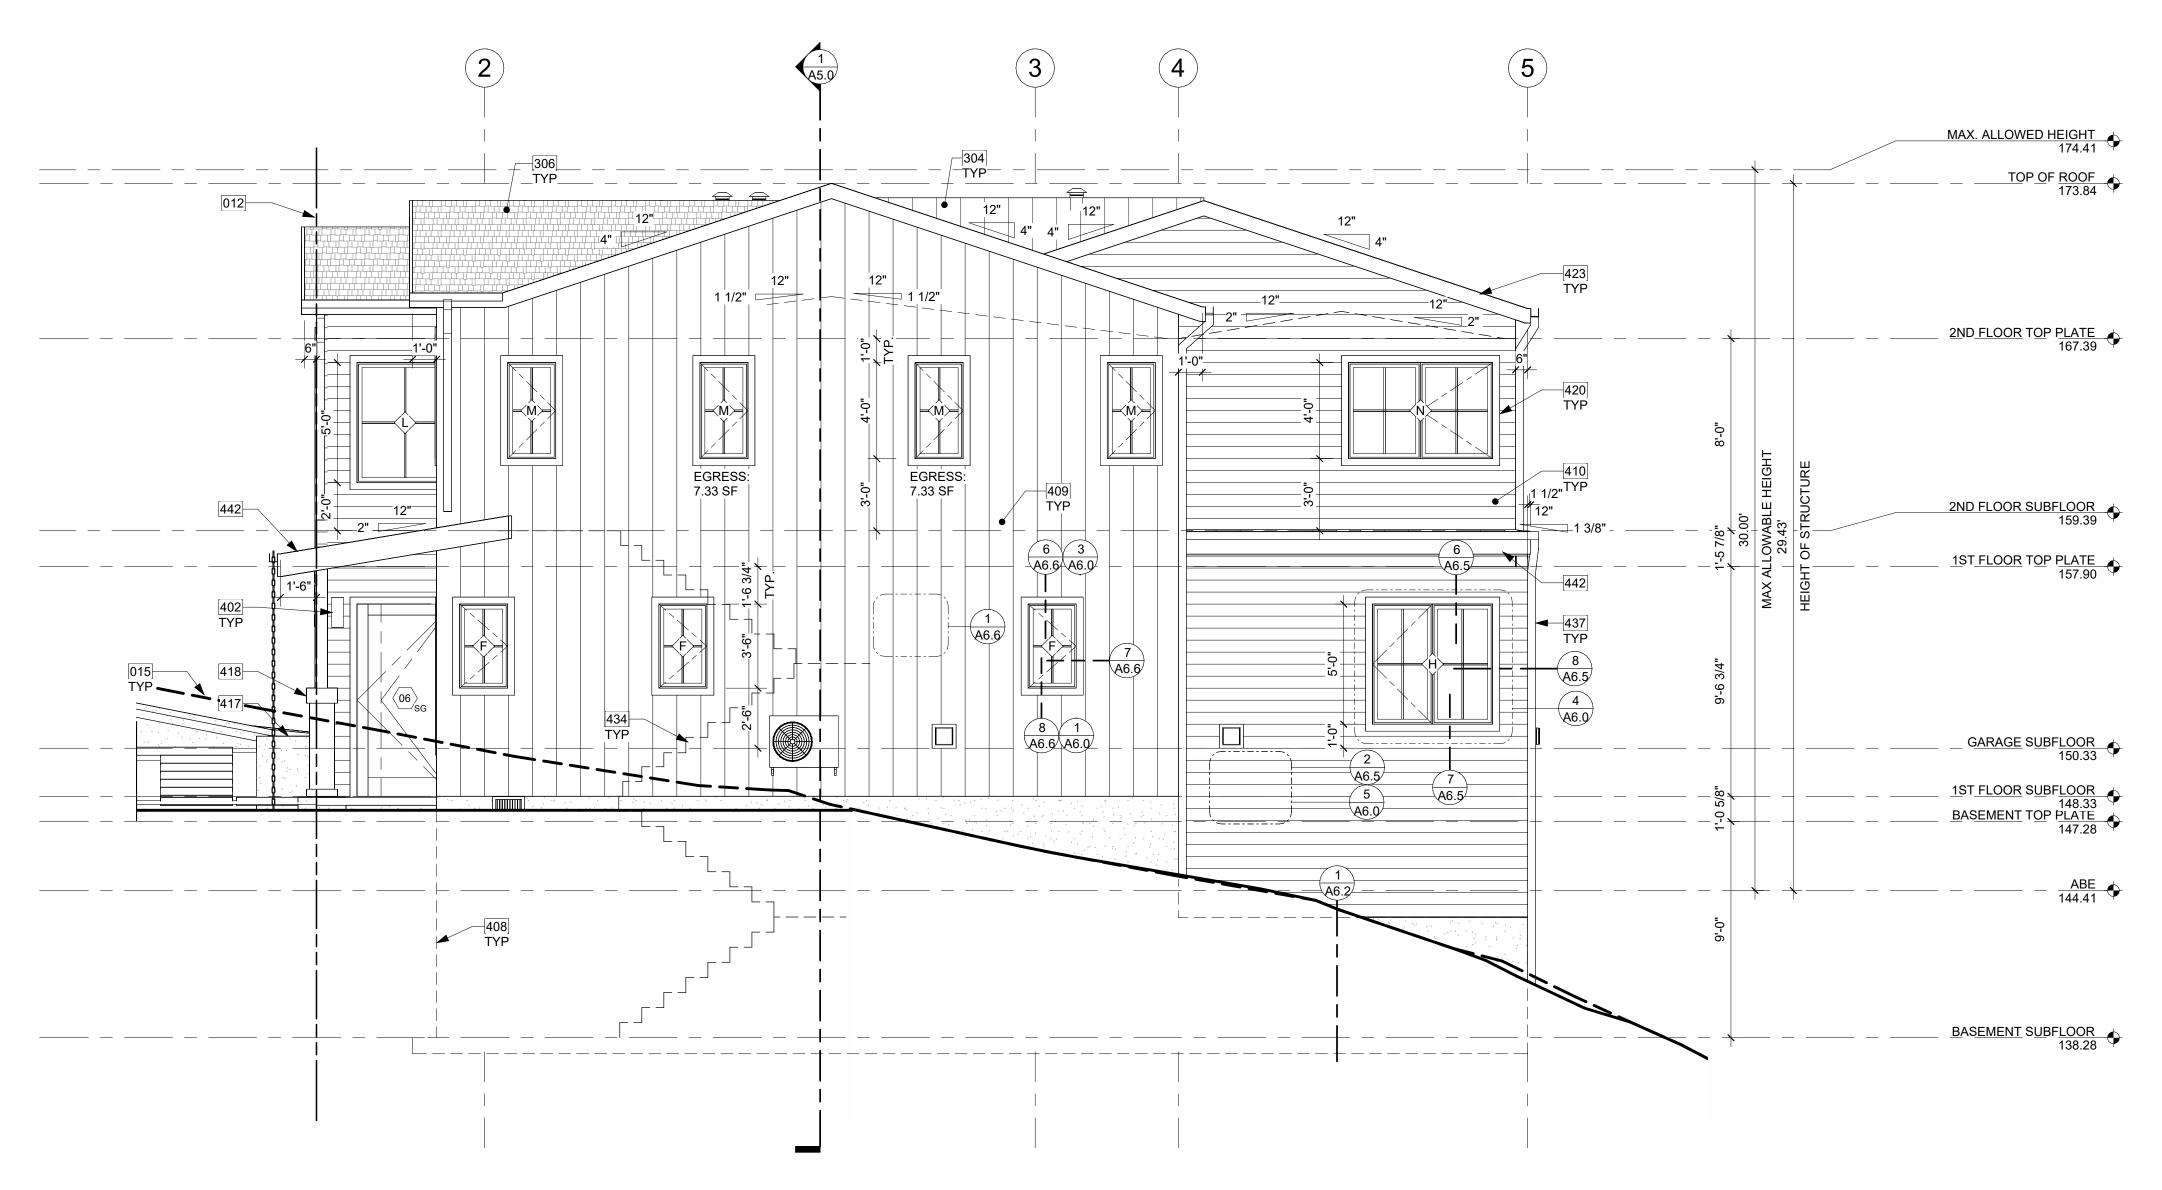
PLOT SCALE: 1:1



EAST ELEVATION PERSPECTIVE


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- CONDENSATION IN THE EXTERIOR WALL ASSEMBLY SHALL BE PROVIDED. PER IRC R703.8. FLASHING AT WALLS. FLASHING SHALL BE INSTALLED IN SUCH A MANNER SO AS TO PREVENT MOISTURE FROM ENTERING THE WALL OR TO REDIRECT THAT MOISTURE TO THE EXTERIOR. FLASHING SHALL BE INSTALLED AT THE PERIMETERS OF EXTERIOR DOOR AND WINDOW ASSEMBLIES, PENETRATIONS AND TERMINATIONS OF EXTERIOR WALL ASSEMBLIES, EXTERIOR WALL INTERSECTIONS WITH ROOFS, CHIMNEYS, PORCHES, DECKS, BALCONIES AND SIMILAR PROJECTIONS AND AT BUILT-IN GUTTERS AND SIMILAR LOCATIONS WHERE MOISTURE COULD ENTER THE WALL. FLASHING WITH PROJECTING FLANGES SHALL BE INSTALLED ON BOTH SIDES AND THE ENDS OF COPINGS, UNDER SILLS AND
- CONTINUOUSLY ABOVE PROJECTING TRIM. PROVIDE FLASHING AT ROOF PENETRATIONS PER IRC R903.2.1. FLASHING SHALL BE INSTALLED AT WALL AND ROOF INTERSECTIONS, AT GUTTERS, WHEREVER THERE IS A CHANGE IN ROOF SLOPE OR DIRECTION AND AROUND ROOF OPENINGS. WHERE FLASHING IS OF METAL, THE METAL SHALL BE CORROSION RESISTANT.
- PROVIDE CONTINUOUS GUTTERS & DOWNSPOUTS AT EAVES PER PLANS, PROVIDE WEATHER STRIPPING AT ALL EXTERIOR & GARAGE DOORS.
- CAULK ALL EXTERIOR JOINTS & PENETRATIONS. WINDOWS AND DOORS SHALL BE INSTALLED IN ACCORDANCE WITH
- APPROVED MANUFACTURER'S INSTRUCTIONS. SEE GENERAL NOTES SHEET A0.3 FOR ADDITIONAL NOTES.






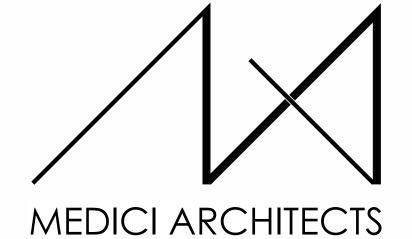- 012 SETBACK LINE
- 015 DASHED LINE OF EXISTING GRADE
- 304 METAL STANDING SEAM ROOF ASSEMBLY PER IRC SECTION R905.10. COMPOSITION SHINGLE ROOFING INSTALLED PER MANUFACTURER. PER R905.2.2, DOUBLE LAYER OF UNDERLAYMENT REQUIRED IF ROOF PITCH IS SHALLOWER THAN 4:12.
- 402 LIGHTING @ ALL EXTERIOR DOORS INSTALLED PER MANUFACTURER, TYP. CENTER OF LIGHT SOURCE 6' FROM WALKING SURFACE OR IN SOFFIT. FIXTURES PER OWNER.
- DASHED LINES OF FOUNDATION STEMWALL AND FOOTING PER STRUCTURE FIBER CEMENT PANEL (HARDIEPANEL SMOOTH VERTICAL SIDING, OR SIMILAR) RAINSCREEN PAINTED, COLOR TBD. NOTE: ALL HARDIE PANEL DIVISIONS TO ALIGN WITH ARCHITECTURAL FEATURES AS SHOWN, TYP.
- FIBER CEMENT PLANK HORIZONTAL LAP SIDING WITH 6" EXPOSURE (HARDIEPLANK SELECT CEDARMILL LAP SIDING, OR SIMILAR), PAINTED COLOR
- 417 EXPOSED ARCHITECTURAL CONCRETE.
- MASONRY VENEER MECHANICALLY ATTACHED TO COLUMN AND INSTALLED PER MANUFACTURER RECOMMENDATION. COLOR AND PATTERN TBD.
- HARDIE TRIM, PAINTED COLOR TBD.
- FASCIA BOARD: 2x8 WITH POWDER COATED FLASHING, COLOR TBD.
- DASHED LINE OF STAIRS. SQUARE DOWNSPOUT. TIGHTLINE ALL DOWNSPOUTS TO STORMWATER
- SYSTEM PER CIVIL ENGINEERING DRAWINGS, TYP.
- FASCIA BOARD: 2x12 WITH POWDER COATED FLASHING, COLOR TBD.



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REGISTRATION:

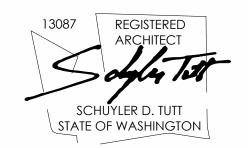

INTAKE DATE:	9/28/2023
REVISIONS:	DATE:

PROJECT / CLIENT:

2436 74TH AVE SE - SFR

LNL BUILDS

PROJECT ADDRESS: 2436 74TH AVE SE MERCER ISLAND, 98040

DRAWING NAME:

ELEVATIONS

DRAWN BY: Author

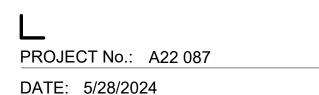
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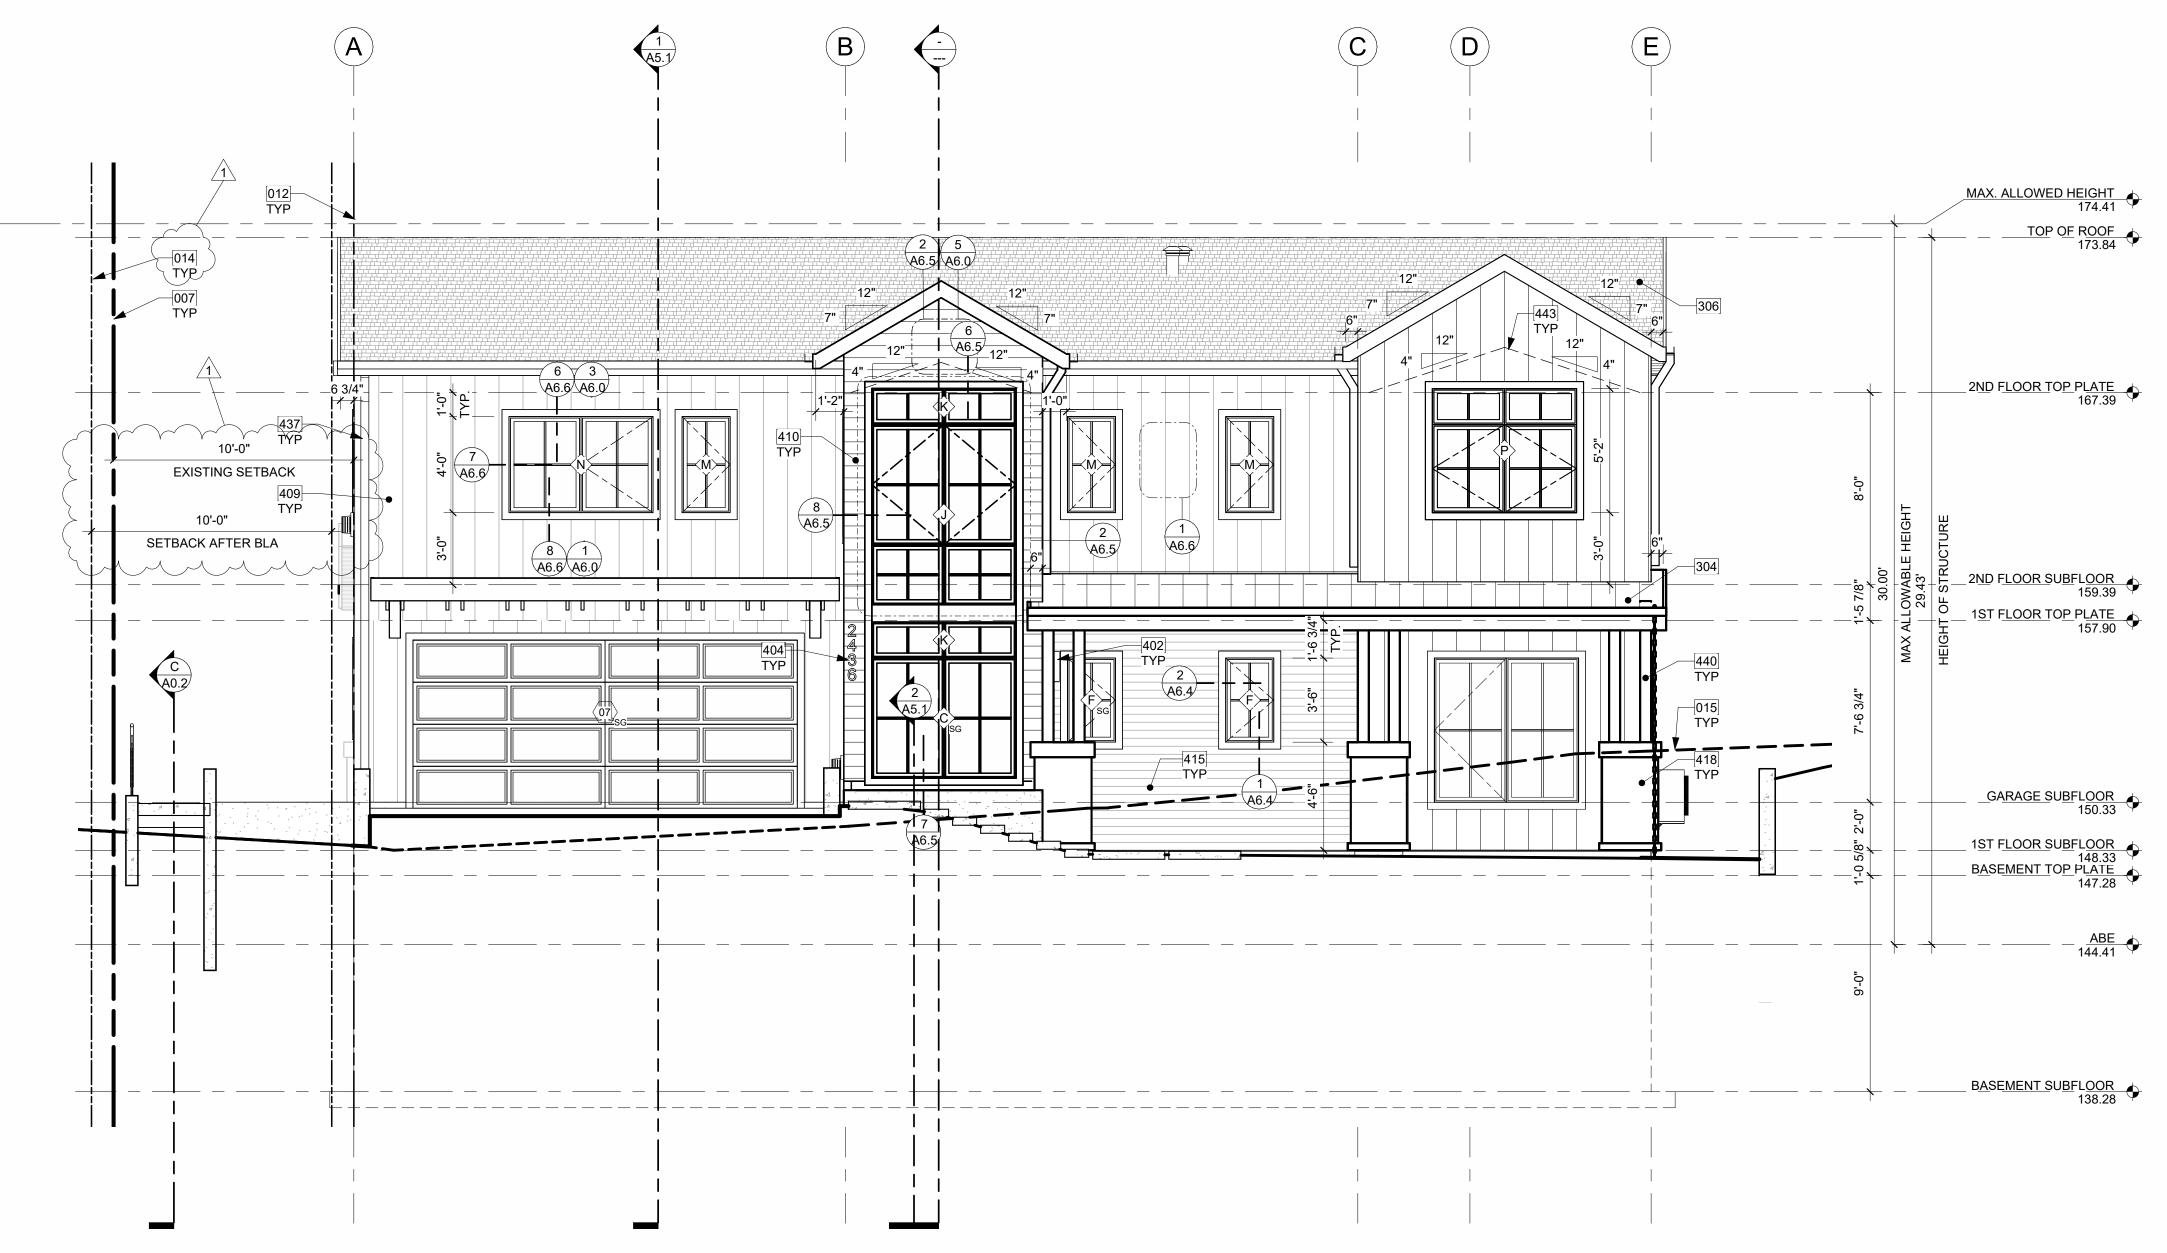
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- **ELEVATION NOTES** VERIFY SHEAR WALL NAILING & HOLDOWNS PER STRUCTURAL PLAN &
- SCHEDULE PRIOR TO INSTALLING SIDING. WOOD SIDING - SEAL & STAIN ALL SIDES BEFORE INSTALLING AND @ ALL
- CUTS.
- WEATHER PROTECTION. EXTERIOR WALLS SHALL PROVIDE THE BUILDING WITH A WEATHER-RESISTANT EXTERIOR WALL ENVELOPE. THE EXTERIOR WALL ENVELOPE SHALL INCLUDE FLASHING AND BE CONSTRUCTED IN SUCH A MANNER AS TO PREVENT THE ACCUMULATION OF WATER WITHIN THE WALL ASSEMBLY BY PROVIDING A WATER-RESISTIVE BARRIER BEHIND THE EXTERIOR VENEER AND A MEANS FOR DRAINING WATER THAT ENTERS THE ASSEMBLY TO THE EXTERIOR. PROTECTION AGAINST CONDENSATION IN THE EXTERIOR WALL ASSEMBLY SHALL BE PROVIDED.
- PER IRC R703.8. FLASHING AT WALLS. FLASHING SHALL BE INSTALLED IN SUCH A MANNER SO AS TO PREVENT MOISTURE FROM ENTERING THE WALL OR TO REDIRECT THAT MOISTURE TO THE EXTERIOR. FLASHING SHALL BE INSTALLED AT THE PERIMETERS OF EXTERIOR DOOR AND WINDOW ASSEMBLIES, PENETRATIONS AND TERMINATIONS OF EXTERIOR WALL ASSEMBLIES, EXTERIOR WALL INTERSECTIONS WITH ROOFS, CHIMNEYS, PORCHES, DECKS, BALCONIES AND SIMILAR PROJECTIONS AND AT BUILT-IN GUTTERS AND SIMILAR LOCATIONS WHERE MOISTURE COULD ENTER THE WALL. FLASHING WITH PROJECTING FLANGES SHALL BE INSTALLED ON BOTH SIDES AND THE ENDS OF COPINGS, UNDER SILLS AND
- CONTINUOUSLY ABOVE PROJECTING TRIM. PROVIDE FLASHING AT ROOF PENETRATIONS PER IRC R903.2.1. FLASHING SHALL BE INSTALLED AT WALL AND ROOF INTERSECTIONS, AT GUTTERS, WHEREVER THERE IS A CHANGE IN ROOF SLOPE OR DIRECTION AND AROUND ROOF OPENINGS. WHERE FLASHING IS OF METAL, THE METAL SHALL BE CORROSION RESISTANT.
- PROVIDE CONTINUOUS GUTTERS & DOWNSPOUTS AT EAVES PER PLANS,
- PROVIDE WEATHER STRIPPING AT ALL EXTERIOR & GARAGE DOORS. CAULK ALL EXTERIOR JOINTS & PENETRATIONS.
- WINDOWS AND DOORS SHALL BE INSTALLED IN ACCORDANCE WITH APPROVED MANUFACTURER'S INSTRUCTIONS.
- SEE GENERAL NOTES SHEET A0.3 FOR ADDITIONAL NOTES.



3_WEST ELEVATION 1

KEY NOTES

- 007 EXISTING PROPERTY LINE
- 012 SETBACK LINE
- 014 PROPOSED PROPERTY LINE IN BLA PERMIT, SEE PERMIT 2LLA_23001.
 015 DASHED LINE OF EXISTING GRADE
- 304 METAL STANDING SEAM ROOF ASSEMBLY PER IRC SECTION R905.10.

 306 COMPOSITION SHINGLE ROOFING INSTALLED PER MANUFACTURER. PER R905.2.2, DOUBLE LAYER OF UNDERLAYMENT REQUIRED IF ROOF PITCH IS
- SHALLOWER THAN 4:12.

 402 LIGHTING @ ALL EXTERIOR DOORS INSTALLED PER MANUFACTURER, TYP.
 CENTER OF LIGHT SOURCE 6' FROM WALKING SURFACE OR IN SOFFIT.
- FIXTURES PER OWNER.

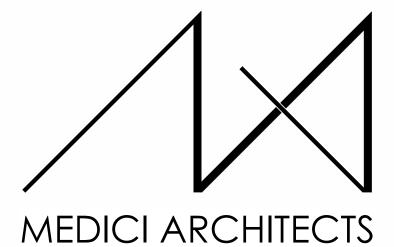
 404

 LOCATION OF HOUSE ADDRESS OR NUMBER TO BE PLAINLY VISIBLE AND LEGIBLE FROM THE STREET. SIZE: 6", FONT: HELVELTICA, COLOR: DARK
- FIBER CEMENT PANEL (HARDIEPANEL SMOOTH VERTICAL SIDING, OR SIMILAR)
 RAINSCREEN PAINTED, COLOR TBD. NOTE: ALL HARDIE PANEL DIVISIONS TO
- ALIGN WITH ARCHITECTURAL FEATURES AS SHOWN, TYP.

 OFIBER CEMENT PLANK HORIZONTAL LAP SIDING WITH 6" EXPOSURE (HARDIEPLANK SELECT CEDARMILL LAP SIDING, OR SIMILAR), PAINTED COLOR
- 415 ALUMINUM 4" V GROOVE WOOD GRAIN SIDING RAINSCREEN PANEL (LONGBOARD, OR SIMILAR). TYP.
- 8 MASONRY VENEER MECHANICALLY ATTACHED TO COLUMN AND INSTALLED
- PER MANUFACTURER RECOMMENDATION. COLOR AND PATTERN TBD.

 37 SQUARE DOWNSPOUT. TIGHTLINE ALL DOWNSPOUTS TO STORMWATER
- SYSTEM PER CIVIL ENGINEERING DRAWINGS, TYP.

 440 PT COLUMN PER STRUCTURE.
- 443 DASHED LINE OF VAULTED CEILING.



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KETCHUM, ID 83340

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PROJECT / CLIENT:

2436 74TH AVE SE - SFR

LNL BUILDS

PROJECT ADDRESS: 2436 74TH AVE SE MERCER ISLAND, 98040

DRAWING NAME:

ELEVATIONS

DRAWN BY: DRA

CHECKED BY: JML

PHASE:

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Λ / (

PLOT SCALE: 1:1



WEST ELEVATION PERSPECTIVE

ELEVATION NOTES

- 1. VERIFY SHEAR WALL NAILING & HOLDOWNS PER STRUCTURAL PLAN &
- SCHEDULE PRIOR TO INSTALLING SIDING.
 2. WOOD SIDING SEAL & STAIN ALL SIDES BEFORE INSTALLING AND @ ALL
- CUTS.

 WEATHER PROTECTION. EXTERIOR WALLS SHALL PROVIDE THE BUILDING WITH A WEATHER-RESISTANT EXTERIOR WALL ENVELOPE. THE EXTERIOR WALL ENVELOPE SHALL INCLUDE FLASHING AND BE CONSTRUCTED IN SUCH A MANNER AS TO PREVENT THE ACCUMULATION OF WATER WITHIN THE WALL ASSEMBLY BY PROVIDING A WATER-RESISTIVE BARRIER BEHIND THE EXTERIOR VENEER AND A MEANS FOR DRAINING WATER THAT ENTERS THE ASSEMBLY TO THE EXTERIOR. PROTECTION AGAINST
- CONDENSATION IN THE EXTERIOR WALL ASSEMBLY SHALL BE PROVIDED.

 4. PER IRC R703.8. FLASHING AT WALLS. FLASHING SHALL BE INSTALLED IN SUCH A MANNER SO AS TO PREVENT MOISTURE FROM ENTERING THE WALL OR TO REDIRECT THAT MOISTURE TO THE EXTERIOR. FLASHING SHALL BE INSTALLED AT THE PERIMETERS OF EXTERIOR DOOR AND WINDOW ASSEMBLIES, PENETRATIONS AND TERMINATIONS OF EXTERIOR WALL ASSEMBLIES, EXTERIOR WALL INTERSECTIONS WITH ROOFS, CHIMNEYS, PORCHES, DECKS, BALCONIES AND SIMILAR PROJECTIONS AND AT BUILT-IN GUTTERS AND SIMILAR LOCATIONS WHERE MOISTURE COULD ENTER THE WALL. FLASHING WITH PROJECTING FLANGES SHALL BE INSTALLED ON BOTH SIDES AND THE ENDS OF COPINGS, UNDER SILLS AND
- CONTINUOUSLY ABOVE PROJECTING TRIM.

 5. PROVIDE FLASHING AT ROOF PENETRATIONS PER IRC R903.2.1. FLASHING SHALL BE INSTALLED AT WALL AND ROOF INTERSECTIONS, AT GUTTERS, WHEREVER THERE IS A CHANGE IN ROOF SLOPE OR DIRECTION AND AROUND ROOF OPENINGS. WHERE FLASHING IS OF METAL, THE METAL SHALL BE CORROSION RESISTANT.
- PROVIDE CONTINUOUS GUTTERS & DOWNSPOUTS AT EAVES PER PLANS, TYP.


 PROVIDE WEATHER STRIPPING AT ALL EXTERIOR & CARACE DOORS
- 7. PROVIDE WEATHER STRIPPING AT ALL EXTERIOR & GARAGE DOORS. CAULK ALL EXTERIOR JOINTS & PENETRATIONS.
- . WINDOWS AND DOORS SHALL BE INSTALLED IN ACCORDANCE WITH
- APPROVED MANUFACTURER'S INSTRUCTIONS.

 SEE GENERAL NOTES SHEET A0.3 FOR ADDITIONAL NOTES.





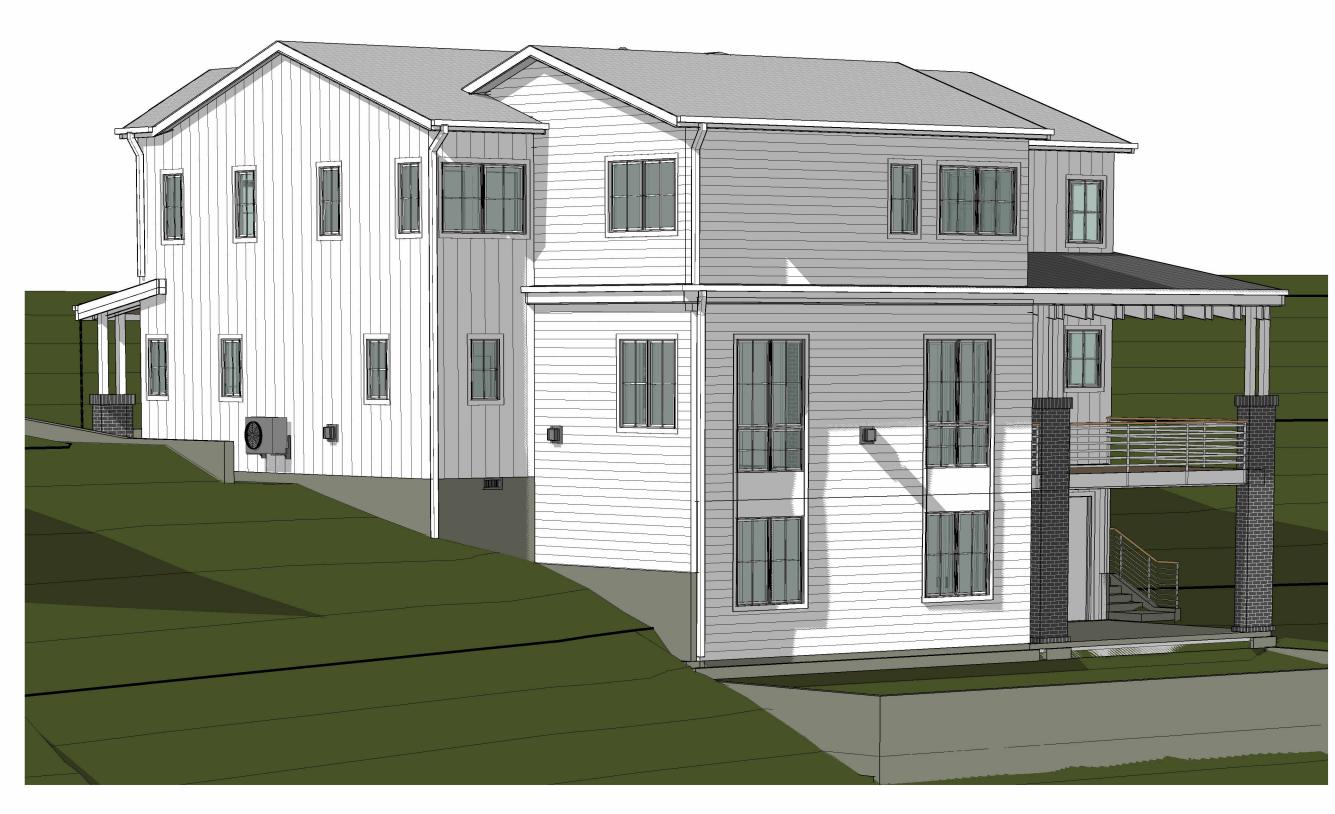PERSPECTIVE 2






PERSPECTIVE 3 NTS

PERSPECTIVE 4


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2436 74TH AVE SE - SFR

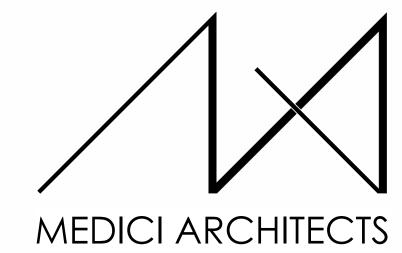LNL BUILDS

PROJECT ADDRESS: 2436 74TH AVE SE MERCER ISLAND, 98040

DRAWING NAME:

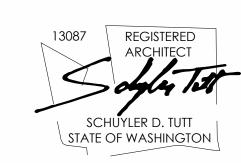PERSPECTIVES

DRAWN BY: DRA CHECKED BY: JML


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- CONCRETE SLAB (4" MIN. OR PER STRUCTURAL) OVER GRAVEL OR CRUSHED ROCK (4" MIN. OR PER GEOTECH) OVER FIRM UNDISTURBED SOIL. REINFORCING PER STRUCTURAL. EXTERIOR SLABS TO RECEIVE BROOM FINISH AND TO SLOPE 1/4" PER FOOT AWAY FROM BUILDING.
- PROVIDE INTERIOR STAIRWAY ILLUMINATION PER IRC SECTION R303.7. STAIRWAYS SHALL BE PROVIDED WITH AN ARTIFICIAL LIGHT SOURCE TO ILLUMINATE THE LANDINGS AND TREADS. THE LIGHT SOURCE SHALL BE CAPABLE OF ILLUMINATION LEVELS NOT LESS THAN 1 FOOT-CANDLE (11 LUX) AS MEASURED AT THE CENTER OF TREADS AND LANDINGS.
- WOOD STAIR W/ TREADS AND RISERS CONFORMING TO IRC R311.7.5. SEE STRUCTURAL DRAWINGS FOR FRAMING AND CONNECTIONS.
- GUARDRAIL, TOP OF WALL MOUNT DEFERRED SUBMITTAL. MIN. HEIGHT 36 PER IRC SECTION R312.1.2. REQUIRED GUARDS SHALL NOT HAVE OPENINGS FROM THE WALKING SURFACE TO THE REQUIRED GUARD HEIGHT WHICH ALLOW PASSAGE OF A SPHERE 4" IN DIAM. IRC SECTION R312.1.3 EXCEPTIONS: 1) THE TRIANGULAR OPENINGS AT THE OPEN SIDE OF STAIR, FORMED BY RISER, TREAD AND BOTTOM RAIL OF A GUARD, SHALL NOT ALLOW PASSAGE OF A SPHERE OF 6" IN DIAM. 2) GUARDS ON THE OPEN SIDE OF STAIRS SHALL NOT HAVE OPENINGS WHICH ALLOW PASSAGE OF A SPHERE 4-3/8" IN DIAM. PER TABLE R301.5 MINIMUM UNIFORMLY DISTRIBUTED LIVE LOADS - GUARDRAIL AND HANDRAIL 200 PER SQUARE FOOT. CONNECTIONS PER STRUCTURAL TYPICAL GUARDRAIL DETAILS.
- FURRED 2x4 WALL W/ R-13 BATT INSULATION AND CONTINUOUS 1" R-5 RIGID INSULATION TO MEET THE REQUIREMENTS OF WSEC TABLE R402.1.1 FOOTNOTE C. STUDS AGAINST CONCRETE STEMWALL MUST BE PT OR MUST BE SEPARATED FROM THE WALL BY AN APPROVED VAPOR BARRIER. R-5 THERMAL BREAK BETWEEN FLOOR SLAB AND BASEMENT WALL. FIREBLOCKING TO BE INSTALLED VERTICALLY AT THE CEILING AND FLOOR LEVELS AND HORIZONTALLY AT INTERVALS NOT EXCEEDING 10', PER SECTION
- DASHED LINE OF EXISTING GRADE.
- TRUSS FRAMING PER STRUCTURAL PLAN.
- FOUNDATION ANCHORAGE @ WALLS PER IRC SECTION R403.1.6. AND STRUCTURAL PLANS, PROVIDE A POLYETHYLENE FOAM GASKET STRIP AND SEAL BOTTOM PLATE, TYP.
- DIRECT CONNECT FOOTING DRAINS AND DOWNSPOUTS TO DESIGNED STORMWATER SYSTEM. SEE CIVIL DRAWINGS FOR CONNECTION. TYP.
- 5/8" GWB @ CEILINGS, TYP.
- TJI FRAMING PER STRUCTURAL PLAN. R-38 BATT INSULATION @ FLOORS BETWEEN HEATED AND UNHEATED
- R-49 BATT INSULATION W/ BAFFLE TO ENSURE 1" MIN. GAP FOR CROSS VENTILATION, TYP. USE COMBINATION OF R38C & R11 OR BUILD-UP OF RIGID INSULATION WHERE NECESSARY.
- 517 FOOTINGS PER STRUCTURAL PLANS.
- 518 EAVE TO RECEIVE BLOCKING WITH (4) 2 1/2" VENTING HOLES PER 24" PROVIDING 7.35 S.I. OF VENTILATION PER LINEAR FOOT. SEE ROOF PLAN AND
- | 519 | 2x6 STUD EXTERIOR WALL ASSEMBLY: SIDING PER ELEVATION OVER WATER-VAPOR PERMEABLE AIR-BARRIER OVER SHEATHING PER STRUCTURAL. 1/2" GYP INSIDE, TYP.
- 2X ROOF FRAMING AND CONNECTIONS PER STRUCTURAL PLAN.
- BEAM AND CONNECTIONS PER STRUCTURAL PLAN.
- 526 LINE OF CRAWL SPACE ACCESS BEYOND, SEE FLOOR PLAN FOR SILL HEIGHT

THERMAL INSULATION

WALLS (BELOW-GRADE): R-13 BATT INSULATION AND CONTINUOUS R-5 WALLS (ABOVE-GRADE): R-21 BATT INSULATION **HEADERS**: R-10 RIGID INSULATION

CEILINGS (STANDARD FRAMING): R-49 BATT INSULATION FLOORS: R-38 BATT INSULATION

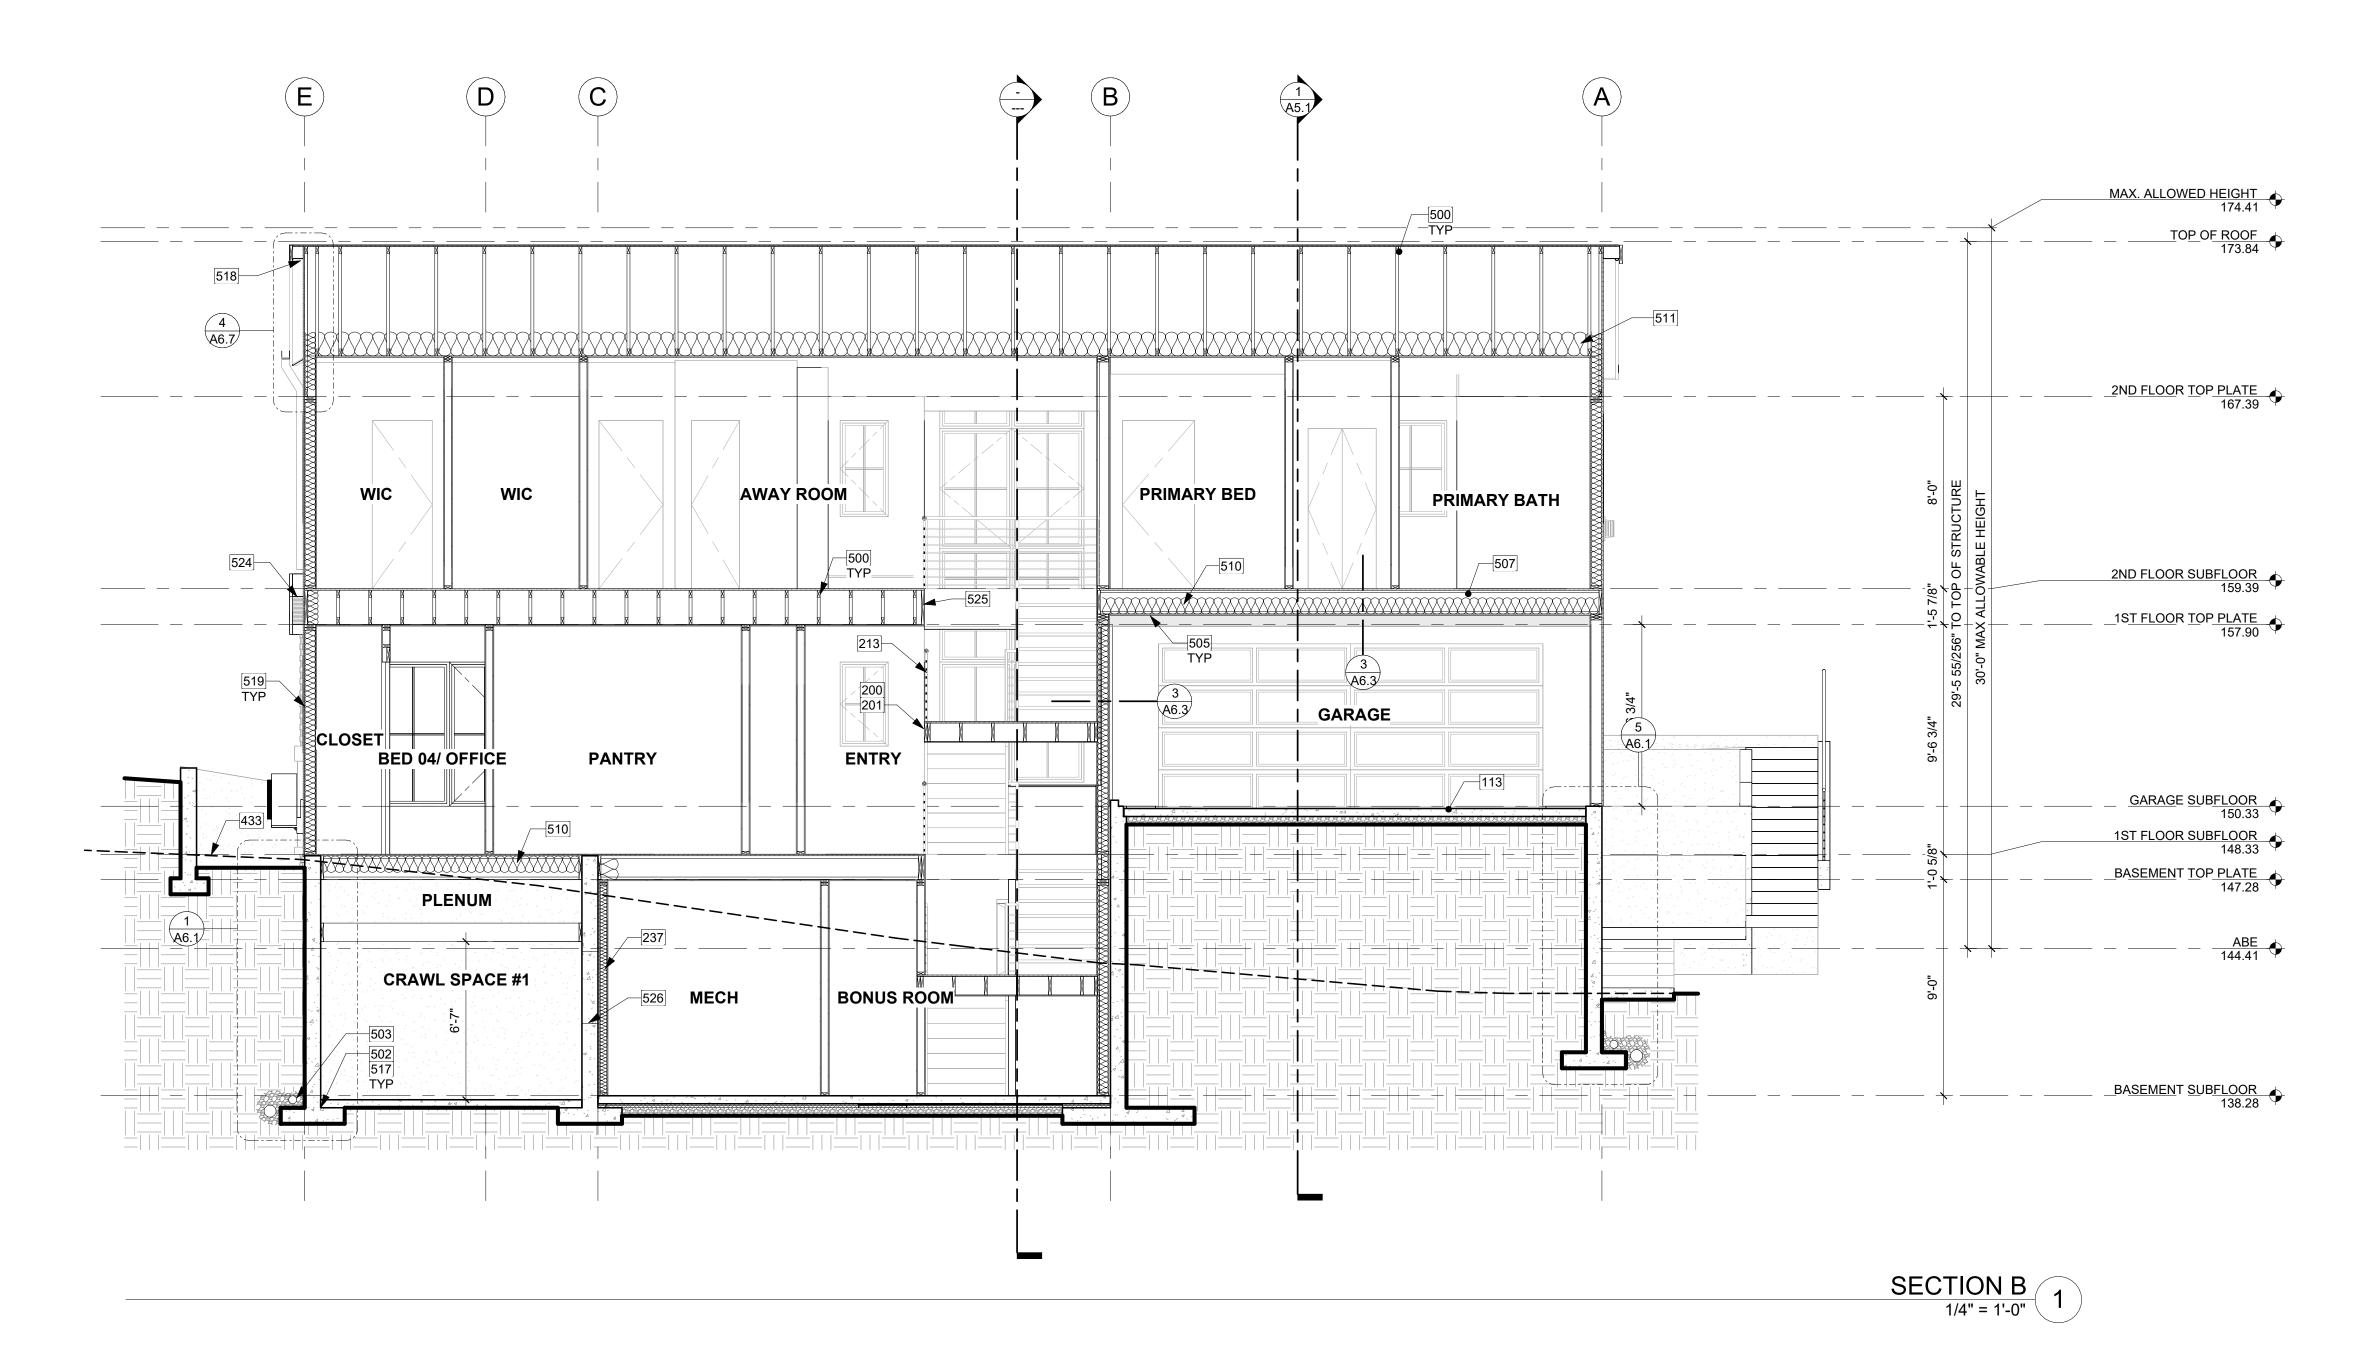SLAB: R-10 RIGID AT PERIMETER & UNDER


WINDOWS & DOORS: U-VALUE OF .28 OR

BETTER

ENTIRE SLAB

U-VALUE OF .50 OR SKYLIGHTS:

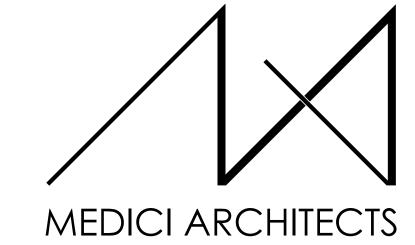BETTER




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SECTIONS

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CHECKED BY: JML

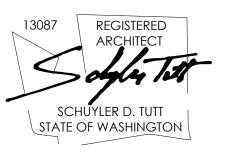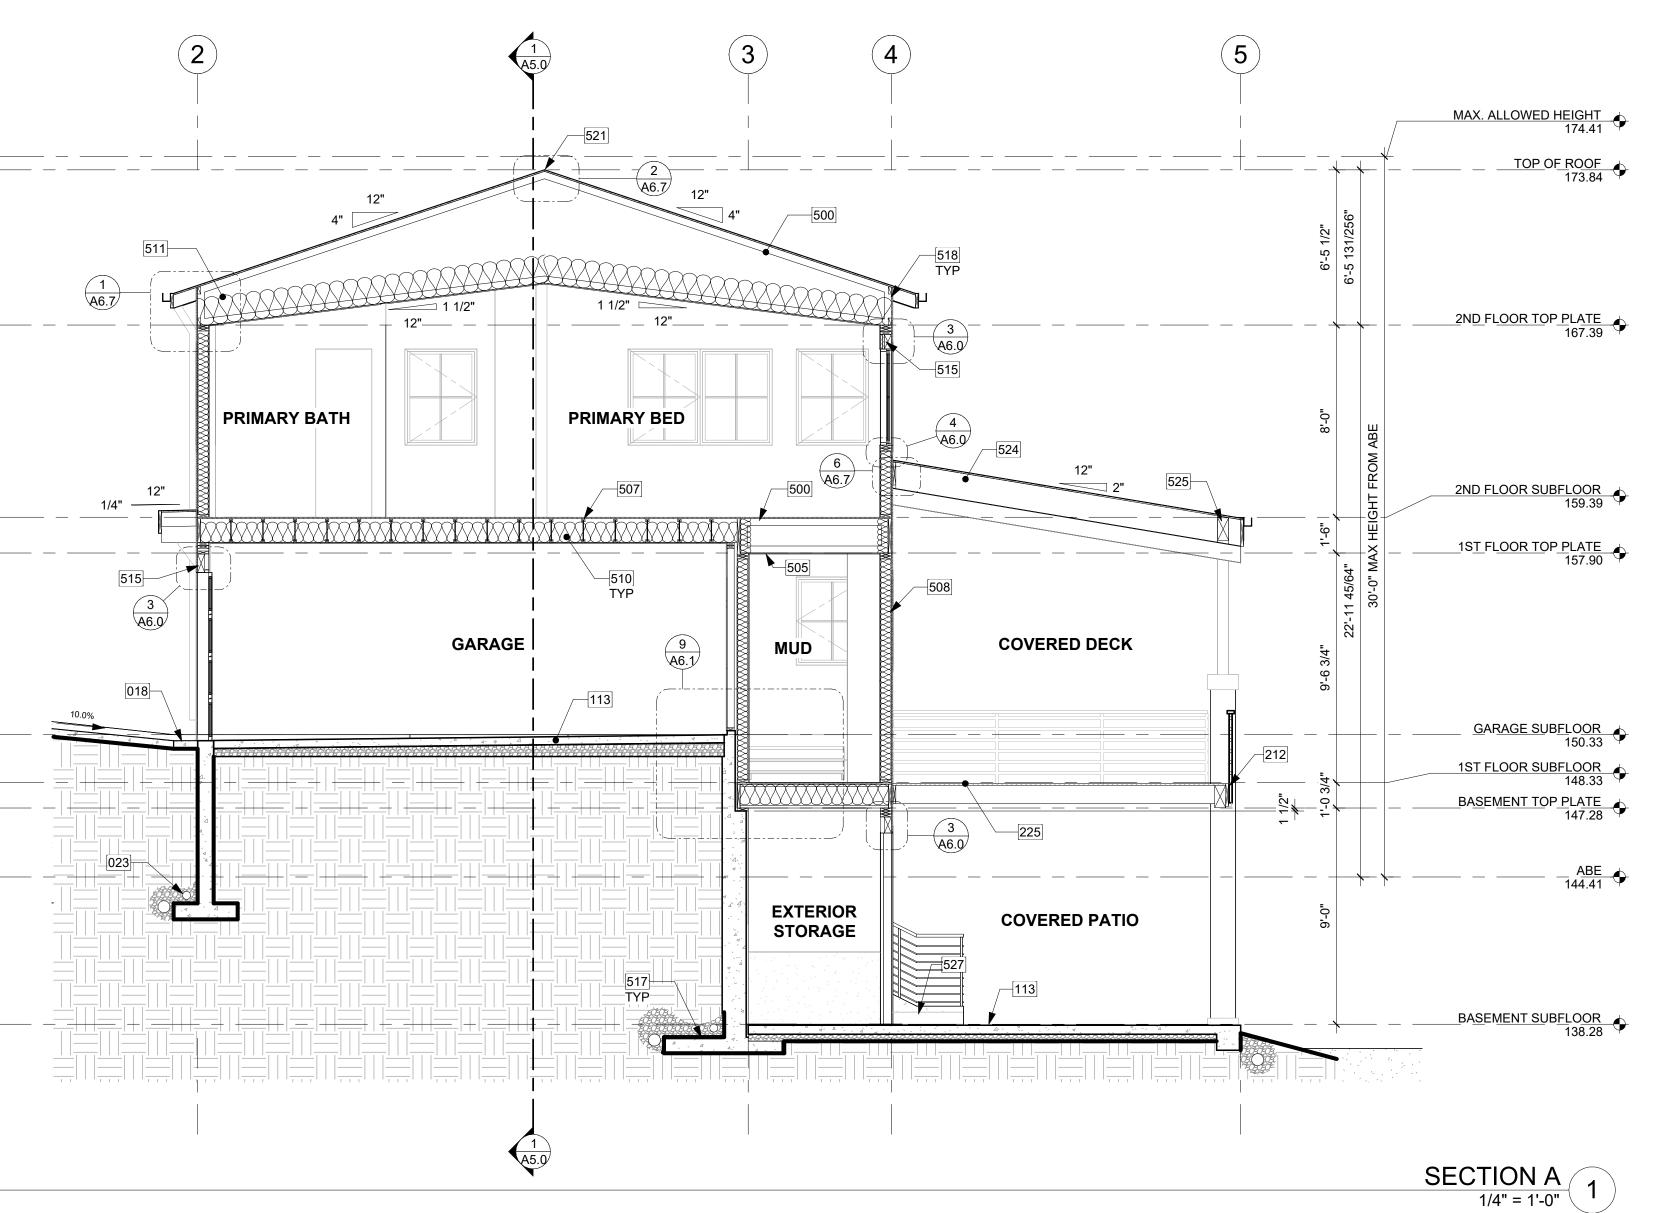
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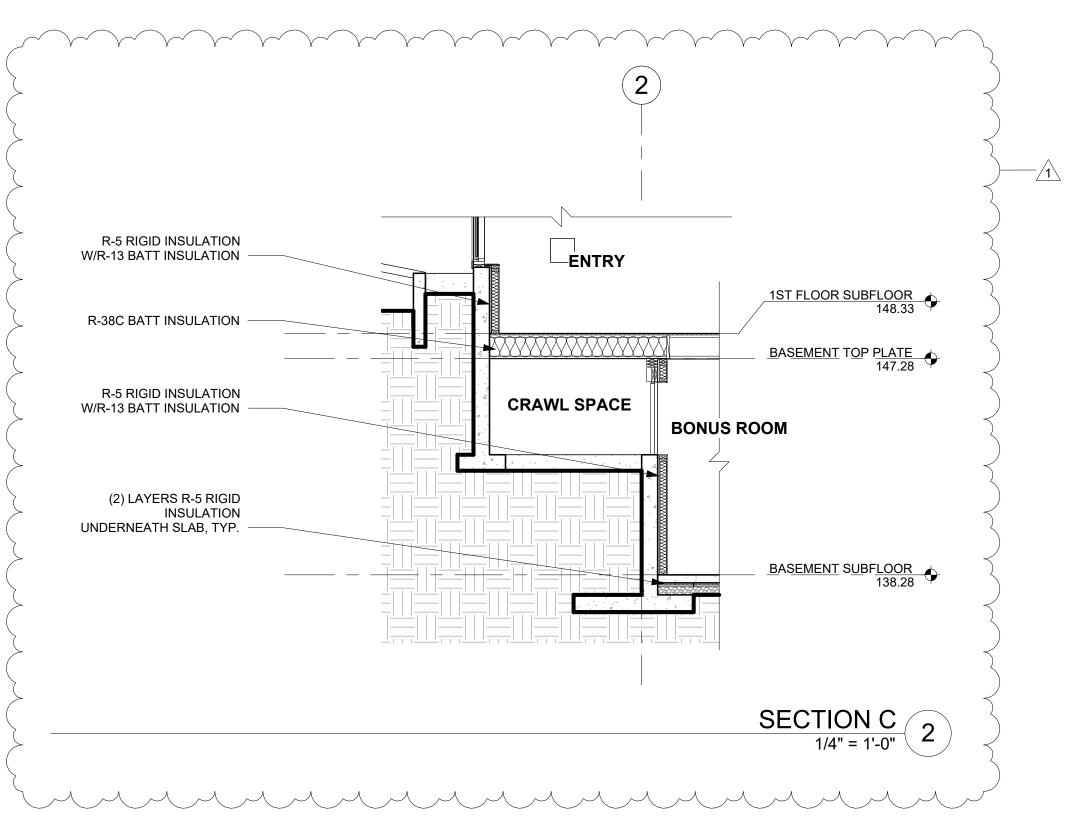
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THERMAL INSULATION

SLAB:

SKYLIGHTS:

WALLS (BELOW-GRADE): R-13 BATT INSULATION AND CONTINUOUS R-5 WALLS (ABOVE-GRADE): R-21 BATT INSULATION

HEADERS: R-10 RIGID INSULATION

CEILINGS (STANDARD FRAMING): R-49 BATT INSULATION

FLOORS: R-38 BATT INSULATION

R-10 RIGID AT PERIMETER & UNDER

WINDOWS & DOORS: U-VALUE OF .28 OR

BETTER

U-VALUE OF .50 OR BETTER

ENTIRE SLAB

KEY NOTES

018 TRENCH DRAIN: SEE DETAILS AND CIVIL. 023 SITE DRAINAGE AWAY FROM HOME PER IRC SECTION 401.3. SEE CIVIL DRAWINGS FOR FOUNDATION DRAINAGE SPECIFICATIONS.

CONCRETE SLAB (4" MIN. OR PER STRUCTURAL) OVER GRAVEL OR CRUSHED ROCK (4" MIN. OR PER GEOTECH) OVER FIRM UNDISTURBED SOIL. REINFORCING PER STRUCTURAL. EXTERIOR SLABS TO RECEIVE BROOM

FINISH AND TO SLOPE 1/4" PER FOOT AWAY FROM BUILDING. GUARDRAIL, FASCIA MOUNT - DEFERRED SUBMITTAL. MIN. HEIGHT 36" PER IRC SECTION R312.1.2. REQUIRED GUARDS SHALL NOT HAVE OPENINGS FROM THE WALKING SURFACE TO THE REQUIRED GUARD HEIGHT WHICH ALLOW PASSAGE OF A SPHERE 4" IN DIAM. IRC SECTION R312.1.3 EXCEPTIONS: 1) THE TRIANGULAR OPENINGS AT THE OPEN SIDE OF STAIR, FORMED BY RISER, TREAD AND BOTTOM RAIL OF A GUARD, SHALL NOT ALLOW PASSAGE OF A SPHERE OF 6" IN DIAM. 2) GUARDS ON THE OPEN SIDE OF STAIRS SHALL NOT HAVE OPENINGS WHICH ALLOW PASSAGE OF A SPHERE 4-3/8" IN DIAM. PER TABLE R301.5 MINIMUM UNIFORMLY DISTRIBUTED LIVE LOADS - GUARDRAIL AND HANDRAIL 200 PER SQUARE FOOT. CONNECTIONS PER STRUCTURAL TYPICAL GUARDRAIL DETAILS.

225 PT DECK FRAMING PER STRUCTURAL W/ 2x CEDAR DECKING. MAINTAIN 1/8" GAP BETWEEN DECKING MEMBERS.

TRUSS FRAMING PER STRUCTURAL PLAN.

5/8" GWB @ CEILINGS, TYP.

TJI FRAMING PER STRUCTURAL PLAN.

2x6 STUD EXTERIOR WALL ASSEMBLY: SIDING PER ELEVATION OVER WATER-VAPOR PERMEABLE AIR-BARRIER OVER SHEATHING PER STRUCTURAL. R-21 INSULATION WITH 1/2" GYP INSIDE, TYP.

510 R-38 BATT INSULATION @ FLOORS BETWEEN HEATED AND UNHEATED

SPACES TYP. R-49 BATT INSULATION W/ BAFFLE TO ENSURE 1" MIN. GAP FOR CROSS

VENTILATION, TYP. USE COMBINATION OF R38C & R11 OR BUILD-UP OF RIGID INSULATION WHERE NECESSARY.

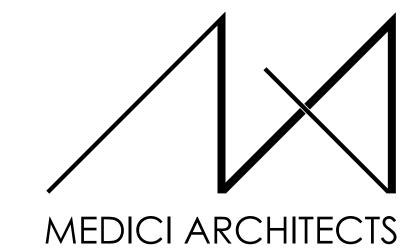
515 R-10 RIGID INSULATION @ HEADERS, TYP. FOOTINGS PER STRUCTURAL PLANS.

518 EAVE TO RECEIVE BLOCKING WITH (4) 2 1/2" VENTING HOLES PER 24" PROVIDING 7.35 S.I. OF VENTILATION PER LINEAR FOOT. SEE ROOF PLAN AND

RIDGE TO RECEIVE CONTINUOUS VENT. SEE ROOF PLAN.

2X ROOF FRAMING AND CONNECTIONS PER STRUCTURAL PLAN. BEAM AND CONNECTIONS PER STRUCTURAL PLAN.

527 STEP BEYOND.



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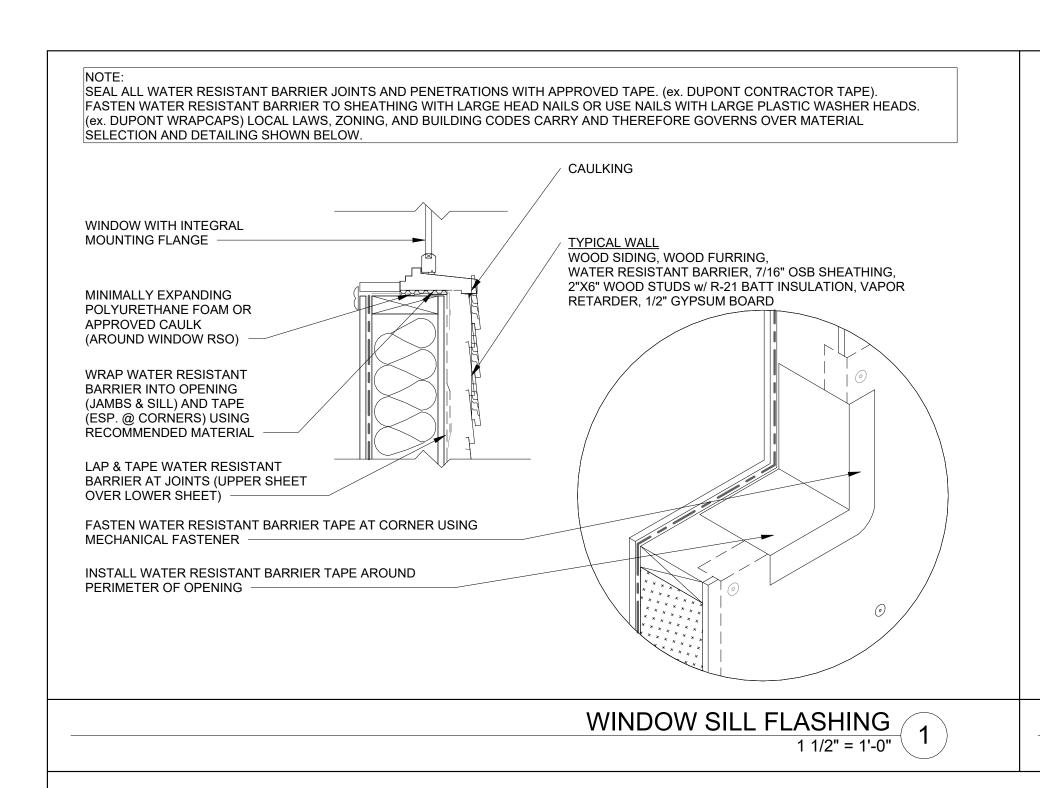
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OVERVIEW OF WINDOW WRAP INSTALL SEQUENCE

INSTALL WRB CORNERS @ SILL. ATTACH WITH STAPLES
OR AS REQUIRES BY BUILDING
TYPE.

INSTALL 3" WRB TAPE OVERLAP OF WRB

@ HEAD. ATTACH WITH STAPLES AS REQUIRED BY BUILDING TYPE.

NOTE: SPECIFIC TO VRAPROSHEILD: FOR AIR BARRIER DESIGN, USE WRAPSHIELD WITH VAPROTAPE @ ALL MEMBRANE JOINTS (HORIZONTAL AND VERTICAL).

WRB FLASHING WITH SINGLE-SIDED APPROVED WRB TAPE ALONG

AND JAMBS ONLY. ROLL TO ACTIVATE ADHESIVE.

NOTE: ALL WINDOW MATERIALS MUST

HARDIE WRAP PRODUCTS.

INSTALLATION OF WRB / LAP @ HORIZONTAL JOINTS & VERTICAL JOINTS PER WRB MANUFACTURER INSTALLATION INSTRUCTIONS SEAL FIELD MEMBRANE WITH WRB-TAPE OVER JAMB FLASHING.

DESIGN, USE WRAPSHIELD

WITH VAPROTAPE @ ALL MEMBRANE JOINTS
STEP 9b OF 10. (HORIZONTAL AND VERTICAL).

BE COMPATIBLE WITH VAPROSHEILD, TYVEK AND

CUT INSIDE EDGES OF-

ADHESIVE TO ATTACH
WRB AND CORNERS TO STEE

STEP 2 OF 10.

STEP 5 OF 10.

STEP 8 OF 10.

NOTE: UPPER WALLSHIELD / WRAPSHIELD FIELD MEMBRANE MUST LAP OVER LOWE

MEMBRANES, SHINGLE FASHION.

INSTALL SILLSAVER PAN, AND SPACERS @ 6" O.C. TO SILI

ROUGH OPENING.(MIN.)

NOTE: USE APPROVED WRB ADHESIVE TO ATTACH WRB AND CORNERS TO STEEL

INSTALL WRB LASHING @ HEAD.

NOTE: SOME WINDOW MFG'S REQUIRE CONTINUOUS SUPPORT @ SILL.

SPECIFIC TO VAPROSHEILD: FOR

WRAPSHIELD AIR BARRIER DESIGN,

LEG OF METAL HEAD FLASHING WITH VAPROFLASHING HEAD FLASHING.

NOTE: SPECIFIC TO VAPROSHIELD: FOR AIR BARRIER DESIGN, USE

WRAPSHIELD WITH VAPROTAPE @ ALL MEMBRANE JOINTS

MIN. 28 GA. PRE-FINISHED METAL HEAD FLASHING WITH FOLDED-END DAMS. (BY OTHERS).

SLIP WRAPSHIELD / WALLSHIELD

FIELD MEMBRANE UNDER

WRB FLASHING & SILL.

TO INTERIOR FRAMING.

- COMPATIBLE WITH TYVEK, VAPROSHEILD AND

STEP 1 OF 10.

NOTE: LAP JAMB FLASHING OVER END DAMS OF SILLSAVER PAN.

NOTE: INSTALL & SECURE WINDOW

ACCORDANCE WITH WINDOW MFG'S

STEP 7 OF 10.

HARDIE WRAP SYSTEMS

DO NOT ATTACH LOWER 6" EDGE @ THIS STEP. ATTACH

STAPLES OR AS REQUIRED BY

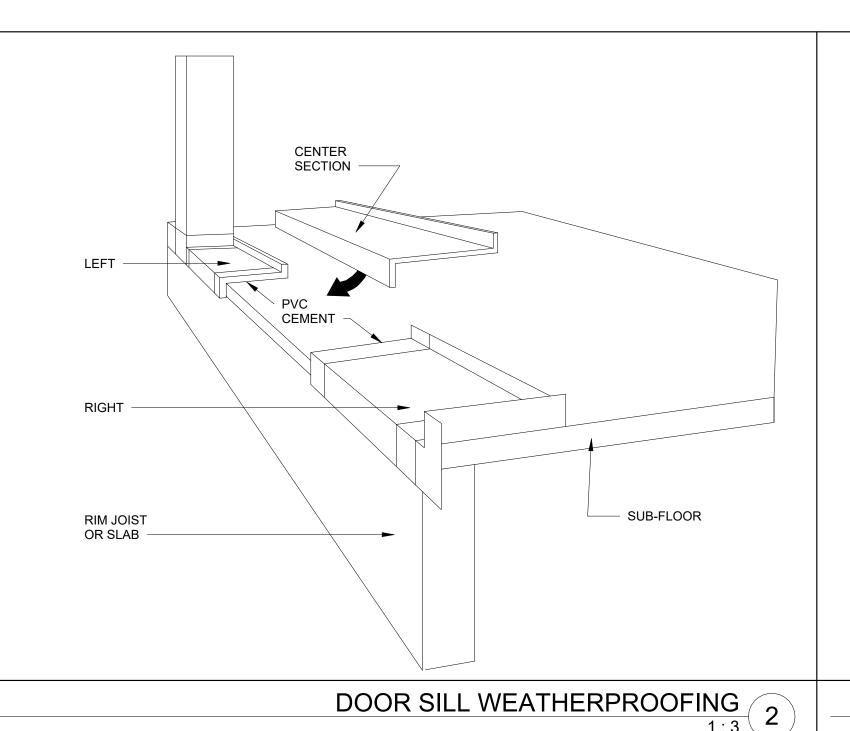
INSTALL WRB @ JAMBS. — ATTACH WITH STAPLES OR

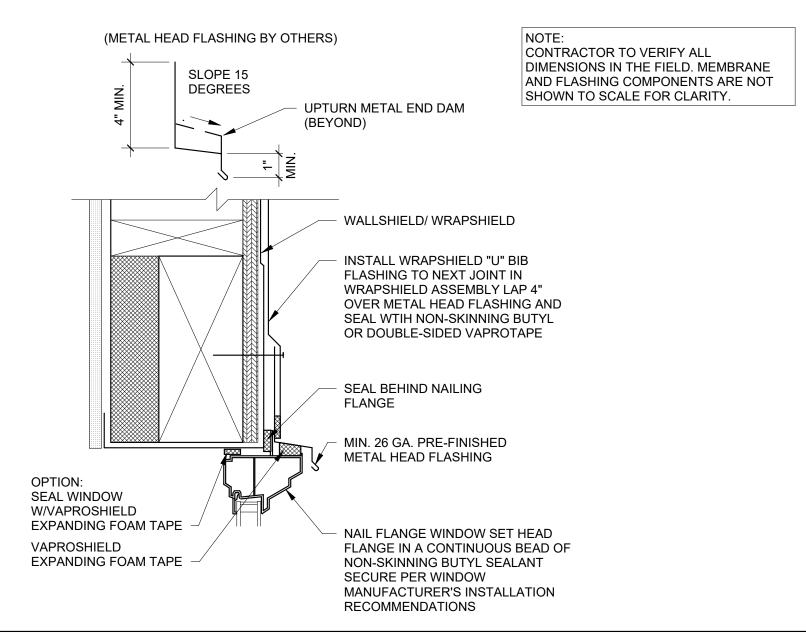
REQUIRED BY BUILDING TYPE.

ADD A CONTINUOUS SEALANT BEAD @ THE BACK OF THE SILLSAVER PAN

ALONG THE PAN/END DAM

PROTECT WALL ASSEMBLY FROM MOISTURE.





TYPICAL WALL

WOOD/COMPOSITE SIDING

WOOD FURRING

WINDOW & DOOR HEADER FLASHING
3" = 1'-0"
3

11711 SE 8TH STREET 200 W. RIVER ST. SUITE 100 SUITE 301 KETCHUM, ID 83340 BELLEVUE, WA 98005 TEL: (425) 453-9298 TEL: (208) 726-0194 **REGISTRATION:**

MEDICI ARCHITECTS

9/28/2023 **INTAKE DATE: REVISIONS:** DATE:

PROJECT / CLIENT: 2436 74TH AVE SE - SFR

LNL BUILDS

PROJECT ADDRESS: 2436 74TH AVE SE MERCER ISLAND, 98040

DRAWING NAME:

DETAILS - ENVELOPE

DRAWN BY: DRA CHECKED BY: JWH

CONSTRUCTION DRAWINGS

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APPROVED FOR CONSTRUCTION:

PROJECT No.: A22 087 DATE: 5/28/2024

WATER RESTANT BARRIER SHEATHING PER STRUCTURE

2"X6" WOOD STUDS R-21 BATT INSULATION VAPOR RETARDER 1/2" GYPSUM BOARD LAP AND TAPE MOISTURE BARRIER AT

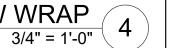
SPECIFICATIONS. 2. ALL DIMENSIONS ARE CONSIDERED TRUE AND REFLECT MANUFACTURER'S SPECIFICATIONS.

1. INSTALLATION TO BE COMPLETED IN ACCORDANCE WITH MANUFACTURER'S

Wrap entire building with 15 lb asphalt-impregnated felt or approved weather-resistant barrier, field membrane apply in roll, spray or brush; Application Temperature Min.: 0° F; Max.: 130° F, Application Thickness 15 wet mils or more, Typical Cure Time1 <30 min., dry to touch; <8 hours, (wall temp) (110-130 sq. ft. / gal). Or other product approved by siding manufacture for specific siding material such as Hardie Panel siding.

1. INSTALLATION TO BE COMPLETED IN ACCORDANCE WITH MANUFACTURER'S SPECIFICATIONS 2. ALL DIMENSIONS ARE CONSIDERED TRUE AND REFLECT MANUFACTURER'S SPECIFICATIONS


WEATHER SHIELD - WINDOW WRAP




STEP 6 OF 10.

STEP 9a OF 10.

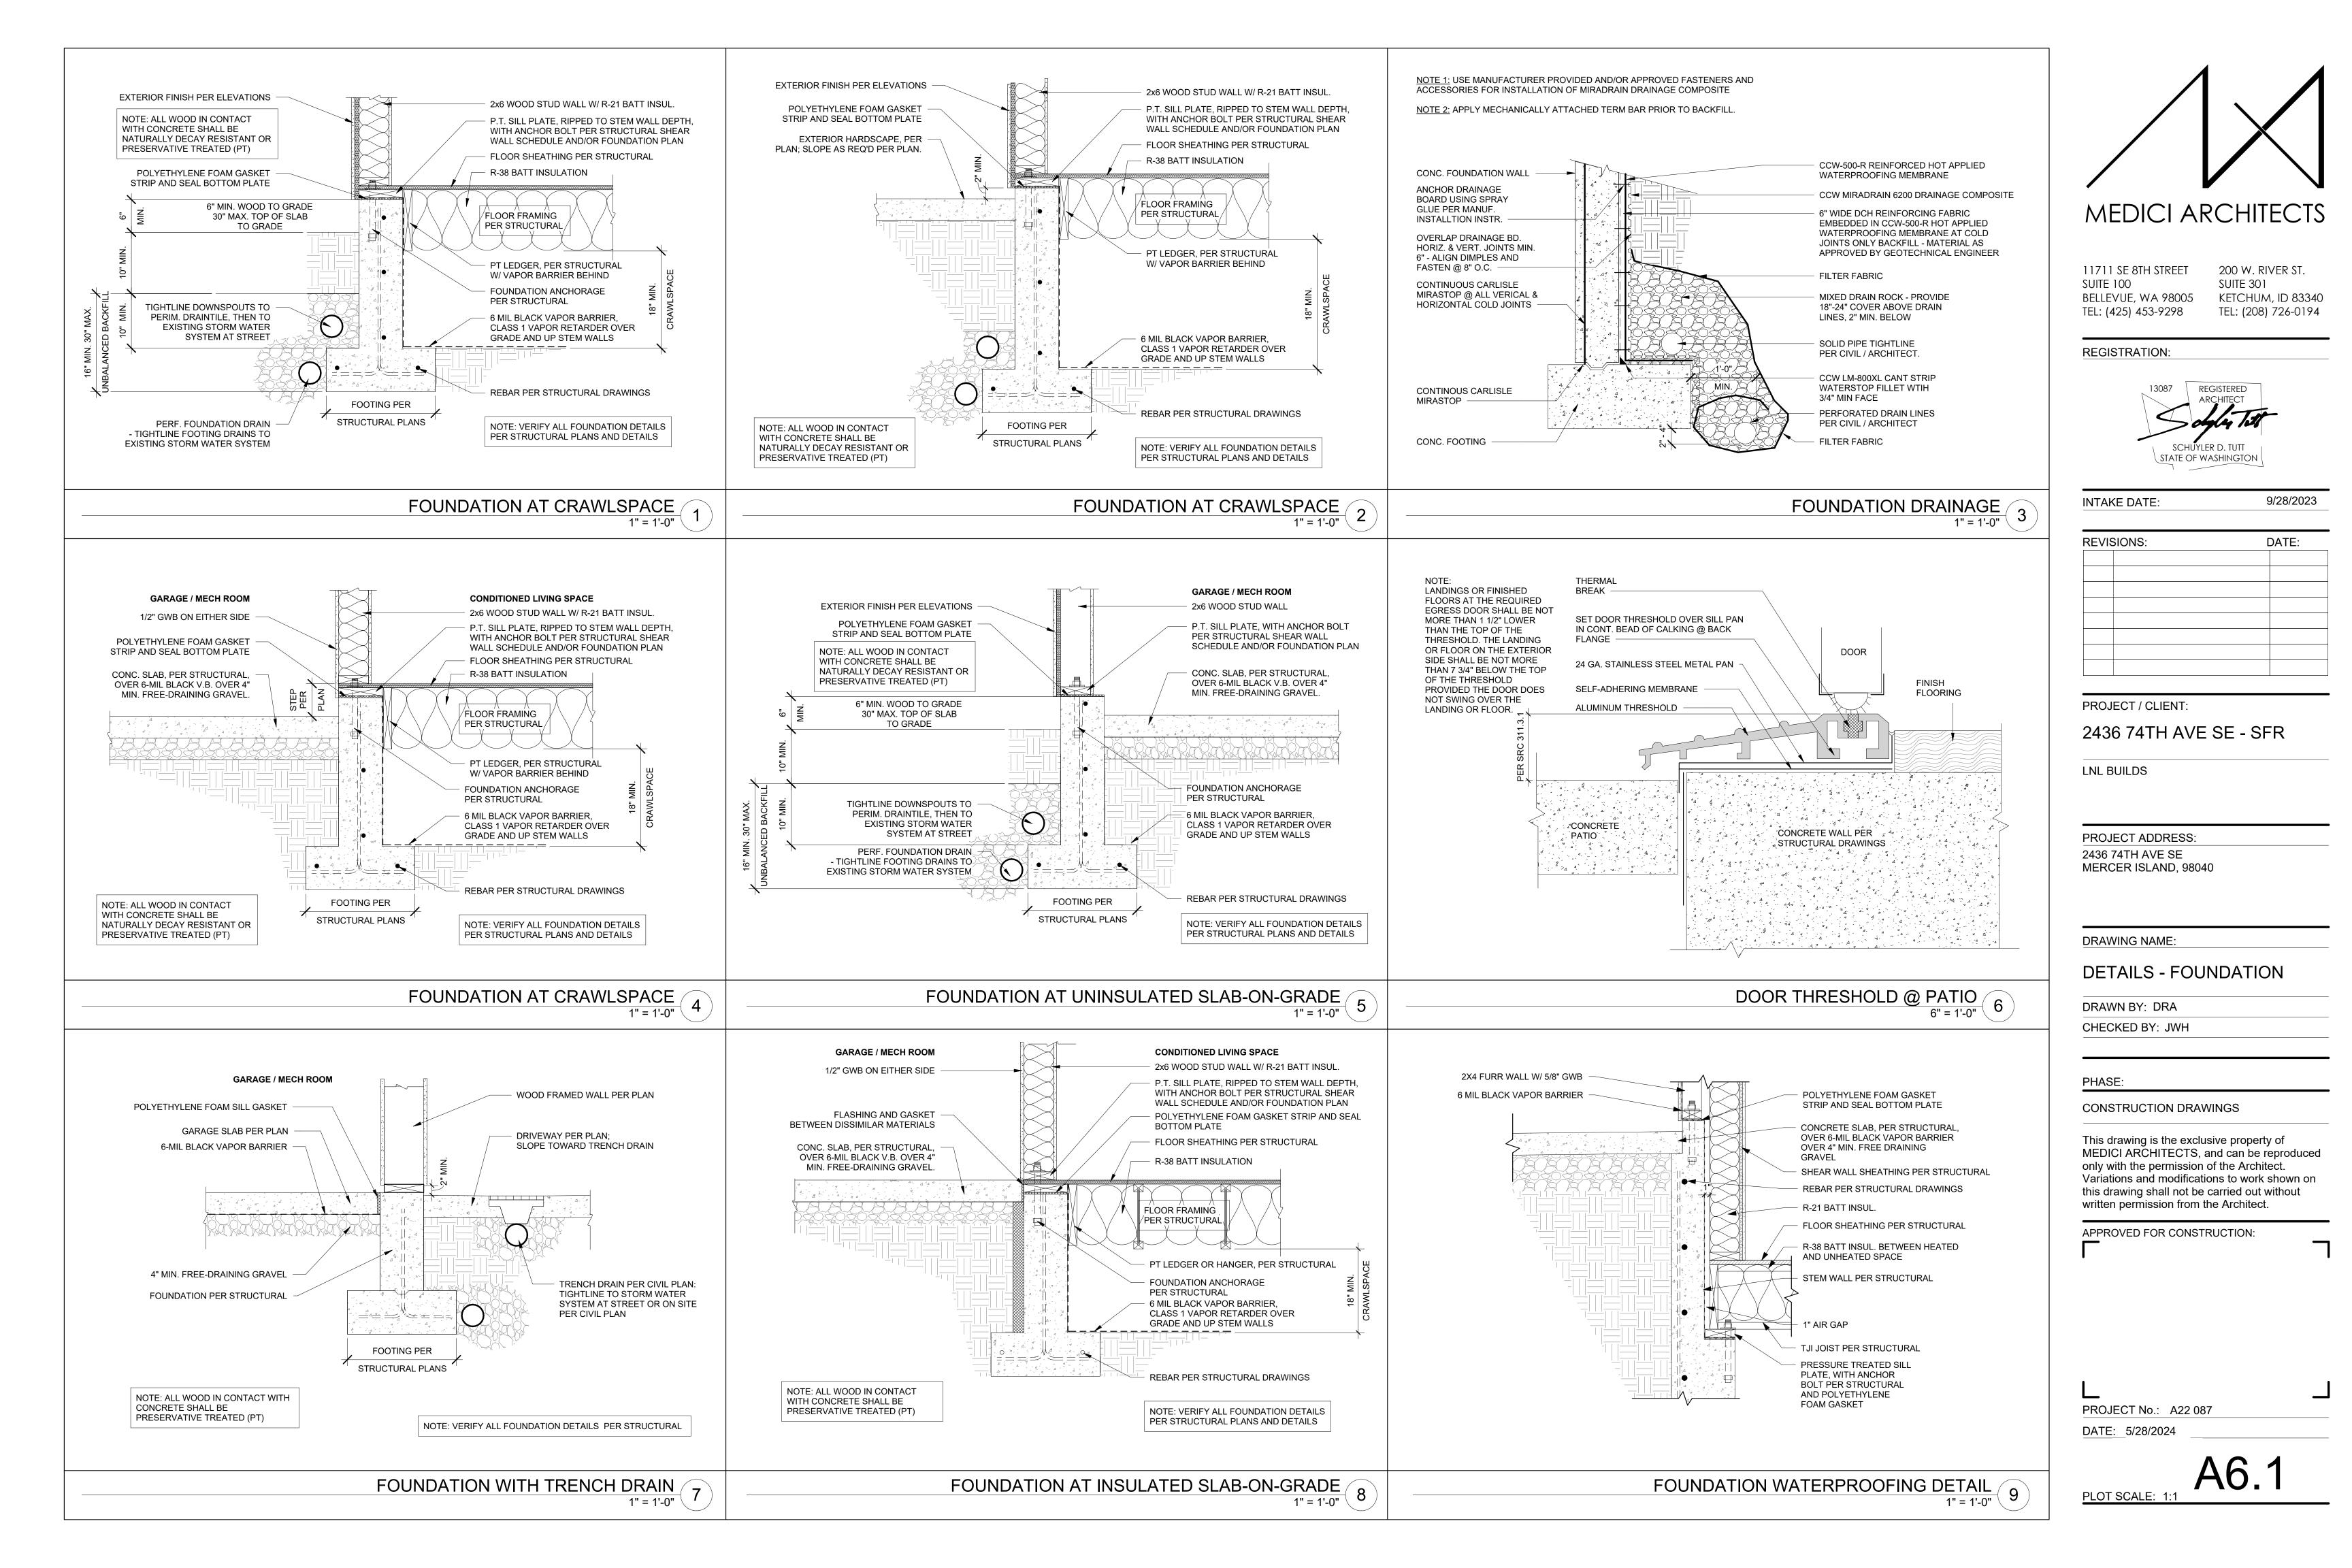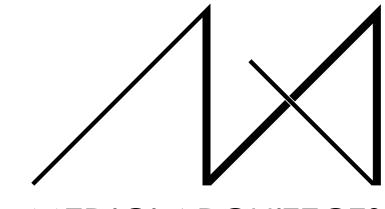WEATHER SHIELD SHIELD 5







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REGISTRATION:



9/28/2023 INTAKE DATE:

REVIS	SIONS: [DATE:

PROJECT / CLIENT:

2436 74TH AVE SE - SFR

PROJECT ADDRESS: 2436 74TH AVE SE MERCER ISLAND, 98040

DRAWING NAME:

DETAILS - FOUNDATION

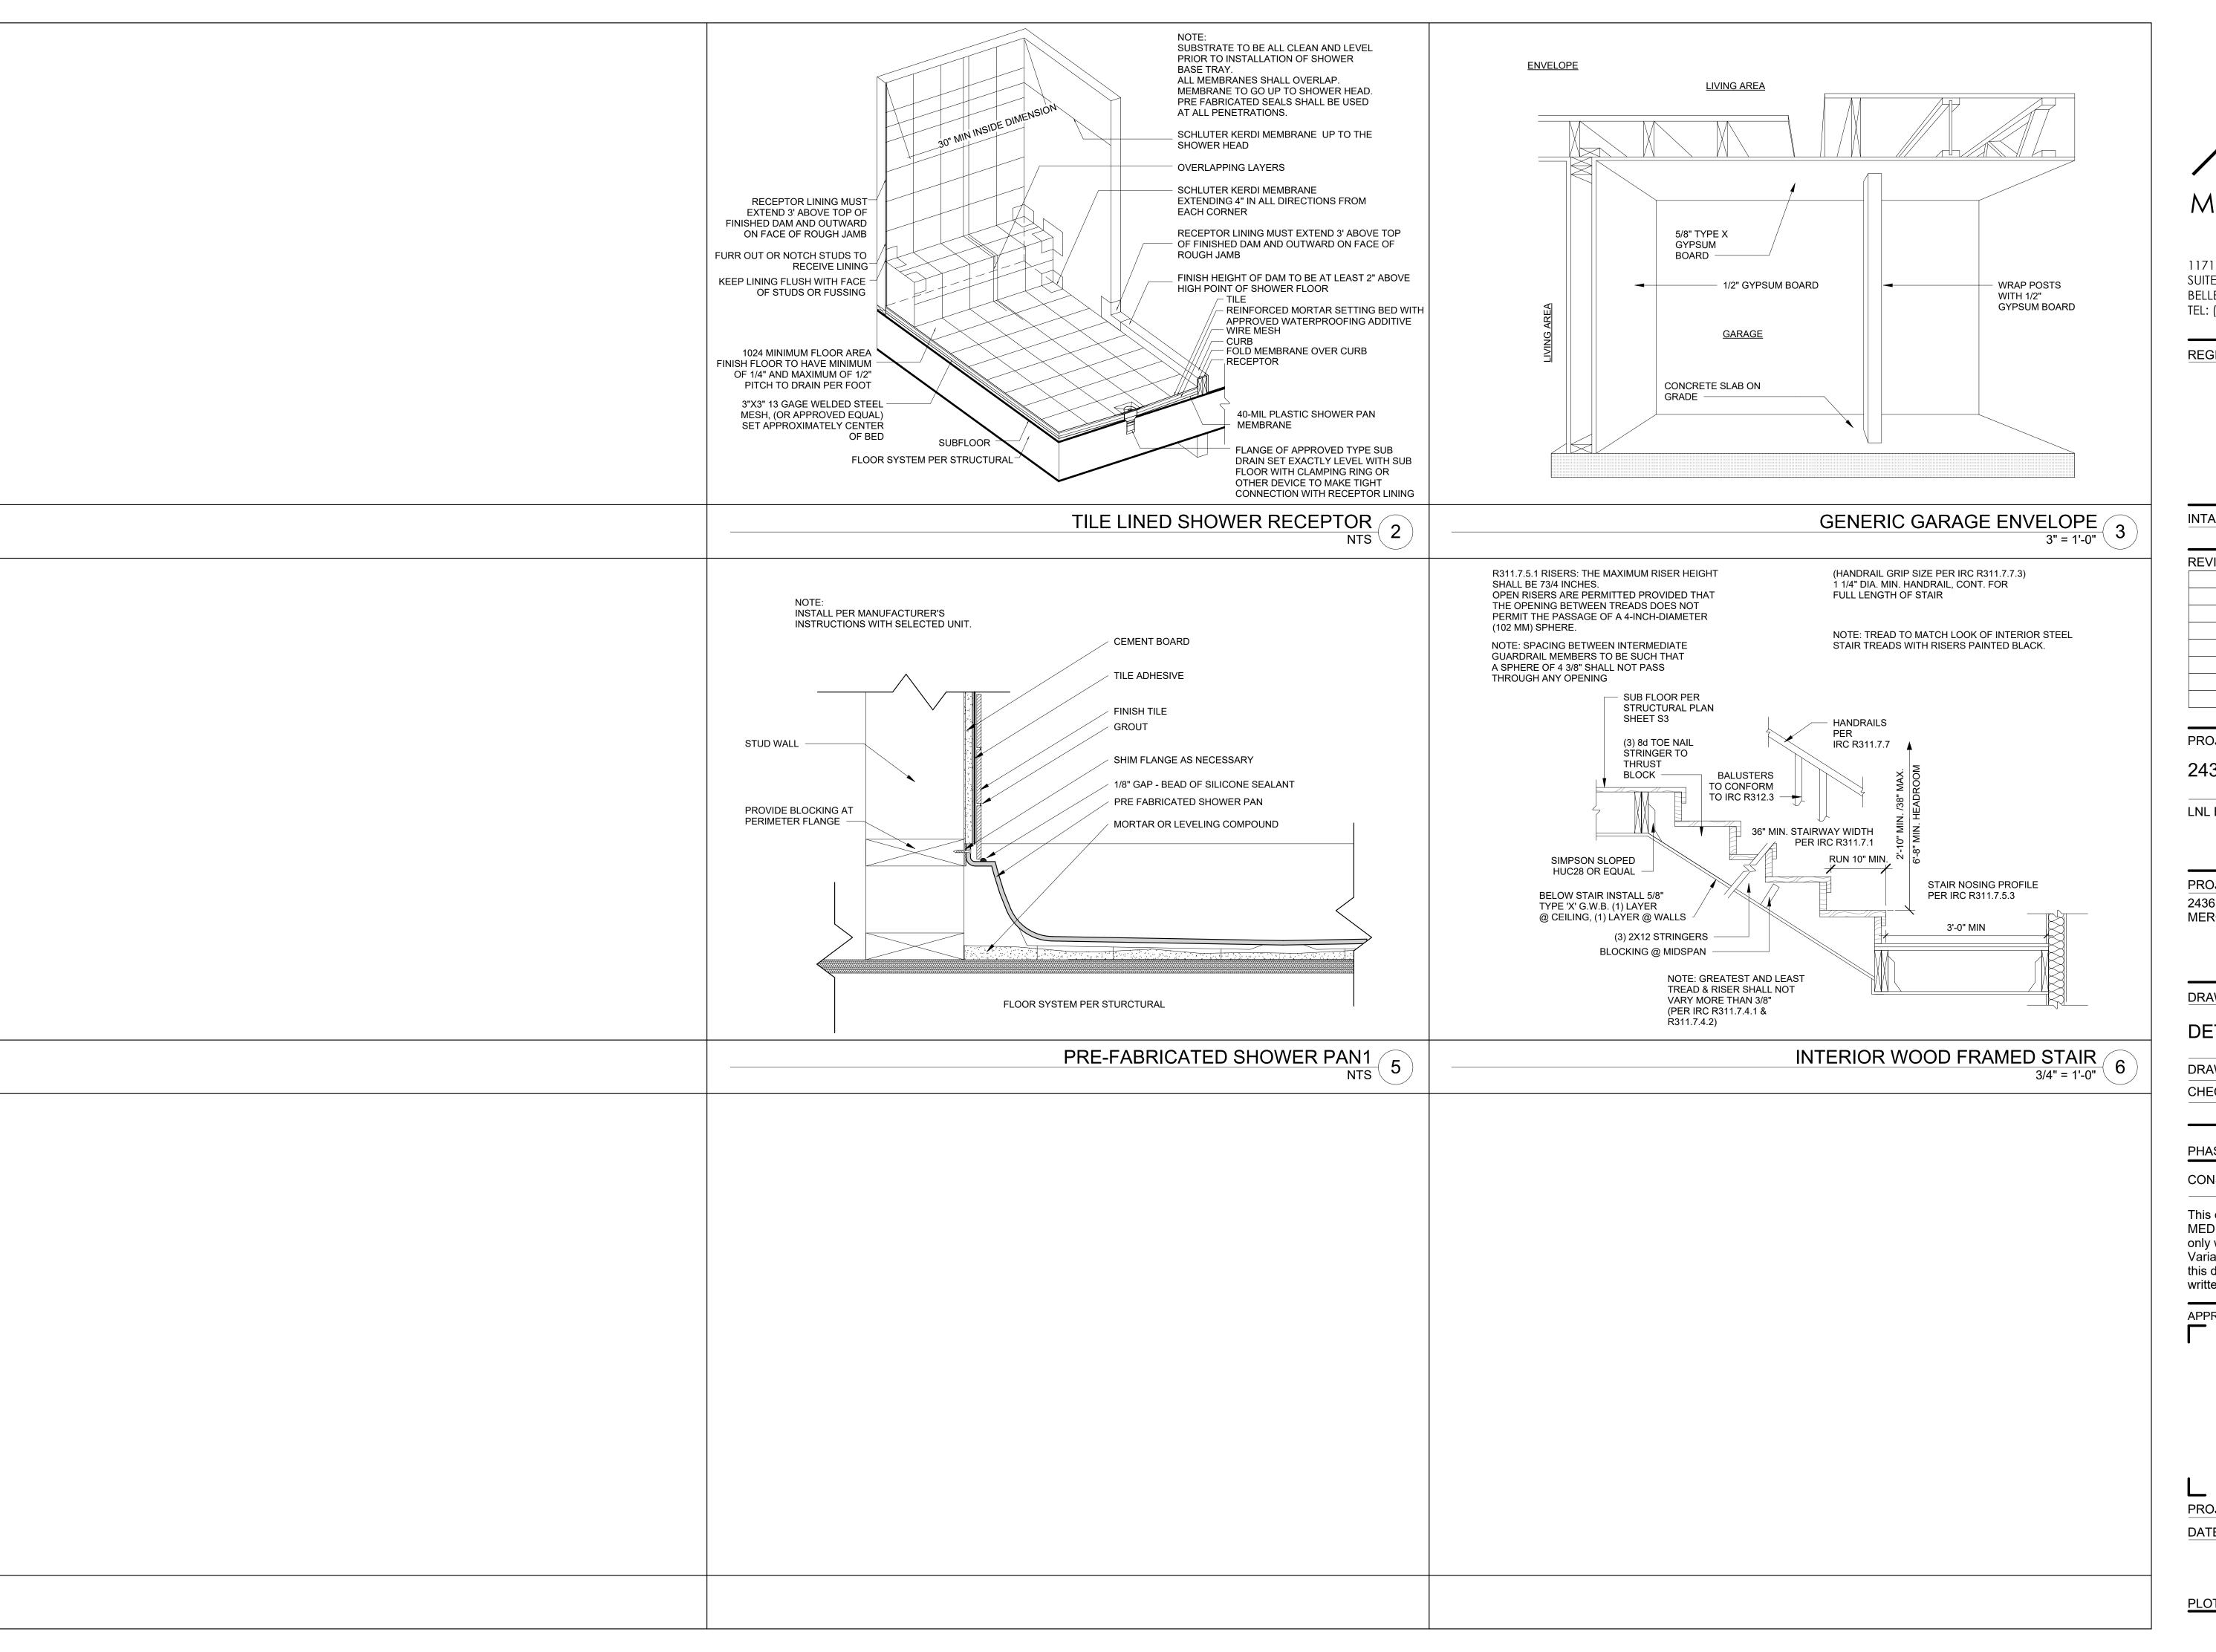
DRAWN BY: DRA CHECKED BY: JML

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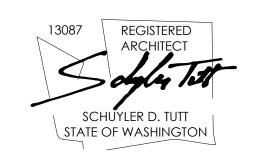
PROJE	CT No.:	A22 087	
DATE:	5/28/20	24	





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REGISTRATION:



INTAKE DATE: 9/28/20		
REVISIONS:	DATE:	

PROJECT / CLIENT:

2436 74TH AVE SE - SFR

LNL BUILDS

PROJECT ADDRESS: 2436 74TH AVE SE MERCER ISLAND, 98040

DRAWING NAME:

DETAILS - INTERIOR

DRAWN BY: DRA

CHECKED BY: JWH

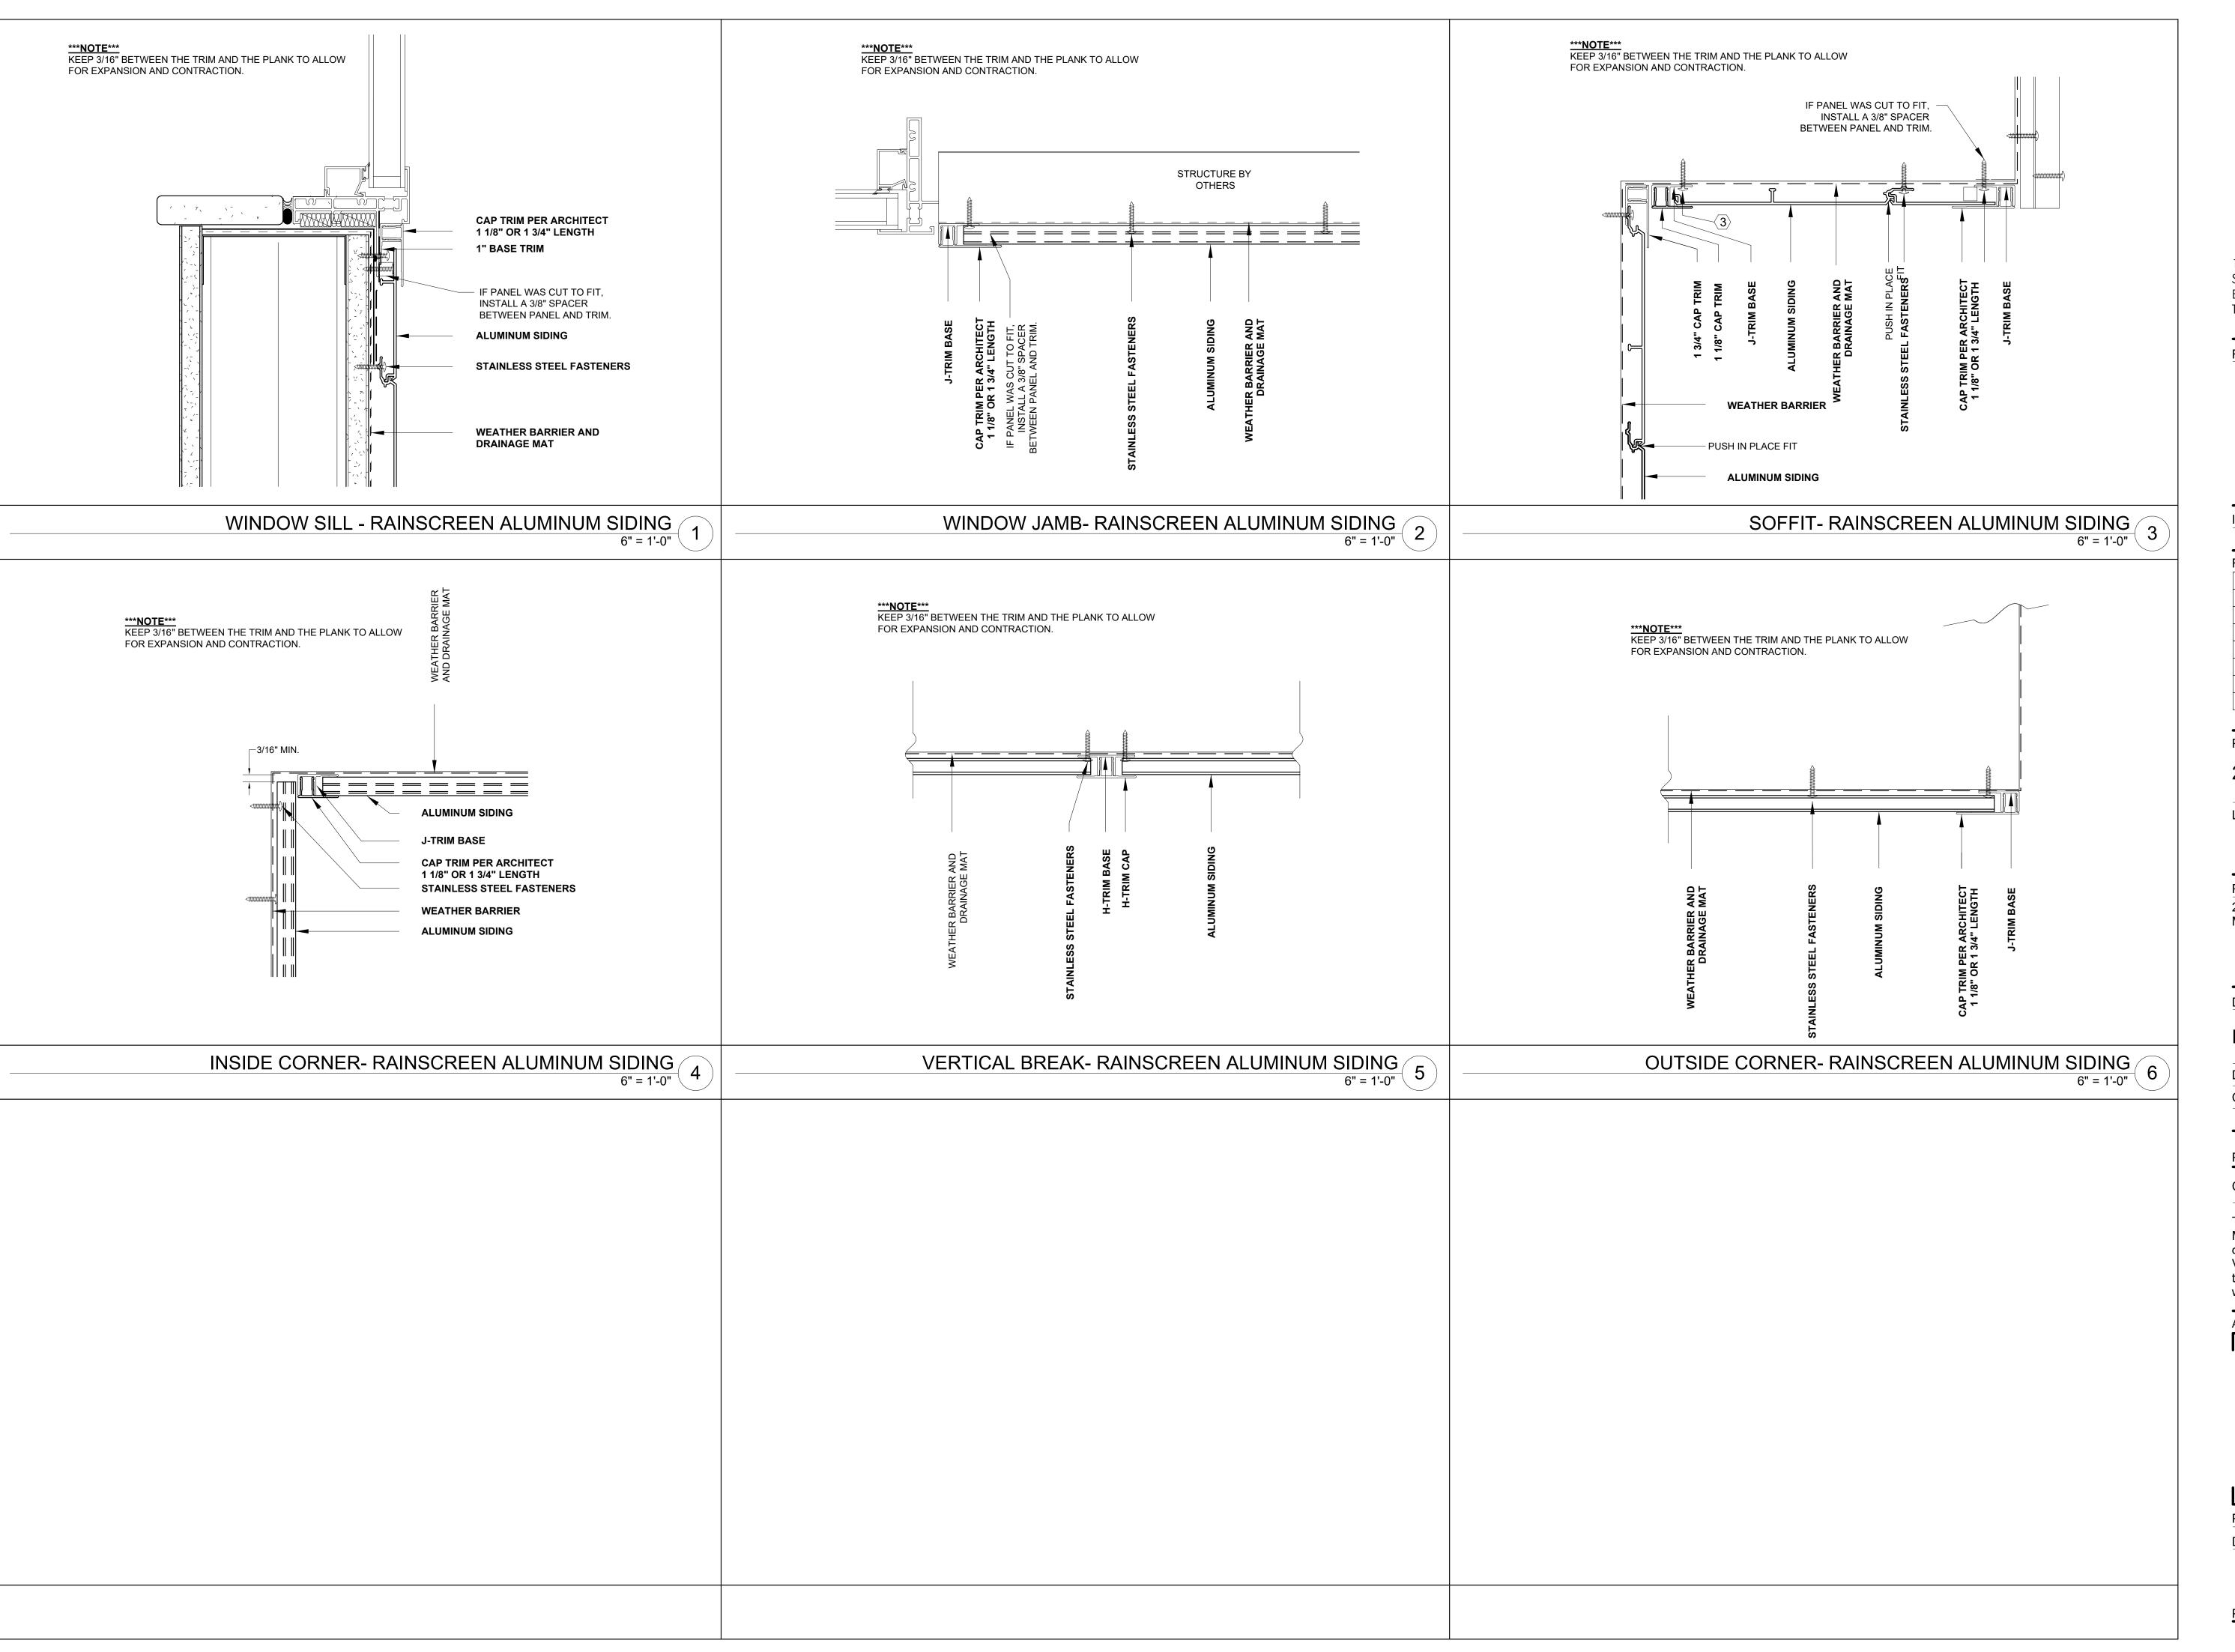
PHASE:

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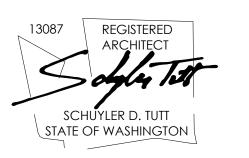
PROJECT No.: A22 087 DATE: 5/28/2024





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LNL BUILDS

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DRAWING NAME:

DETAILS - SIDING

DRAWN BY: DRA
CHECKED BY: JWH

PHASE

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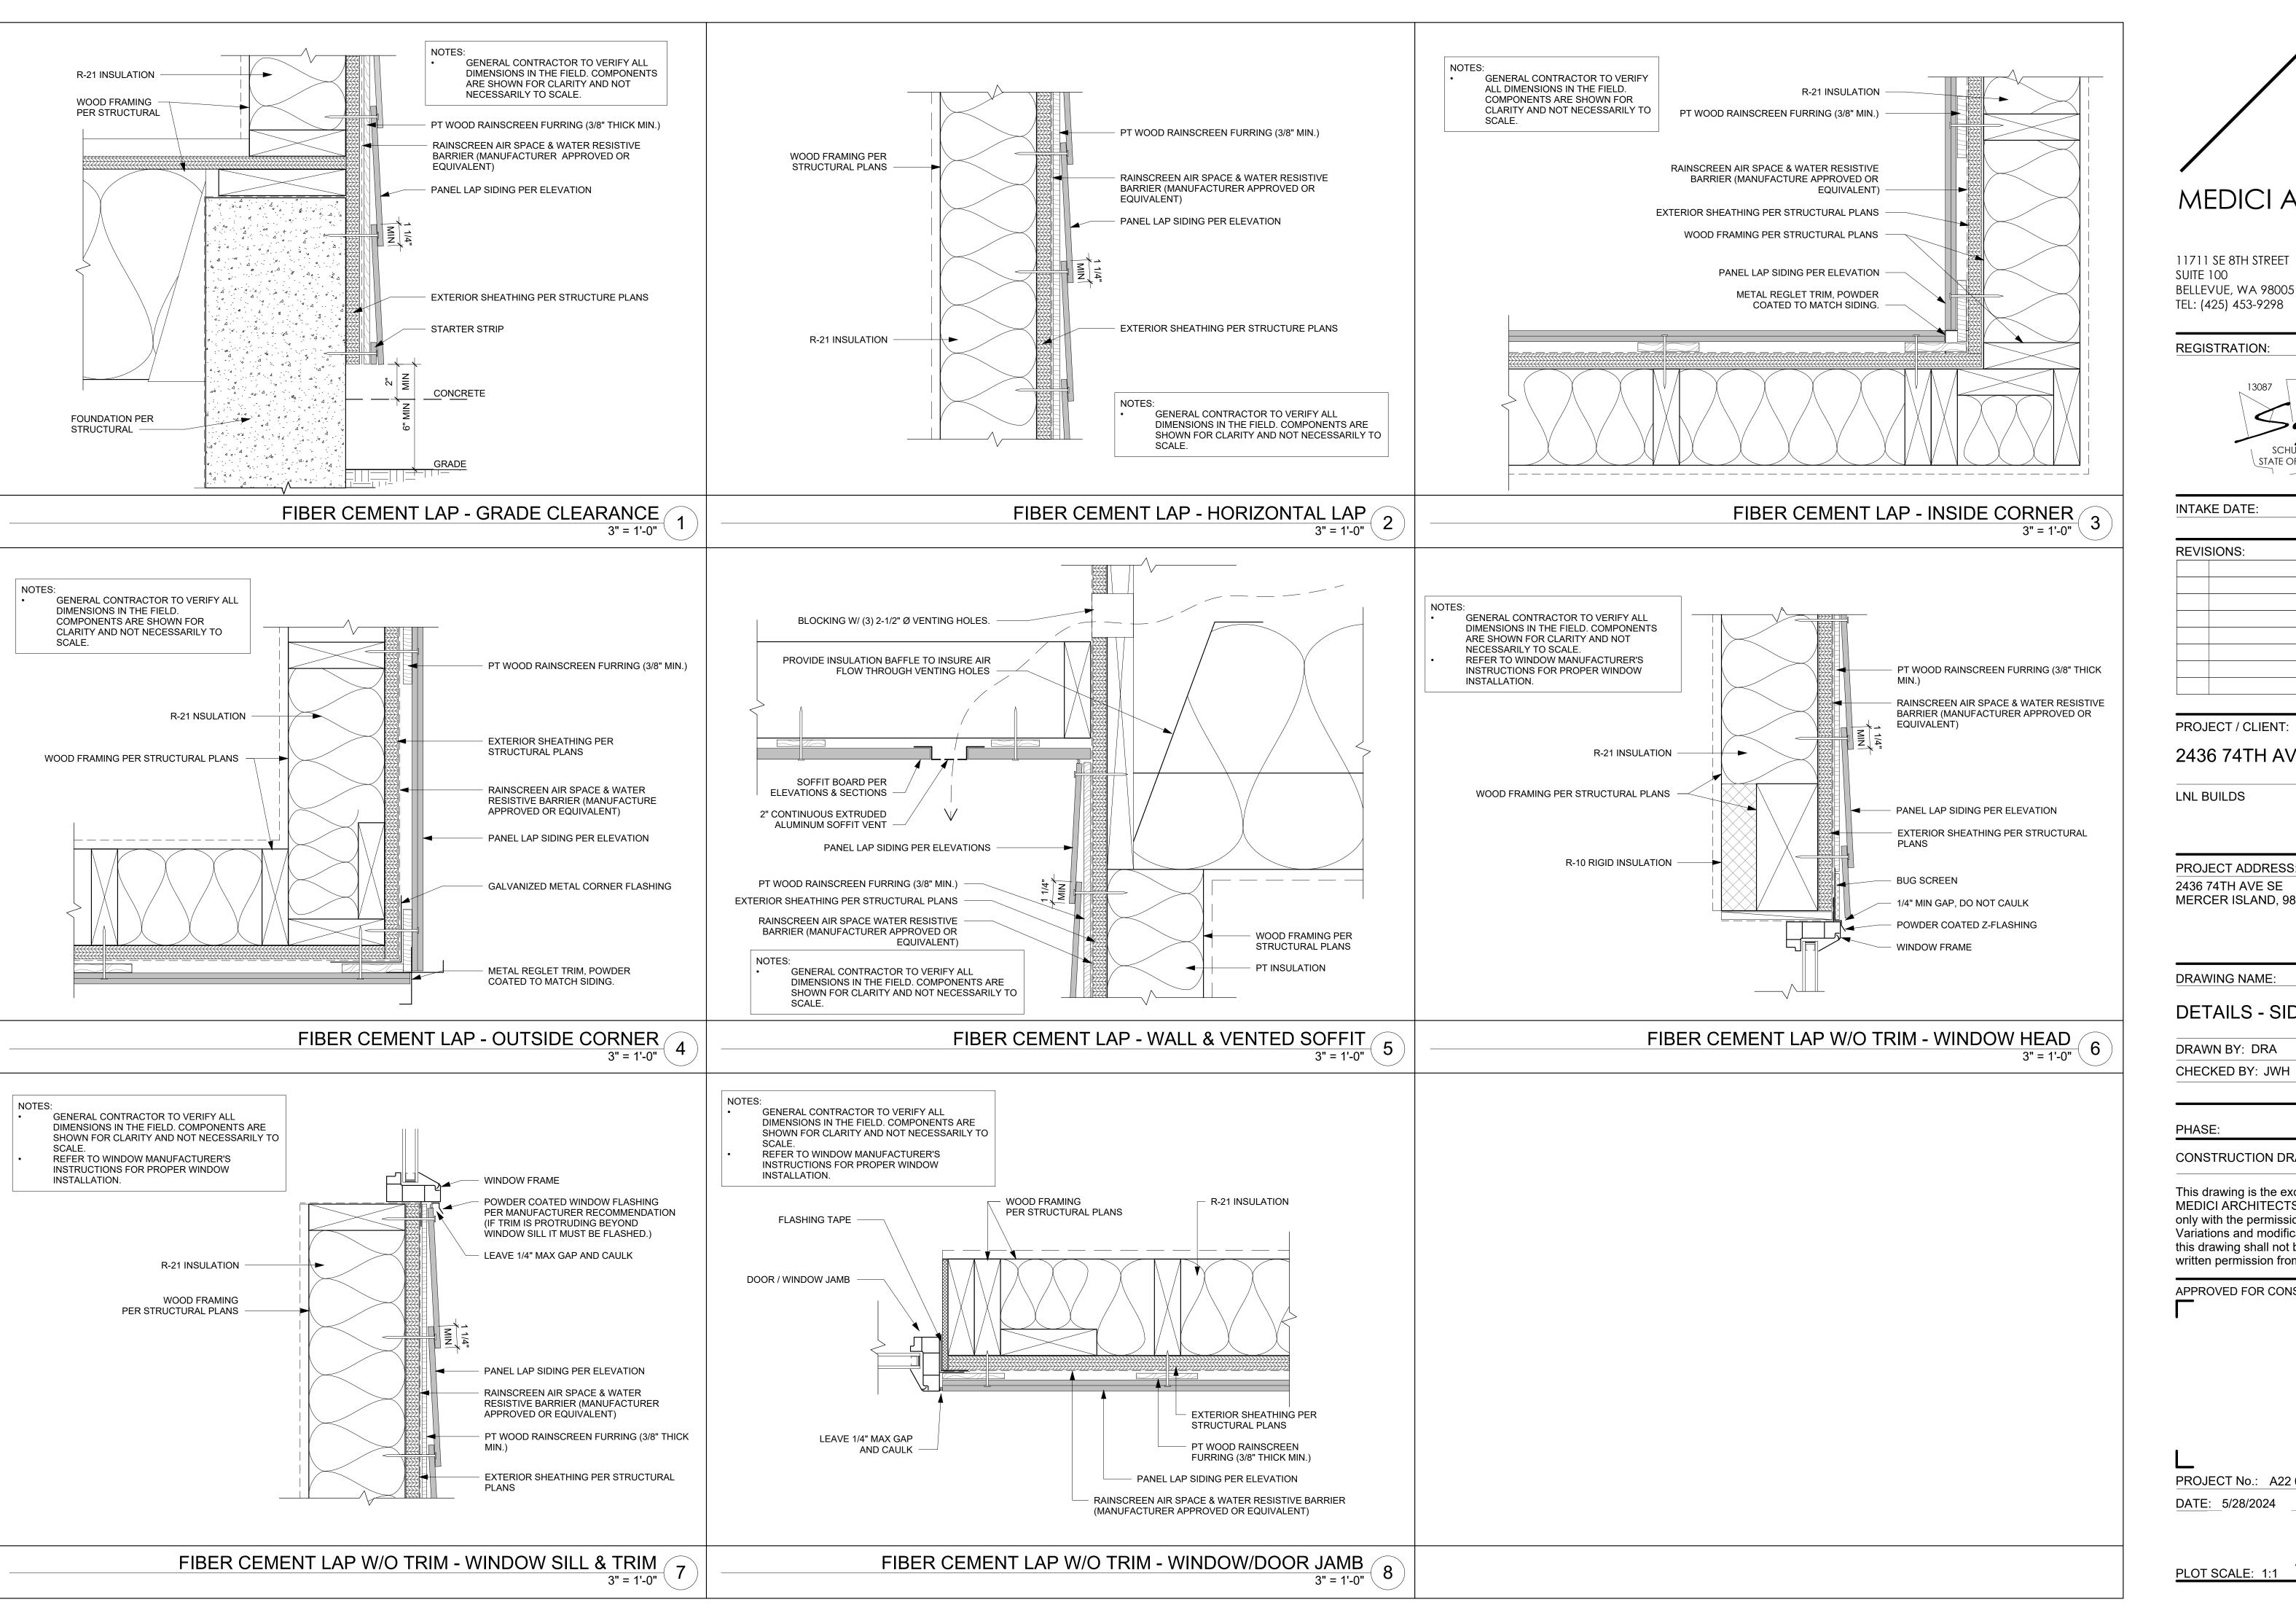
APPROVED FOR CONSTRUCTION:

6773654-CN

PROJECT No.: A22 087

DATE: 5/28/2024


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REVISIONS:	DATE:	

PROJECT / CLIENT:

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LNL BUILDS

PROJECT ADDRESS: 2436 74TH AVE SE MERCER ISLAND, 98040

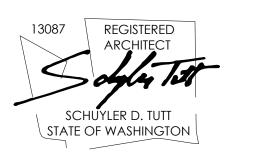DRAWING NAME:


DETAILS - SIDING


DRAWN BY: DRA

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200 W. RIVER ST.

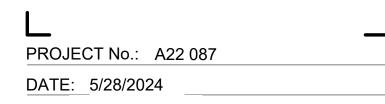REGISTRATION:



REVISIONS: DATE	INTAKE DATE:	9/28/2023	
REVISIONS: DATE			
	REVISIONS:	DATE:	

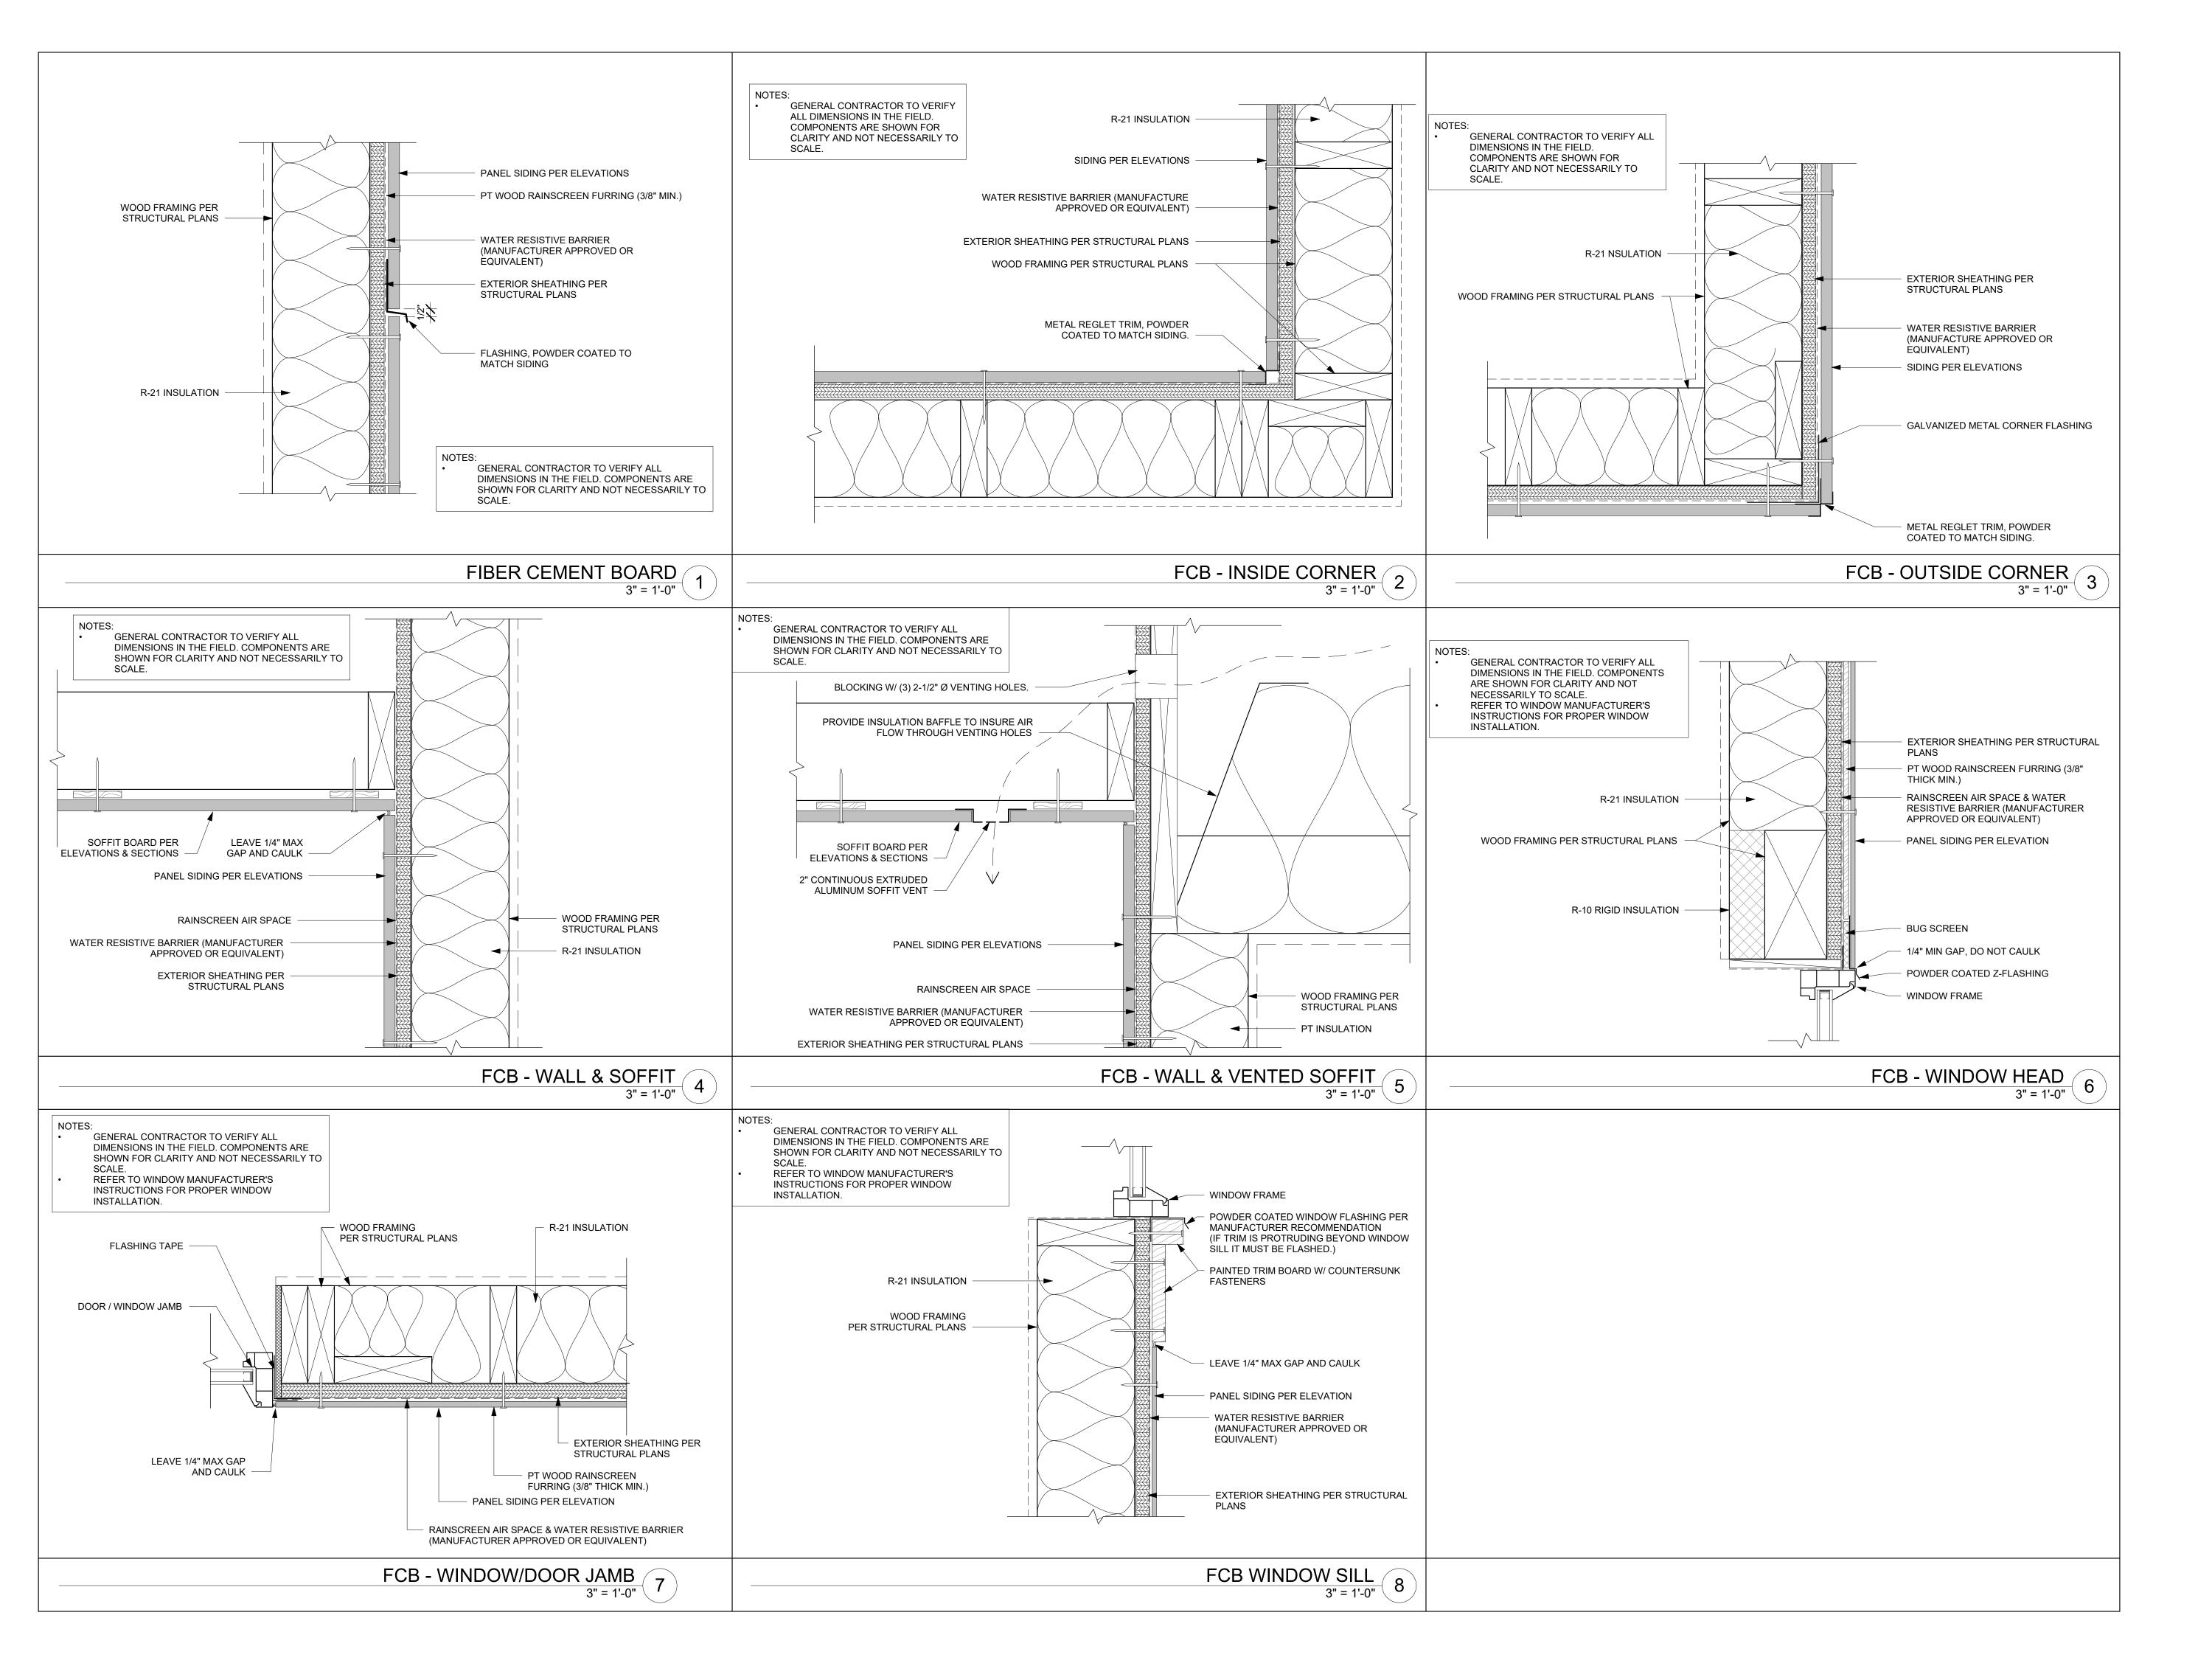PROJECT / CLIENT:

2436 74TH AVE SE - SFR

LNL BUILDS

PROJECT ADDRESS: 2436 74TH AVE SE MERCER ISLAND, 98040

DRAWING NAME:

DETAILS - SIDING

DRAWN BY: DRA CHECKED BY: JML

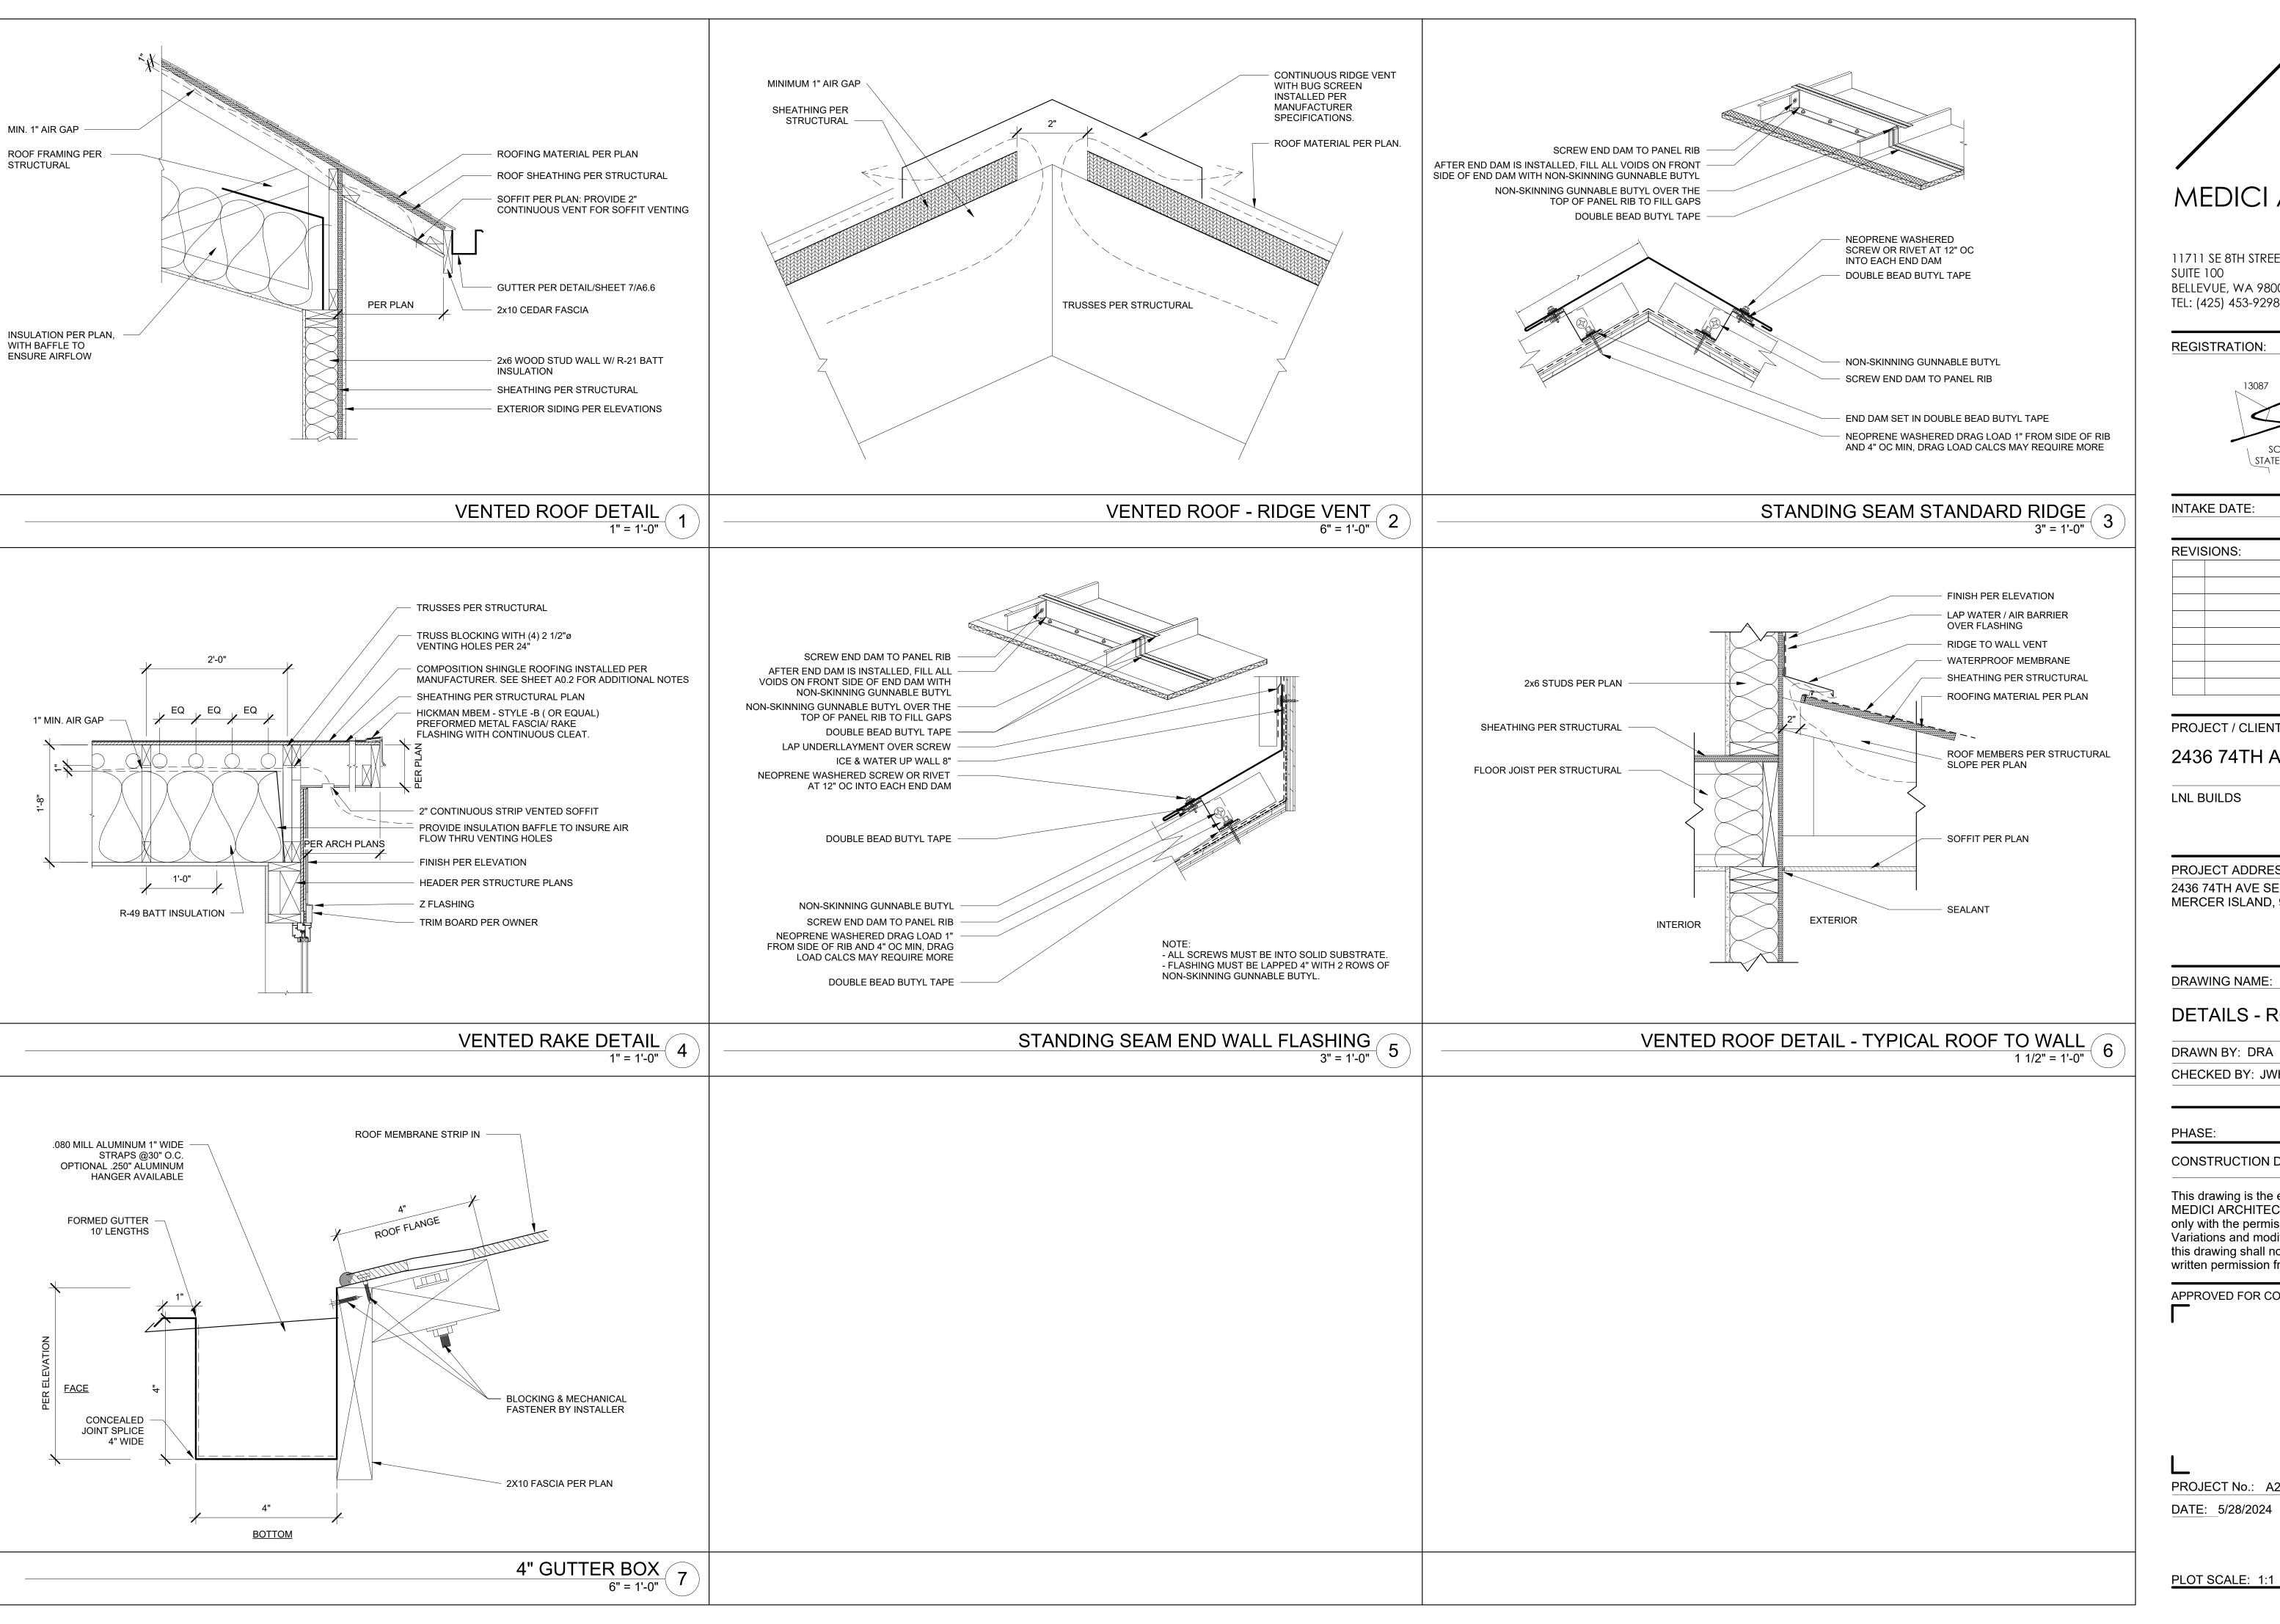
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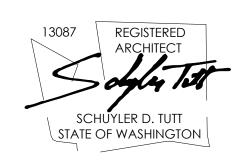
PROJECT No.: A22 087 DATE: 5/28/2024





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REGISTRATION:



INTAKE DATE: 9/2		9/28/2023
REVISIONS: DATE:		DATE:

PROJECT / CLIENT:

2436 74TH AVE SE - SFR

LNL BUILDS

PROJECT ADDRESS: 2436 74TH AVE SE MERCER ISLAND, 98040

DRAWING NAME:

DETAILS - ROOF

DRAWN BY: DRA

CHECKED BY: JWH

PHASE:

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APPROVED FOR CONSTRUCTION:

PROJECT No.: A22 087 DATE: 5/28/2024

GARAGE SLAB

4" CONC. SLAB ON GRADE ON 4" MIN. GRANULAR FILL ON 95% COMPACTED FILL/VIRGIN SOIL

BASEMENT SLAB

4" CONC. SLAB ON GRADE ON 8 MIL VAPOR BARRIER ON 4" MIN. GRANULAR FILL ON 95% COMPACTED FILL/VIRGIN SOIL

SLAB-ON-GRADE

4" CONC. SLAB ON GRADE ON 6 MIL VAPOR BARRIER ON 4" MIN. GRANULAR FILL ON 95% COMPACTED FILL/VIRGIN SOIL

GENERAL STRUCTURAL NOTES

FOUNDATION

• FOUNDATIONS HAS BEEN DESIGNED BASED ON GEOTECH REPORT PROVIDED BY EARTH SOLUTIONS NW LLC, DATED MAY 2, 2023.

 CONCRETE SHALL ATTAIN THE FOLLOWING MINIMUM COMPRESSIVE STRENGTHS IN 28 DAYS, U.N.O.:

> 2,500 psi: FOOTINGS* 2,500 psi: INTERIOR SLABS ON GRADE

3,500 psi: EXT. SLABS ON GRADE fu = 60,000 psi

• ALL CONCRETE EXPOSED TO THE WEATHER SHALL NOT HAVE LESS

THAN 5% OR MORE THAN 7% AIR ENTRAINMENT. • TYPICAL REINFORCEMENT DETAILS: LAP ALL REBAR 24" MIN.; BEND BARS AND LAP AT CORNERS, PROVIDE 6" HOOK INTO SUPPORTING

AT THE BOTTOM BARS AND 1 1/2" COVER AT THE SIDES. FOUNDATION WALLS SHALL BE BRACED, PRIOR TO BACKFILLING, B' EITHER ADEQUATE TEMPORARY BRACING OR INSTALLATION OF FIRST FLOOR DECK.

• ALL FOOTINGS SHALL BEAR BELOW FROST LINE. CONSULT SOILS REPORT/ LOCAL MUNICIPALITY FOR MINIMUM DEPTH BELOW GRADE. • FOOTINGS AND SLABS ON GRADE SHALL BEAR ON VIRGIN SOIL OR 95% COMPACTED FILL.

• PROVIDE CONTROL JOINTS AT ALL INSIDE CORNERS OF SLAB EDGES, AND OTHER LOCATIONS WHERE SLAB CRACKS ARE LIKELY TO DEVELOP. (15'-0" O.C.)

• FASTEN SILL PLATES TO FOUNDATION WALLS WITH 5/8" DIA. ANCHOR EMBEDMENT INTO CONC. PROVIDE A MINIMUM OF 2 ANCHORS PER PLATE, 12" MAXIMUM FROM PLATE ENDS, U.N.O. (SEE FND. DETAILS)

• BUILDER TO VERIFY CORROSION-RESISTANCE COMPATIBILITY OF HARDWARE & FASTENERS IN CONTACT W/ PRESERVATIVE-TREATED WOOD. CONTACT LUMBER & HARDWARE SUPPLIERS TO COORDINATE.

HEM FIR #2.

GRADE BEAM ON HELICAL PILINGS:

- PILES SHALL BE INSTALLED TO SUPPORT DESIGN LOAD OF
- PILING CONTRACTOR SHALL DETERMINE BY TEST PILE, THE LENGTH AND DIMENSIONS OF THE PILINGS REQUIRED TO REACH DESIGN LOAD CAPACITY.
- HELICAL PILE FOUNDATIONS (IBC 1704.10) SPECIAL INSPECTIONS OF ALL HELICAL PILE INSTALLATIONS SHALL BE PERFORMED IN ACCORDANCE WITH SECTION 1704.10 OF THE IBC. SPECIAL INSPECTIONS SHALL BE PERFORMED CONTINUOUSLY DURING INSTALLATION AND THE INFORMATION RECORDED SHALL INCLUDE, BUT NOT BE LIMITED TO:
- VERIFY PILE DIMENSIONS. (CONTINUOUS)
- A. VERIFY PILE PLACEMENT AND PLUMBNESS. B. RECORD FINAL DEPTH

E. DOCUMENT ANY DAMAGE TO PILE.

• DESIGN IS BASED ON 2018 INTERNATIONAL RESIDENTIAL CODE \$ 2018 INTERNATIONAL BUILDING CODE

f'c = 2,500 psi: FOUNDATION WALLS*

* UTILIZE 5/5" SACK 2500 PSI CONCRETE MIXES THAT ARE EQUIVALENT TO 3,000 PSI CONCRETE FOR WEATHERING POTENTIAL

FOOTINGS WHEN FOOTINGS INTERSECT; PROVIDE 3" MINIMUM COVER

BOLTS W/ MIN. 3"x3"x 1/4" PLATE WASHERS (EDGE OF WASHER TO BE LOCATED WITHIN 1/3" OF EXTERIOR EDGE OF SILL PLATE) & NUTS @ 6'-0" O.C. @ 2-STORY & 4'-0" O.C. @ 3-STORY CONDITIONS w/ 7" MIN. • ALL LUMBER EXPOSED TO WEATHER OR IN CONTACT W/ CONCRETE OR MASONRY FOUNDATION SHALL BE PRESERVATIVE TREATED

• ARCH/BUILDER TO VERIFY ALL DIMENSIONS

- TYPICAL GRADE BEAM SPECIFICATION: 16" DEEP x 16" WIDE (@ PERIM. WALLS) REINFORCED CONCRETE GRADE BEAM w/ (2) #4 BARS (EQUALLY SPACED) CONTINUOUS AT TOP & BOTTOM & #3 STIRRUPS @ 48" o.c. w/ 3" COVER.
- II TONS/PILE MINIMUM (SAFE LOAD) PER GEOTECH.

MATERIAL COMPLIANCE:

TEST PILE OBSERVATIONS VERIFY CAPACITIES OF PILES. (CONTINUOUS) PILE DRIVING OBSERVATIONS: OBSERVE PILE DRIVING OPERATIONS AND MAINTAIN INSTALLATION RECORDS FOR ALL PILES. (CONTINUOUS)

> C. RECORD FINAL INSTALLATION TORQUE D. RECORD PILE TIP ELEVATIONS.

O INDICATES LOCATION OF HELICAL PILE

LOADING AND DESIGN PARAMETERS

GRAVITY DESIGN LOADS: DEAD LOAD (PSF): ROOF RAFTERS (VAULTED): ROOF RAFTERS:

> FLOOR (I-JOISTS): LIVE LOAD (PSF): ROOF : RESIDENTIAL LIVING AREAS: RESIDENTIAL SLEEPING AREAS:

> > BALCONY LIVE:

SNOW LOAD: GROUND SNOW LOAD (Pg) (PSF): FLAT ROOF SNOW LOAD (P;) (PSF): SNOW EXPOSURE FACTOR (C.): SNOW LOAD IMPORTANCE FACTOR (I):

THERMAL FACTOR (C1):

LATERAL DESIGN LOADS:

WIND LOAD: (IBC 1609) SPEED (Vuit) (MPH) : WIND RISK CATEGORY IMPORTANCE FACTOR (Iw): EXPOSURE CATEGORY: INTERNAL PRESSURE COEFF. (GCp): ±0.18 TOPOGRAPHIC FACTOR (Kzt):

SEISMIC LOAD: (IBC 1613) SFISMIC RISK CATEGORY SEISMIC IMPORTANCE FACTOR (I.): MAPPED SPECTRAL RESPONSE: Sı: 0.485 Ss: 1.392

SITE OLASS: SPECTRAL RESPONSE COEFF. Sps: 0.928 Spi: 0.587 SEISMIC DESIGN CATEGORY: BASIC SEISMIC-FORCE-RESISTING SYS:

W/WOOD STRUCTURAL PANELS DESIGN BASE SHEAR (ULT.): TRANS: IIk SEISMIC RESPONSE COEFF. (Cs) (ADDITION) : TRANS: 0.143 LONG: 0.143

LIGHT FRAMED WALLS

RESPONSE MODIFICATION FACTOR (R): TRANS: 6.5 LONG: 6.5 ANALYSIS PROCEDURE USED: EQUIVALENT LATERAL FORCE

HOLD-DOWN SCHEDULE

SYMBOL SPECIFICATION SIMPSON STHD14 (RJ) HOLD-DOWN SIMPSON CSI6 STRAP TIE

(14" END LENGTH) SIMPSON MSTC40 STRAP TIE (CENTER STRAP ON FLOOR SYSTEM U.N.O.) SIMPSON MSTC66 STRAP TIE

MEANS & METHODS NOTES

(CENTER STRAP ON FLOOR SYSTEM U.N.O.)

THE STRUCTURE IS DESIGNED TO BE SELF SUPPORTING AND STABLE AFTER THE BUILDING IS FINISHED AND ALL PLAN, DETAIL, AND NOTE SPECIFICATIONS HAVE BEEN COMPLETED. IT IS THE CONTRACTOR'S SOLE RESPONSIBILITY TO DETERMINE THE ERECTION PROCEDURES AND SEQUENCE TO INSURE THE SAFETY OF THE BUILDING AND ITS COMPONENTS DURING CONSTRUCTION. THIS INCLUDES. BUT IS NOT LIMITED TO, THE ADDITION OF NECESSARY SHORING, SHEETING, TEMPORARY BRACING, GUYS, AND TIE-DOWNS. CONTRACTOR SHALL BE RESPONSIBLE FOR ALL SHORING AND BRACING REQUIRED TO STABILIZE AND PROTECT EXISTING AND ADJACENT STRUCTURES AND SYSTEMS DURING COURSE OF DEMOLITION AND CONSTRUCTION OF THE PROJECT.

STRUCTURAL DESIGN AND SPECIFICATIONS ASSUME THAT ALL SUPPORTING AND NON-SUPPORTING FLEMENTS IN CONTACT WITH FLOOR FRAMING ARE LEVEL, INCLUDING, BUT NOT LIMITED TO; FOUNDATIONS, SLABS ON GRADE, BEAMS, WALLS, AND NON-BEARING ELEMENTS. IT IS THE CONTRACTOR'S RESPONSIBILITY TO VERIFY LEVELNESS AND MAKE ADJUSTMENTS AS NECESSARY, INCLUDING CONSIDERATION OF THOSE AREAS THAT MAY BE WITHIN CONTRACTUAL, INDUSTRY, OR WARRANTY TOLERANCES.

ADDITIONAL NOTES FOR TRUSS & I-JOIST MANUFACTURER

ROOF TRUSS, FLOOR TRUSS AND ENGINEERED JOISTS SHALL BE DESIGNED TO MEET THE DIFFERENTIAL DEFLECTION CRITERIA BELOW, UNLESS NOTED OTHERWISE ON PLAN, MULHERN & KULP CANNOT BE HELD RESPONSIBLE FOR ANY STRUCTURAL ISSUES RELATED TO ANY BUILDING COMPONENT IF COMPONENT SHOP DRAWINGS ARE NOT SUBMITTED TO M&K FOR REVIEW PRIOR TO FABRICATION, DELIVERY, OR INSTALLATION.

TRUSSES SHALL BE DESIGNED SO THAT DIFFERENTIAL DEFLECTION BETWEEN ADJACENT PARALLEL TRUSSES OR GIRDER TRUSSES DOES NOT EXCEED THE FOLLOWING: A ROOF TRUSSES:

- 1/4" DEAD LOAD
- B. FLOOR TRUSSES, ATTIC TRUSSES, & I-JOISTS:
- 1/8" DEAD LOAD FLOOR TRUSSES & ATTIC TRUSSES ADJACENT TO FLOOR
- FRAMING BY OTHERS:
- LIMIT ABSOLUTE TRUSS DEFLECTION TO 3/16" DEAD LOAD. (NOT DIFFERENTIAL DEFLECTION)

LATERAL BRACING NOTES

THIS HOME HAS BEEN ENGINEERED TO RESIST LATERAL FORCES RESULTING FROM: 100 MPH WIND SPEED, EXP. B

(ASCE 7-16 WIND MAP, PER IRC R301.2.1.1)

RISK CAT. 2 & SEISMIC CAT. D2. 0 MPH WIND IN 2018 IRC MAP ENGINEERED DESIGN WAS COMPLETED PER 2018 IBC (SECTION 1609 \$ 1613) \$ ASCE 7-16, AS PERMITTED BY R301.1.3 OF THE 2018 IRC.

ACCORDINGLY, THIS HOME, AS DOCUMENTED AND DETAILED HEREWITHIN, IS ADEQUATE TO RESIST THE CODE REQUIRED LATERAL FORCES AND DOES NOT NEED TO CONFORM TO THE

STANDARD EXTERIOR WALL SHEATHING <u>SPECIFICATIONS</u>

PRESCRIPTIVE PROVISIONS OF R602.10.

(INTERIOR WALL SPECIFICATION WHERE NOTED ON PLANS)

• 16" OSB OR 132" PLYWOOD:

FASTEN SHEATHING W/ 23"x0.131" NAILS @ 6"o.c. AT ALL SUPPORTED PANEL EDGES AND 12" O.C. IN THE PANEL FIELD. ALL SHEATHING SHEET PANEL EDGES SHALL OCCUR OVER WALL FRAMING MEMBERS OR 2x HORIZONTAL BLOCKING SHALL BE PROVIDED TO SUPPORT PANEL EDGE. ALL EXTERIOR WALLS SHALL BE CONSTRUCTED PER THIS SPECIFICATION U.N.O. ON

<u>3" o.c. EDGE NAILING</u> (WHERE NOTED ON PLANS)

• 16" OSB OR 15/32" PLYWOOD:

ONLY AT LOCATIONS INDICATED ON PLANS - SHEATHE WALL SHOWN WITH 16" OSB. FASTEN SHEATHING W/ 21"XO.131" NAILS @ 3" O.C. AT EDGES AND 12" O.C. AT CENTER, ALL SHEATHING SHEET PANEL EDGES SHALL OCCUR OVER WALL FRAMING MEMBERS OR 2x HORIZONTAL BLOCKING SHALL BE PROVIDED TO SUPPORT PANEL EDGE AND 3" O.C. FASTENING.

- LATERAL ANALYSIS ASSUMES STUD SPACING @ 16" o.c.
- 2. ALL SHEAR WALLS SHALL HAVE DOUBLE TOP PLATES FASTENED TOGETHER W/ 3"x0.131" NAILS @ 8" O.C. USE (12)31/2"x0.135" NAILS AT EACH LAP SPLICE, (6) EACH SIDE OF JOINT (TYP. U.N.O)
- 3. ALL EXTERIOR WALLS ARE CONTINUOUSLY SHEATHED.
- ALL INTERIOR SHEAR WALLS AND EXTERIOR WALLS ARE SHEATHED ABOVE AND BELOW OPENINGS.

LEGEND

- IIIIIII INTERIOR BEARING WALL
- 🗆 🗆 🗆 BEARING WALL ABOVE (B.W.A.), OR SHEARWALL
- ABOVE (S.W.A.) • — -- BEAM / HEADER
- NIERIOR SHEAR WALL PANEL OR EXTERIOR SHEAR WALL W/ 3" O.C. EDGE NAILING
- . AREA OF OVERFRAMING

JL METAL HANGER

* INDICATES POST ABOVE. PROVIDE SOLID BLOCKING UNDER POST OR JAMB ABOVE.

INDICATES HOLDOWN.

GENERAL STRUCTURAL NOTES

DESIGN PARAMETERS

• DESIGN IS BASED ON 2018 INTERNATIONAL RESIDENTIAL CODE **\$ 2018 INTERNATIONAL BUILDING CODE** • WOOD FRAME ENGINEERING IS BASED ON NDS, "NATIONAL DESIGN

SPECIFICATION FOR WOOD CONSTRUCTION" - LATEST EDITION.

GENERAL FRAMING

• EXTERIOR BEARING WALLS SHALL BE 2x4 OR 2x6 (AS SHOWN ON PLANS) @ 16" O.C. (w/ DOUBLE TOP PLATE) HEM FIR (HF) "STUD" GRADE LUMBER, OR BETTER, U.N.O.

PLANS) @ 16" O.C. (W/ DOUBLE TOP PLATE) HEM FIR (HF) "STUD" GRADE LUMBER, OR BETTER, U.N.O.

• ALL NON-BEARING INTERIOR STUD WALLS SHALL BE CONSTRUCTED WITH 2x 'STUD' GRADE MEMBERS SPACED @ 24" O.C. (MAX.)

• INTERIOR BEARING WALLS SHALL BE 2x4 OR 2x6 (AS SHOWN ON

• ALL WALLS TALLER THEN TYP. PLATE HEIGHT SHALL BE CONSIDERED BALLOON FRAMED & SHALL BE CONSTRUCTED FROM FLOOR TO UNDERSIDE OF FRAMING AT NEXT LEVEL. B.F. WALLS SHALL BE 2x4 OR 2x6 (AS SHOWN ON PLANS) HEM FIR (HF) #2 GRADE LUMBER, OR BETTER.

● ALL HEADERS SHALL BE SUPPORTED BY (1)2x JACK STUD & (1)2x KING STUD. MINIMUM - THE NUMBER OF STUDS SPECIFIED AT A SUPPORT INDICATES THE

NUMBER OF JACK STUDS REQUIRED, U.N.O.. ● BUILT-UP POSTS SHALL BE 2x4 OR 2x6 HEM FIR (HF) "STUD" GRADE LUMBER, OR BETTER, U.N.O. & SOLID WOOD COLUMNS SHALL

BE HEM FIR (HF) #2 GRADE LUMBER, OR BETTER, U.N.O. • ALL 2x6 AND LARGER SOLID SAWN BEAMS/HEADERS SHALL BE HEM FIR #2 (HF #2) OR BETTER. ALL 4x6 AND LARGER SOLID SAWN LUMBER SHALL BE DOUGLAS FIR #2 (DF #2) OR BETTER.

• ALL FRAMING LUMBER SHALL BE KILN DRIED TO 15% MC (KD-15). • ALL TYP. NAIL FASTENER REQUIREMENTS ARE NOTED IN GENERAL NOTES, IN DETAILS, OR ON PLANS. ALL NAILS SPECIFIED ARE MIN DIAMETER AND LENGTH REQUIRED FOR CONNECTION. ALL HANGER NAILS SHALL BE INSTALLED PER MANUFACTURER'S REQUIREMENTS FOR MAX CHARTED CAPACITY. NOTE: HANGERS USE COMMON NAIL DIAMETERS NOT TYPICAL FRAMING GUN NAILS.

• FASTEN ALL BEAMS TO COLUMNS, OR FLUSH BEAMS TO SUPPORTING BEAMS, W/ (4) 3"x0.131" TOENAILS (MIN.), TYP. U.N.O.

• PROVIDE SOLID BLOCKING IN FLOOR SYSTEM UNDER ALL POSTS &

HOLD-DOWNS CONTINUOUS TO FOUNDATION/BEARING. BLOCKING TO MATCH POST ABOVE. ENGINEERED LUMBER TO MEET OR EXCEED THE FOLLOWING: LSL MEMBERS - Fb=2325 PSI; Fv=310 PSI; E=1.55x10^6 PSI • LVL MEMBERS - Fb=2600 PSI; Fv=285 PSI; E=2.0x10^6 PSI

 GLB MEMBERS - Fb(+)=2400 PSI; Fb(-)=1850 PSI; Fv=265 PSI; E=I.8xI0^6 PSI; DF/DF; 24F-V4 (U.N.O) • ENGINEERED LUMBER POSTS TO MEET OR EXCEED THE FOLLOWING: LVL MEMBERS - Fb=2400 PSI; FcII=2500 PSI; E=1.8xI0^6 PSI

• FACE NAIL MULTI-PLY 2x BEAMS & HEADERS W/ 3-ROWS OF 3"x0.131" NAILS (MIN.) @ 12" O.C. STAGGERED. APPLY NAILING FROM BOTH FACES @ 3-PLY OR MORE CONDITIONS. UTILIZE 2 ROWS OF NAILS FOR 2x6 \$ 2x8 MEMBERS.

• ALL MEMBERS SPECIFIED AS MULTI-PLY 13/4" SHALL BE FASTENED TOGETHER PER MANUFACTURER. EQUIVALENT WIDTH SOLID MATERIAL MAY BE USED AS EQUAL. ● FASTEN 2x WOOD PLATES TO TOP FLANGE OF STEEL BEAMS

w/P.A.F.s ('HILTI' X-U PINS OR EQUAL (0.157" DIA. x 2" LONG MIN.)) @ 16" O.C. STAGGERED, OR 1/2" DIA. BOLTS @ 48" O.C., STAGGERED. • REFER TO IRC FASTENING SCHEDULE TABLE R602.3(1) FOR ALL CONNECTIONS, TYP. U.N.O.

<u>FLOOR FRAMING</u>

● I-JOISTS/TRUSSES SHALL BE DESIGNED BY MANUF. TO MEET OR EXCEED L/480 LIVE LOAD DEFLECTION CRITERIA AND SHALL RUN CONTINUOUS OVER SUPPORTS WHEREVER POSSIBLE. ALL LOADS SHOWN ON PLAN FOR MANUF. DESIGNS ARE ASD LEVEL LOADS, U.N.O. (EXCLUDES STONE/MARBLE OR WET BED CONSTRUCTED FLOORS - CONTACT M&K FOR EXCLUDED DESIGNS).

I-JOIST/TRUSS MANUFACTURER, UNLESS OTHERWISE NOTED. • I-JOIST/TRUSS SHOP DRAWINGS SHALL BE SUBMITTED TO ARCHITECT AND ENGINEER FOR REVIEW AND APPROVAL PRIOR TO

FABRICATION OR DELIVERY. • 2x FLOOR JOISTS HAVE BEEN DESIGNED TO MEET OR EXCEED

SINGLE PLY: SIMPSON LUS210

• FLOOR SHEATHING SHALL BE 23/32" A.P.A. RATED 'STURD-I-FLOOR' 24" O.C, EXPOSURE I (OR APPROVED EQUAL) WITH TONGUE AND GROOVE EDGES. FASTEN TO FRAMING MEMBERS W/ GLUE AND $2\frac{1}{2}$ " x 0.131" NAILS @ 6"o.c. @ PANEL EDGES & @ 12"o.c. FIELD.

ROOF FRAMING

● FASTEN HANGERS TO SINGLE PLY FLUSH BEAMS W/ 1½" LONG NAILS.

• FASTEN EACH ROOF RAFTER TO TOP PLATE WITH (I) 'SIMPSON' H2.5T CLIP. PROVIDE (2) 'SIMPSON' H2.5T CLIPS AT FLUSH BEAMS IN THE ROOF - AT ALL BEARING POINTS.

• WITHIN 48" OF ALL ROOF EDGES, RIDGES, & HIPS FASTEN ROOF SHEATHING FIELDS PER EDGE NAILING SPEC.

• ALL METAL HANGERS SHALL BE SPECIFIED BY THE TRUSS MANUFACTURER, UNLESS OTHERWISE NOTED.

• ROOF TRUSS SHOP DRAWINGS & CALCULATIONS SHALL BE PREPARED BY A WASHINGTON STATE LICENSED ENGINEER AND SHALL BE DESIGNED FOR UNBALANCED SNOW LOADING PER

• ERECT AND INSTALL ROOF TRUSSES PER WTCA & TPI'S BCSI I-08 "GUIDE TO GOOD PRACTICE FOR HANDLING, INSTALLING & BRACING OF METAL PLATE CONNECTED WOOD TRUSSES."

3"x0.131" TOENAILS AT EA. TRUSS. • SUPPORT PORCH & SHORT SPAN ROOF TRUSSES (UP TO 6' TRIB.) w/2x6 LEDGER FASTENED TO FRAMING w/(3) 3"x0.131" NAILS @ 16" o • FASTEN ALL INTERIOR NON-BEARING PARTITION WALLS TO TRUSS



pyright: MULHERN & KULP Structural Engineering, Inc.

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M&K project number: 01B-2208

NJM drawn by: 03-01-23 issue date:

REVISIONS: initial: LGH 05/16/2023 FOUNDATION REVISIONS)3/22/2024

PLAN REVIEW COMMENTS

ALL METAL I-JOIST/TRUSS HANGERS SHALL BE SPECIFIED BY

L/360 LIVE LOAD DEFLECTION CRITERIA.

 TYPICAL 2x JOIST HANGERS (U.N.O. ON PLANS): DOUBLES: SIMPSON LUS210-2

• ALL FLUSH CONNECTIONS SHALL BE CONNECTED WITH HANGER APPROPRIATE FOR MEMBER SIZE. U.N.O.

● FASTEN EACH ROOF TRUSS TO TOP PLATE W/ (3) 3"x0.l31" TOENAILS (MIN.) & (I) 'SIMPSON' H2.5T CLIP @ ALL BEARING POINTS. PROVIDE (2) 'SIMPSON' H2.5T CLIPS AT 2-PLY GIRDER TRUSSES \$ 3-PLY GIRDER TRUSSES AT ALL BEARING POINTS.


• ROOF SHEATHING SHALL BE 7/16" A.P.A. RATED SHEATHING 24/16 EXPOSURE I (OR APPROVED EQUAL). FASTEN TO FRAMING MEMBERS w/ 2 ½" x 0.131" NAILS @ 6"o.c. AT PANEL EDGES ₺ @ 12" O.C. AT INTERMEDIATE SUPPORTS. ROOF SHEATHING SHALL EXTEND BELOW ALL INSTANCES OF OVERFRAMING. BLOCKING SHALL BE INSTALLE AS REQUIRED TO LIMIT ROOF SHEATHING SPANS TO 24" MAX.

• ROOF TRUSS SHOP DRAWINGS SHALL BE SUBMITTED TO ARCHITECT AND ENGINEER FOR REVIEW AND APPROVAL PRIOR TO FABRICATION OR DELIVERY.

ASCE 7-16, SECTION 7.6.

• FASTEN OVER-FRAMED TRUSS SETS TO TRUSSES BELOW w/ (2)

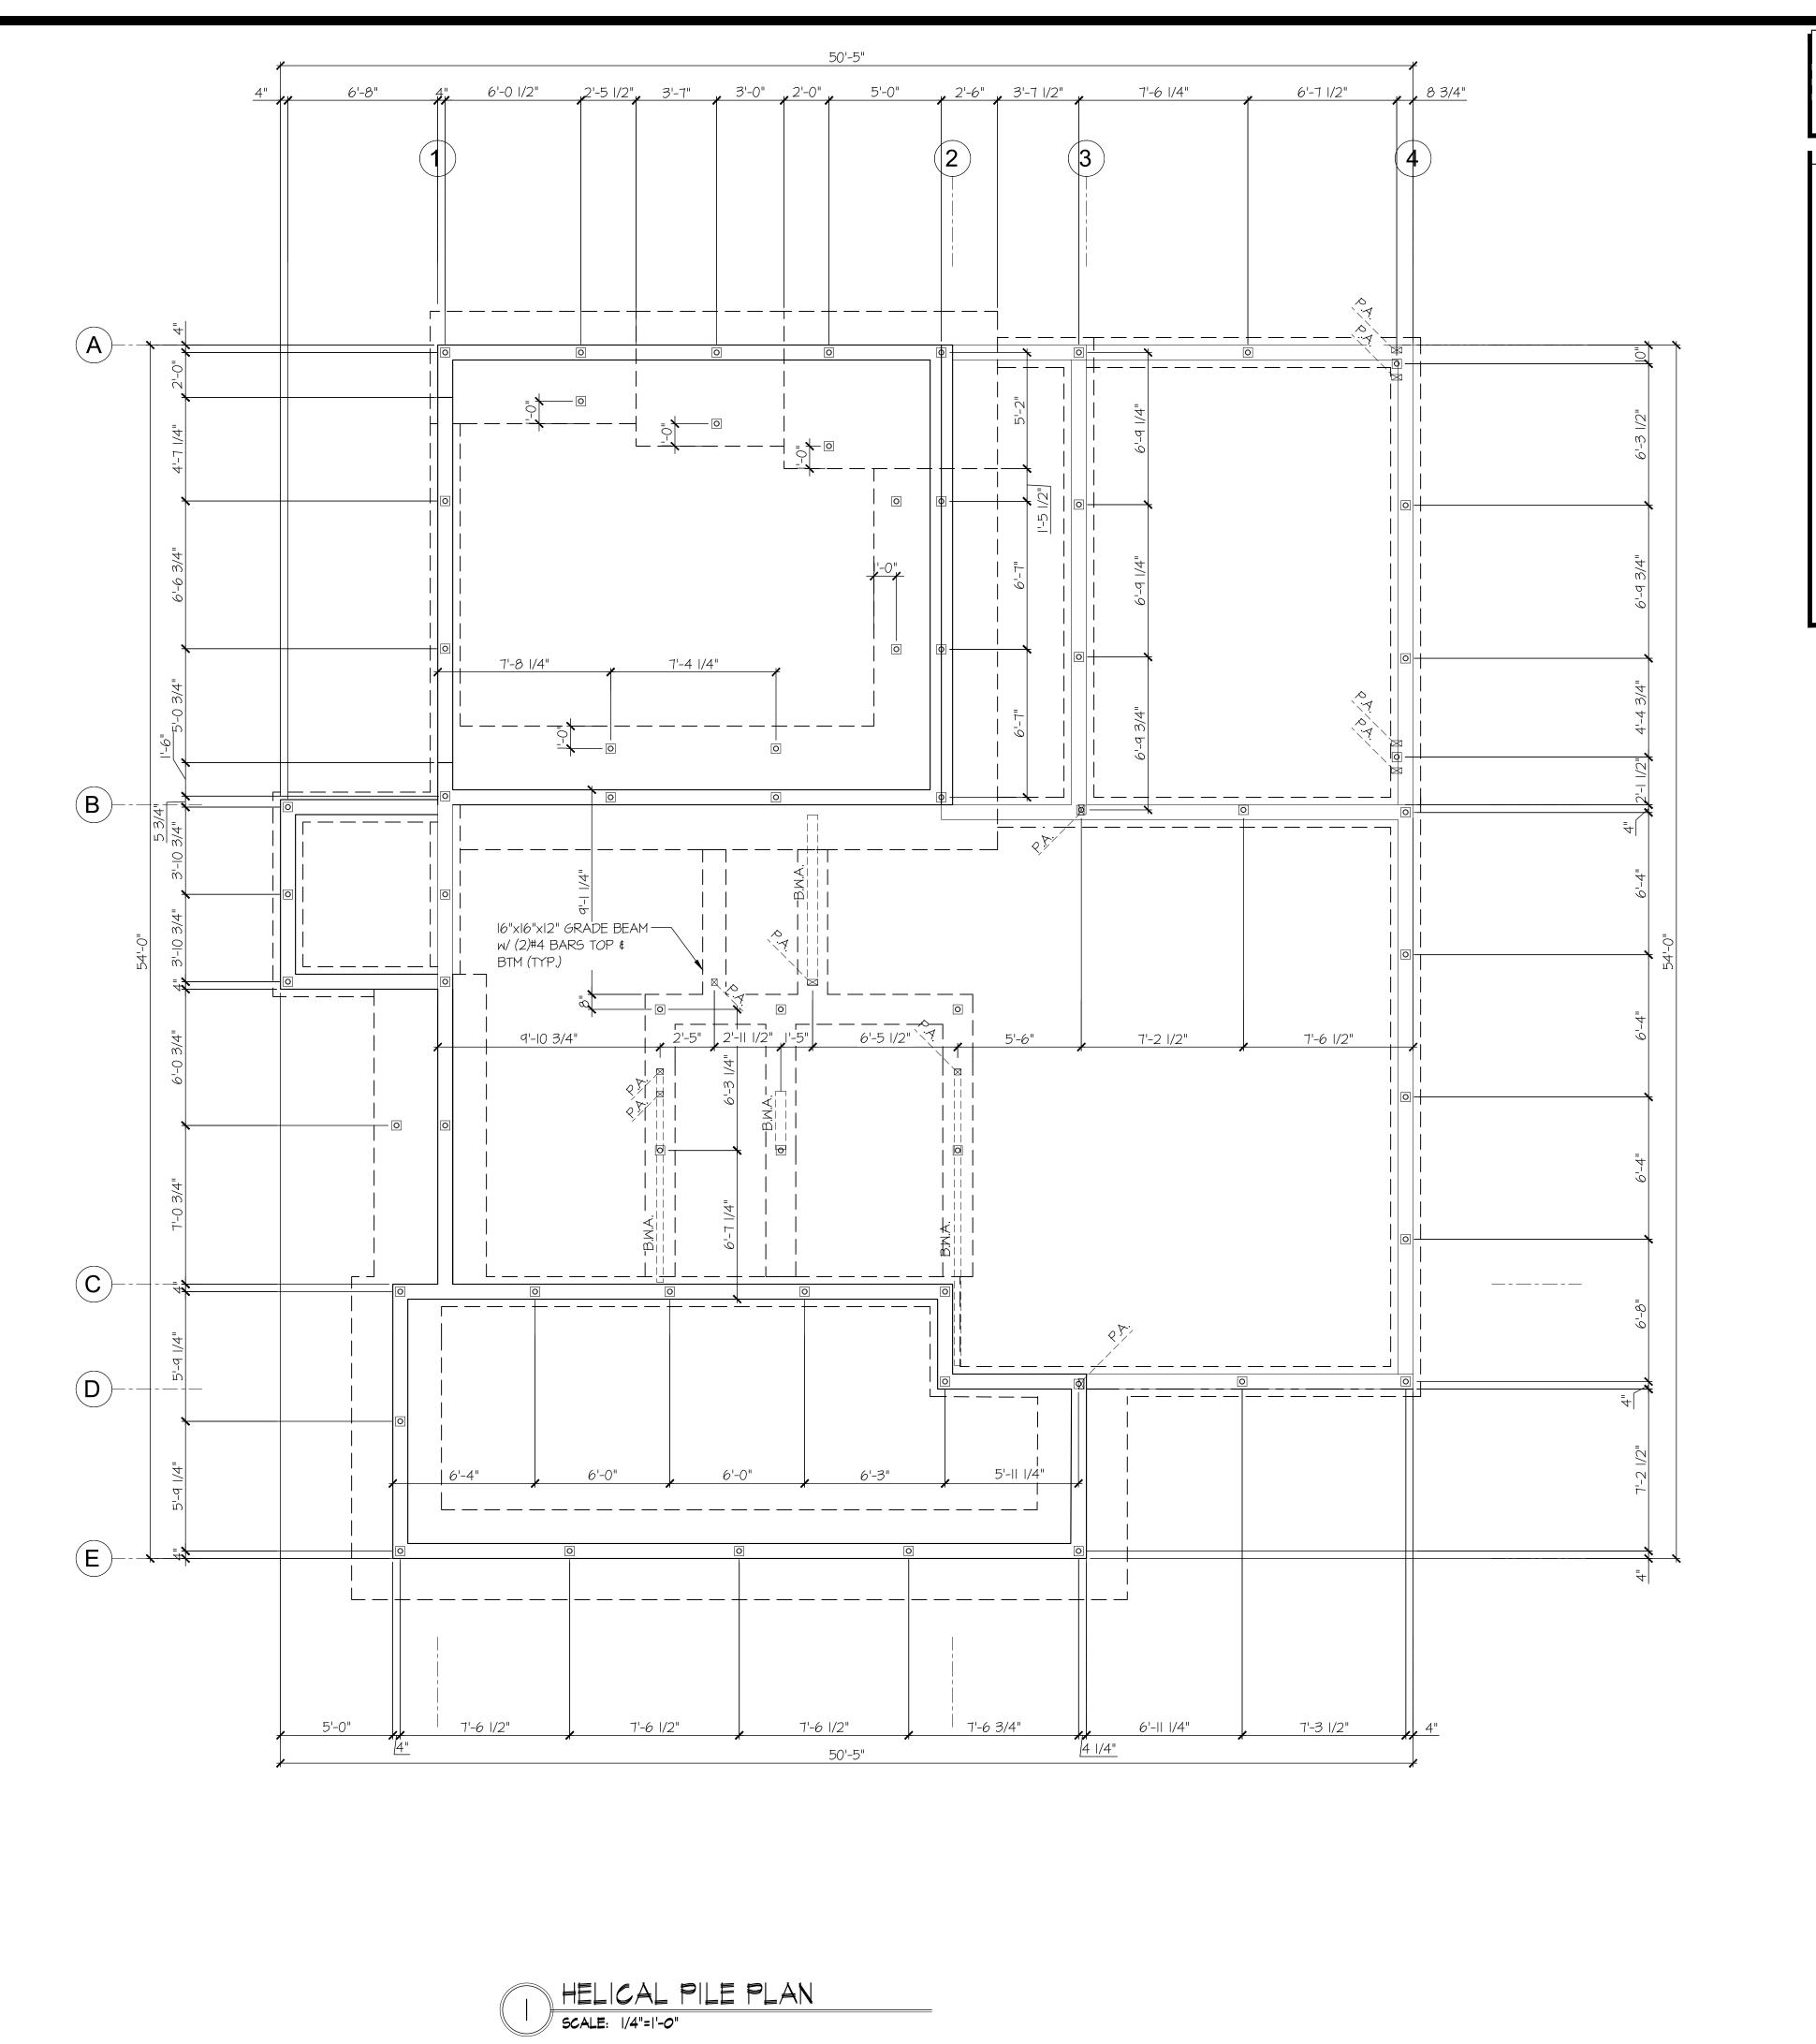BOTTOM CHORD ABOVE WITH SIMPSON STC CLIPS AT 24" o.c. MAX. PROVIDE BLOCKING BETWEEN THE TRUSS BOTTOM CHORDS AS REQUIRED FOR THE PARALLEL CONDITIONS



REFER TO S-0.0 FOR TYPICAL STRUCTURAL NOTES & SCHEDULES

● TYPICAL GRADE BEAM SPECIFICATION: 16" DEEP x 16" WIDE (@ PERIM. WALLS) REINFORCED CONCRETE GRADE BEAM w/ (2) #4 BARS (EQUALLY SPACED) CONTINUOUS AT TOP & BOTTOM & #3 STIRRUPS @ 48" o.c. w/ 3" COVER.

• PILES SHALL BE INSTALLED TO SUPPORT DESIGN LOAD OF II TONS/PILE MINIMUM (SAFE LOAD) PER GEOTECH.

• PILING CONTRACTOR SHALL DETERMINE BY TEST PILE, THE LENGTH AND DIMENSIONS OF THE PILINGS REQUIRED TO REACH DESIGN LOAD CAPACITY.

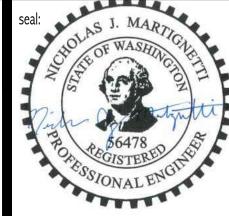
 HELICAL PILE FOUNDATIONS (IBC 1704.10) SPECIAL INSPECTIONS OF ALL HELICAL PILE INSTALLATIONS SHALL BE PERFORMED IN ACCORDANCE WITH SECTION 1704.10 OF THE IBC. SPECIAL INSPECTIONS SHALL BE PERFORMED CONTINUOUSLY DURING INSTALLATION AND THE INFORMATION RECORDED SHALL INCLUDE, BUT NOT BE LIMITED TO: I. <u>MATERIAL COMPLIANCE:</u>

VERIFY PILE DIMENSIONS. (CONTINUOUS) 2. TEST PILE OBSERVATIONS:

VERIFY CAPACITIES OF PILES. (CONTINUOUS)

- 3. PILE DRIVING OBSERVATIONS: OBSERVE PILE DRIVING OPERATIONS AND MAINTAIN INSTALLATION RECORDS FOR ALL PILES. (CONTINUOUS) A. VERIFY PILE PLACEMENT AND PLUMBNESS.
- B. RECORD FINAL DEPTH C. RECORD FINAL INSTALLATION TORQUE
- D. RECORD PILE TIP ELEVATIONS. E. DOCUMENT ANY DAMAGE TO PILE.

O INDICATES LOCATION OF HELICAL PILE




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REFER TO S-0.0 FOR TYPICAL STRUCTURAL NOTES & SCHEDULES

LEGEND

- [] INTERIOR BEARING WALL
- 🗆 = = = BEARING WALL ABOVE (B.M.A.), OR SHEARWALL ABOVE (S.M.A.)
- --- BEAM / HEADER
- 💻 💻 INTERIOR SHEAR WALL PANEL OR EXTERIOR SHEAR WALL w/ 3" o.c. EDGE NAILING

• AREA OF OVERFRAMING

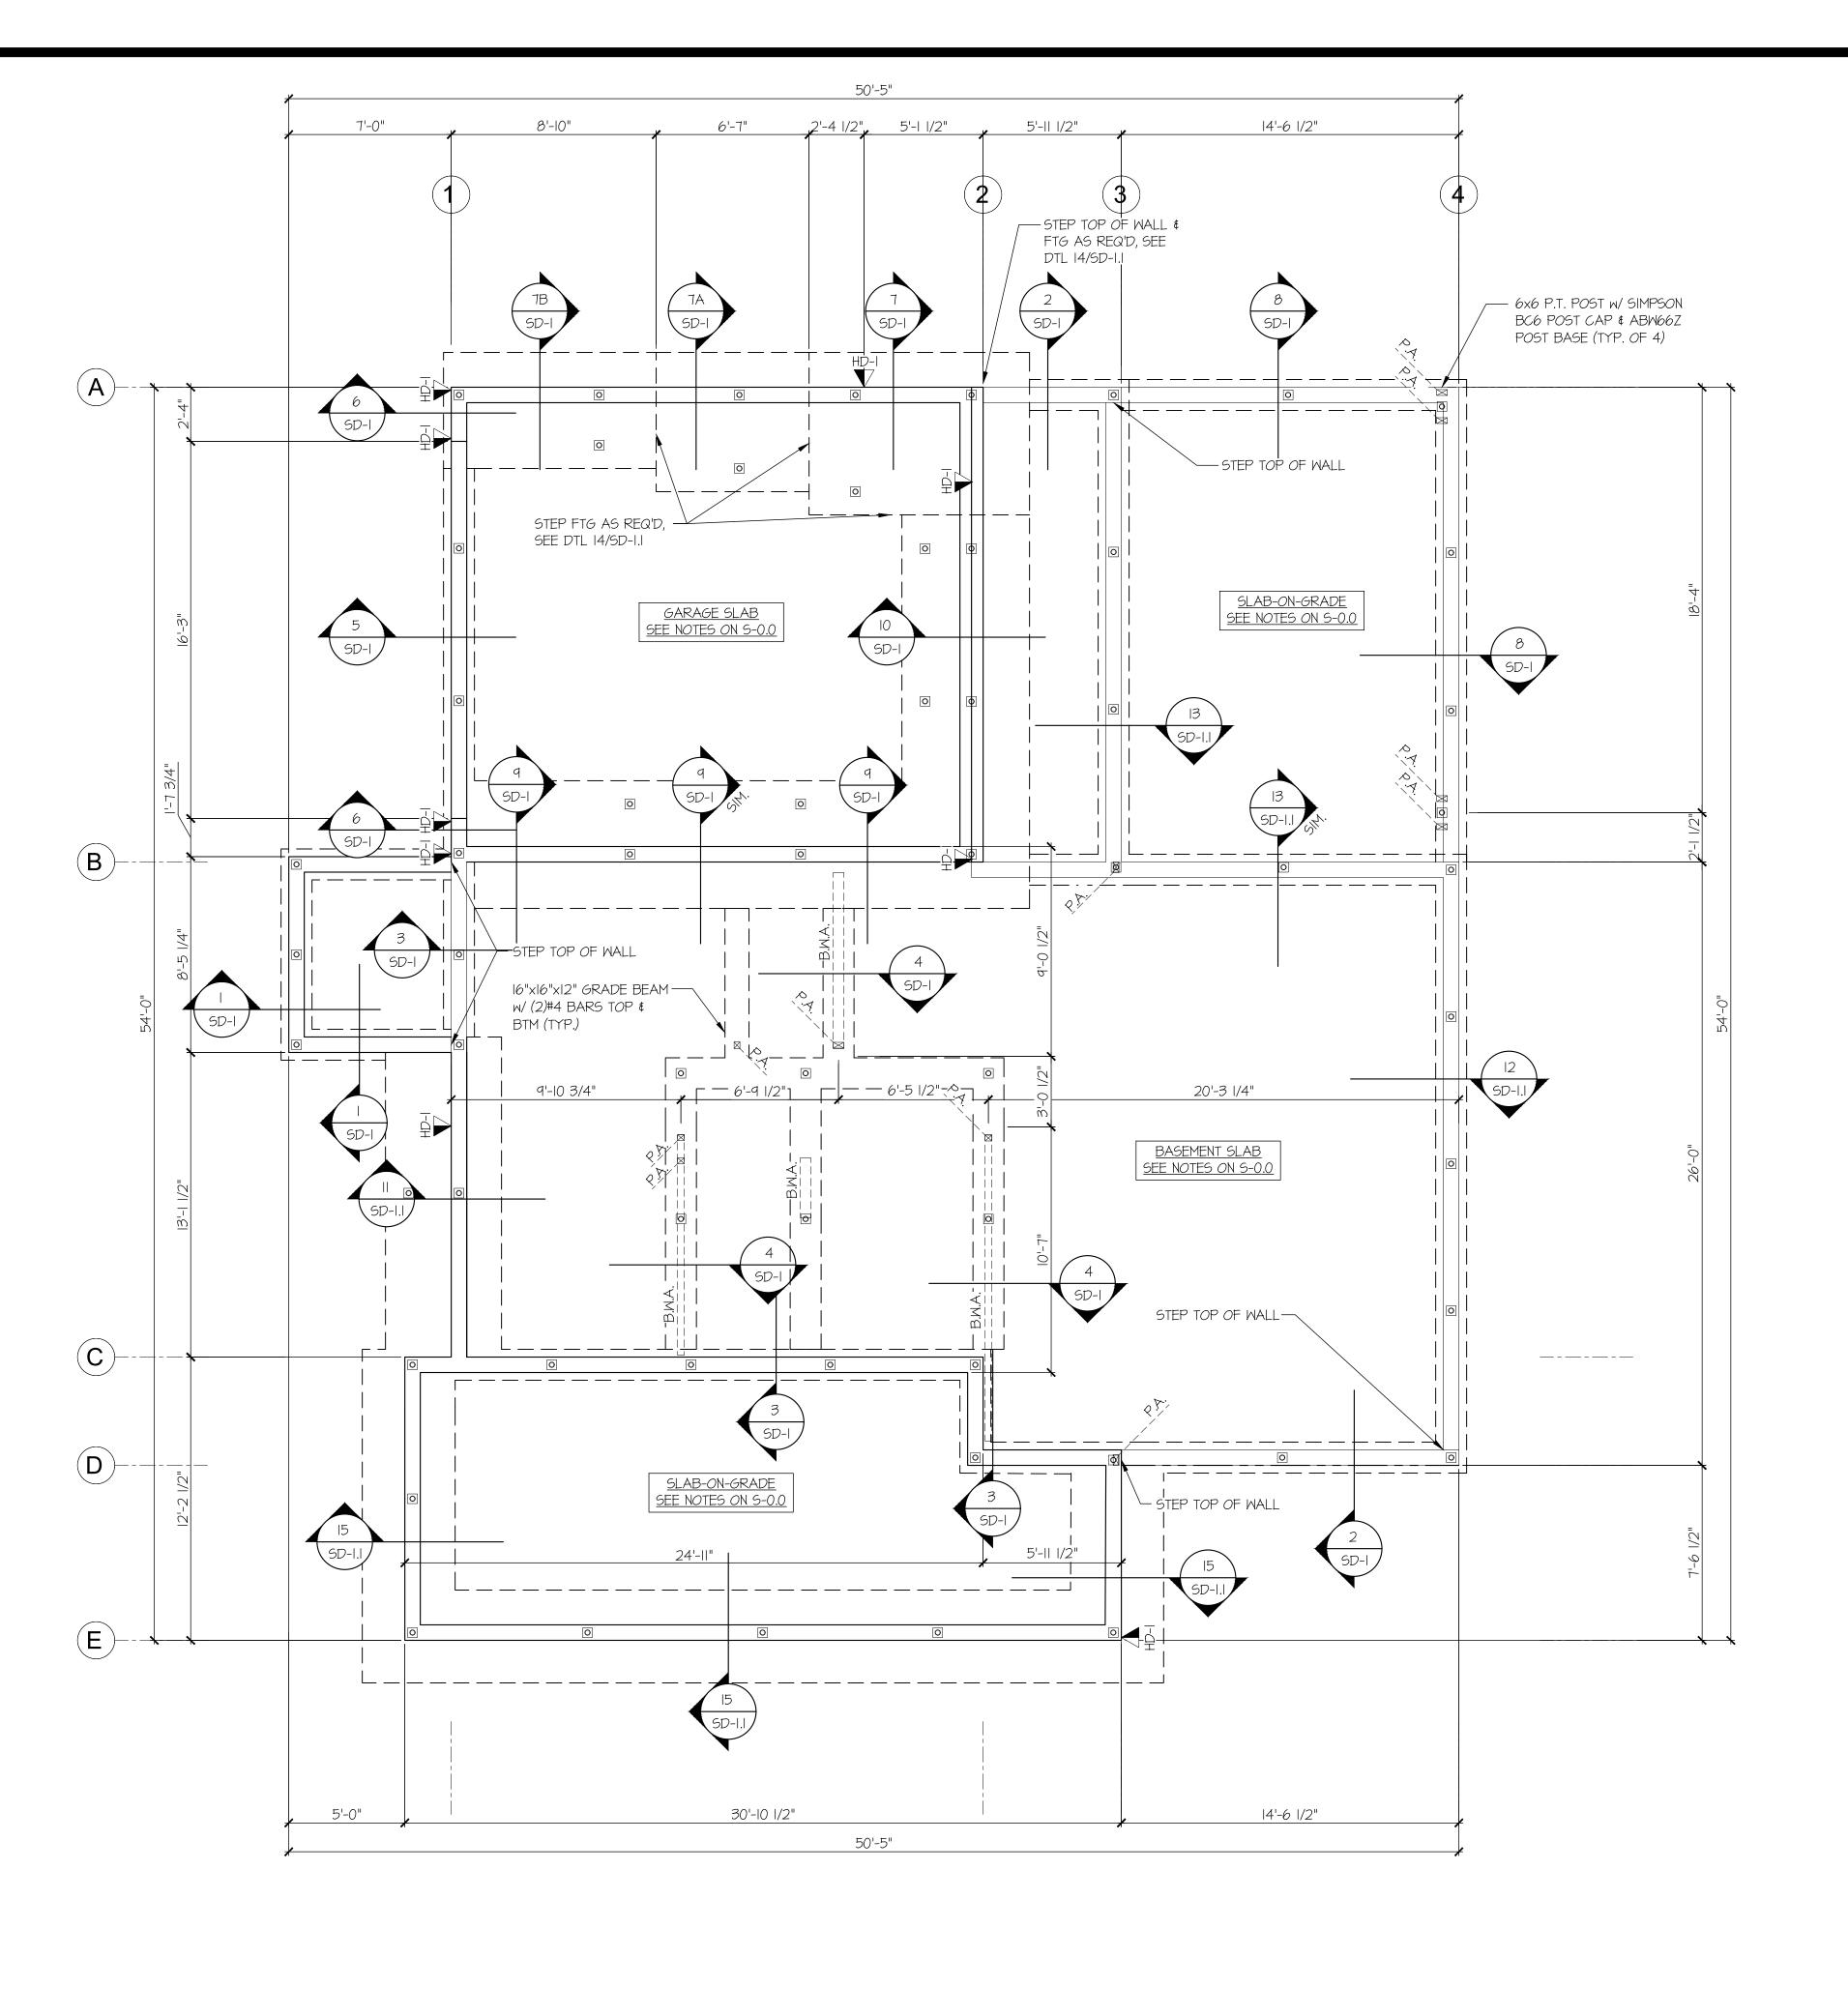- JL METAL HANGER
- * INDICATES POST ABOVE. PROVIDE SOLID BLOCKING UNDER POST OR JAMB ABOVE.

INDICATES HOLDOWN.

HOLD-DOWN SCHEDULE

	SYMBOL	SPECIFICATION
	HD-I	SIMPSON STHD14 (RJ) HOLD-DOWN
	HD-5	SIMPSON CSI6 STRAP TIE (14" END LENGTH)
	HD-6	SIMPSON MSTC40 STRAP TIE (CENTER STRAP ON FLOOR SYSTEM U.N.O.)
	HD-7	SIMPSON MSTC66 STRAP TIE (CENTER STRAP ON FLOOR SYSTEM U.N.O.)

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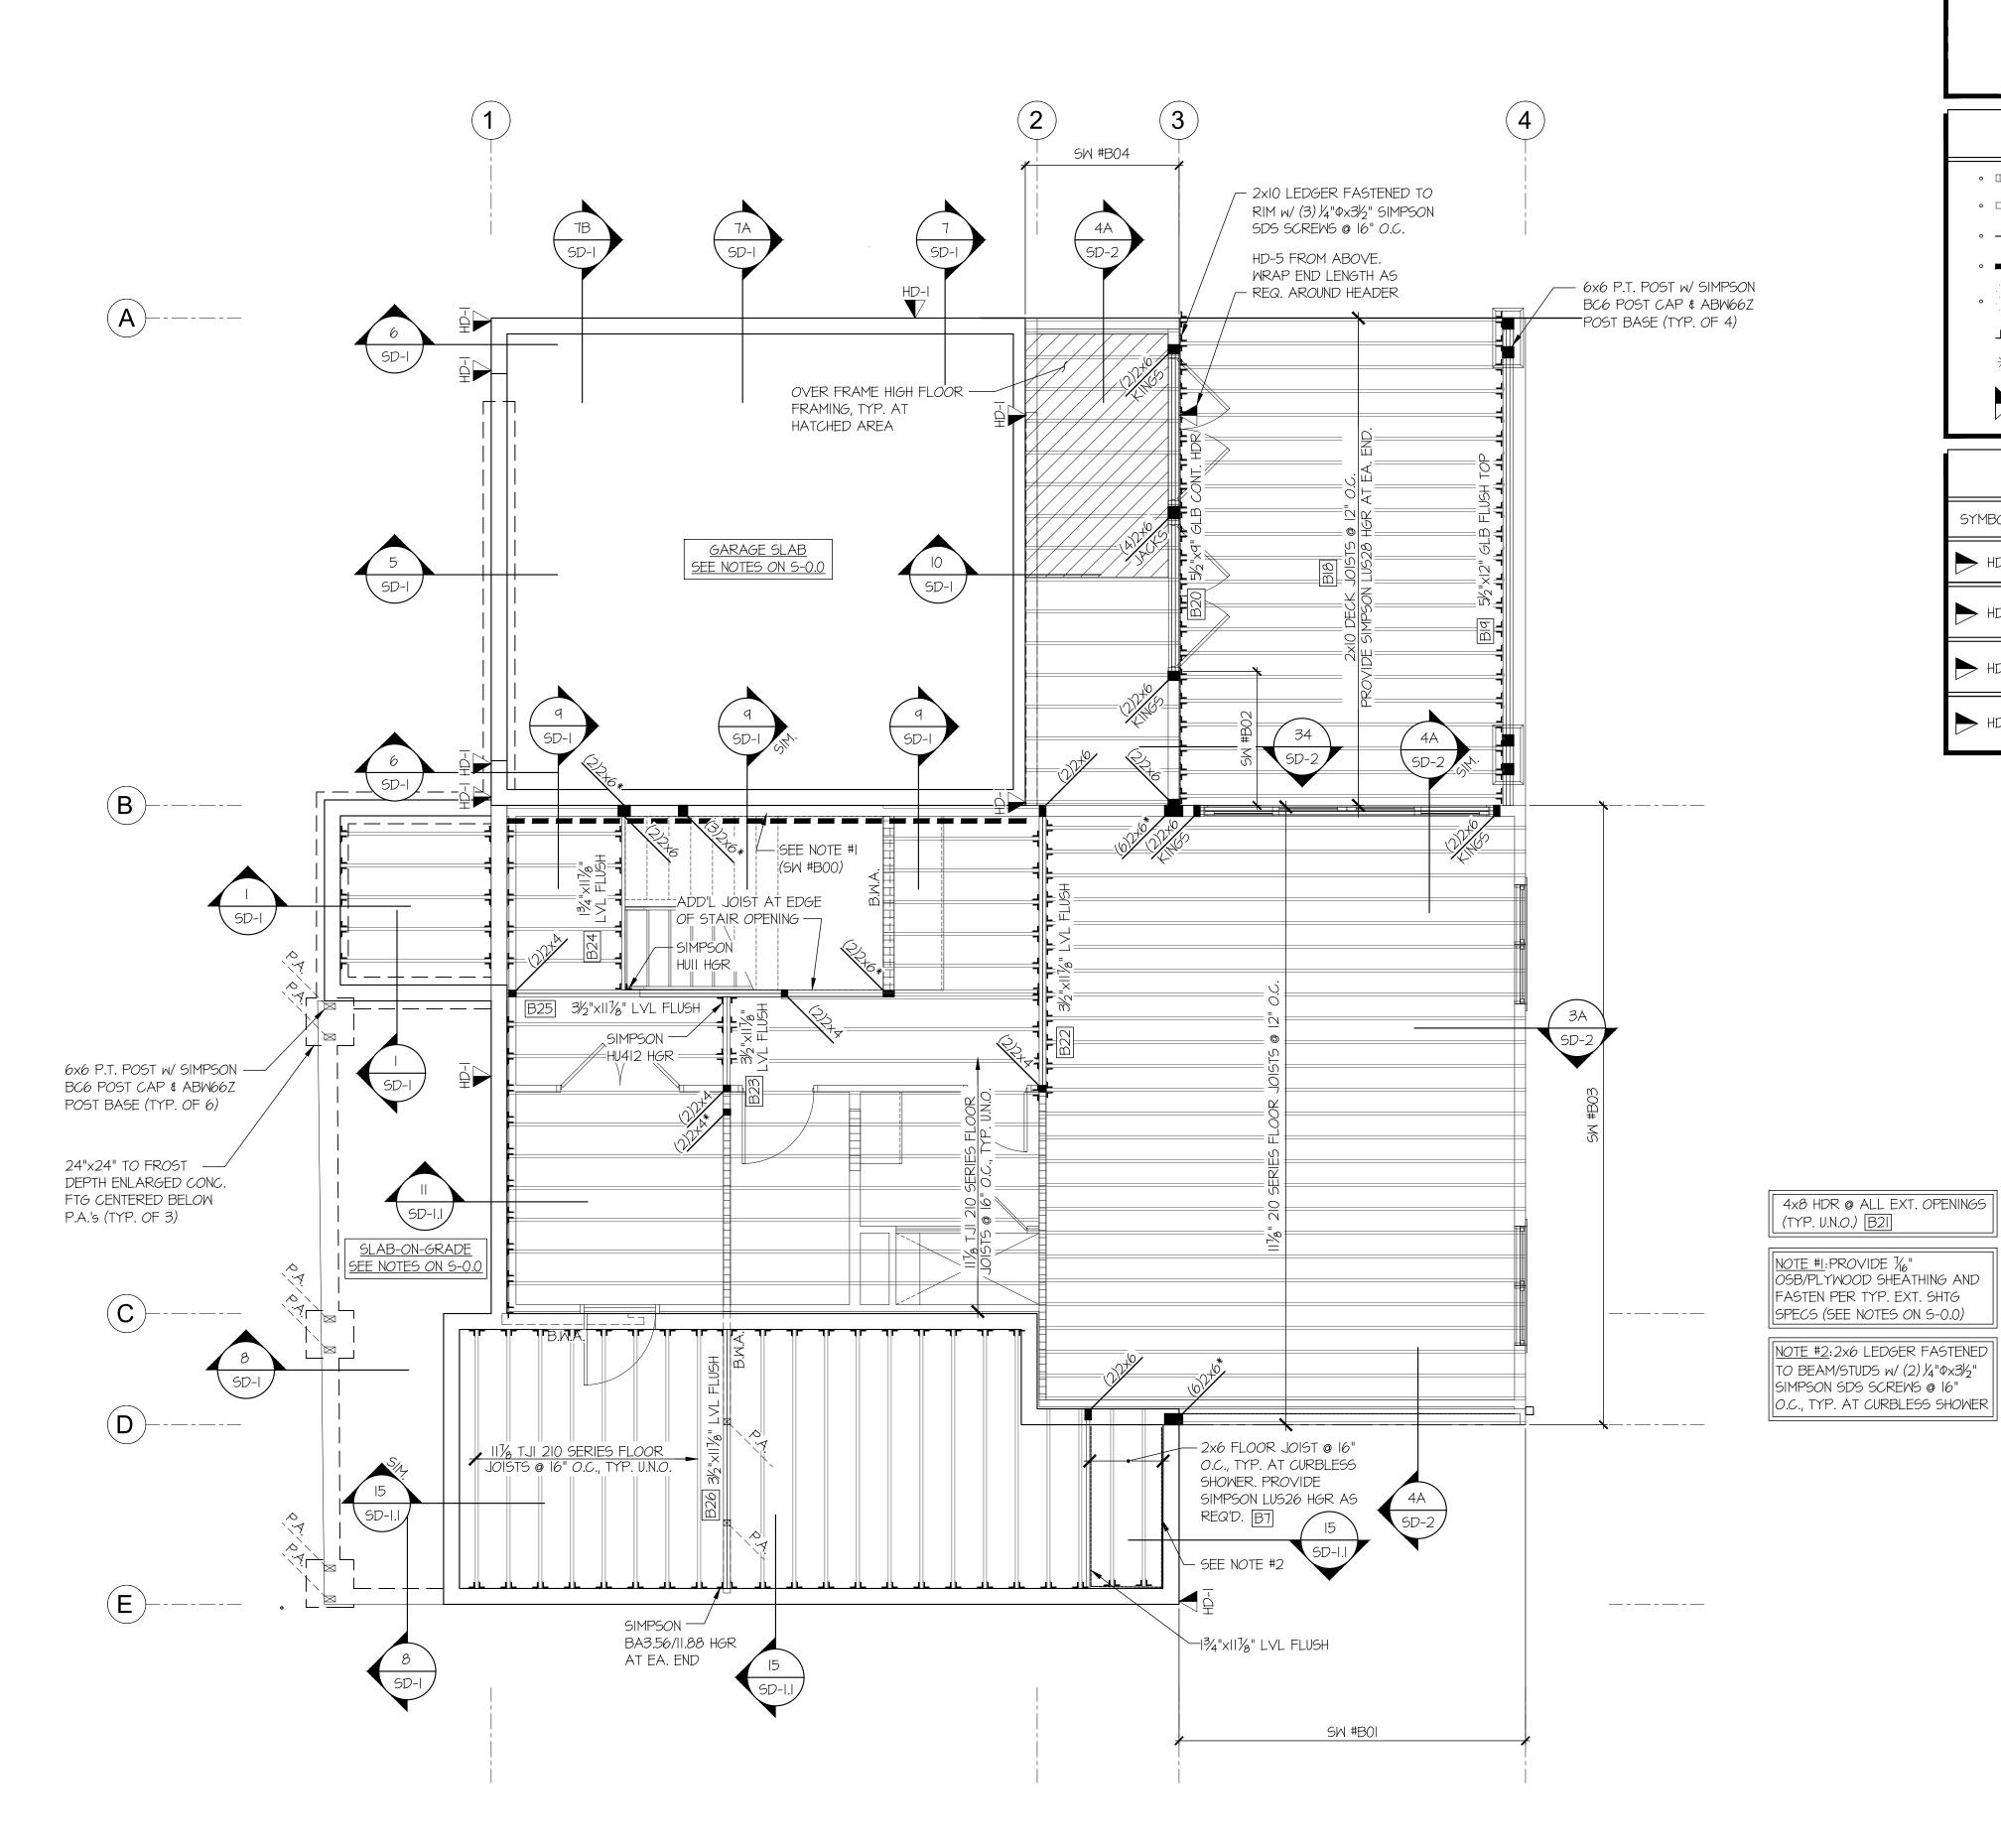
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MULHERN-RESIDENTIAL STRUCTURAL

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REFER TO S-0.0 FOR TYPICAL STRUCTURAL NOTES & SCHEDULES

LEGEND

- IIIIII INTERIOR BEARING WALL
- □□□□□ BEARING WALL ABOVE (B.W.A.), OR SHEARWALL ABOVE (S.W.A.)
- — -- BEAM / HEADER
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(CENTER STRAP ON FLOOR SYSTEM U.N.O.)

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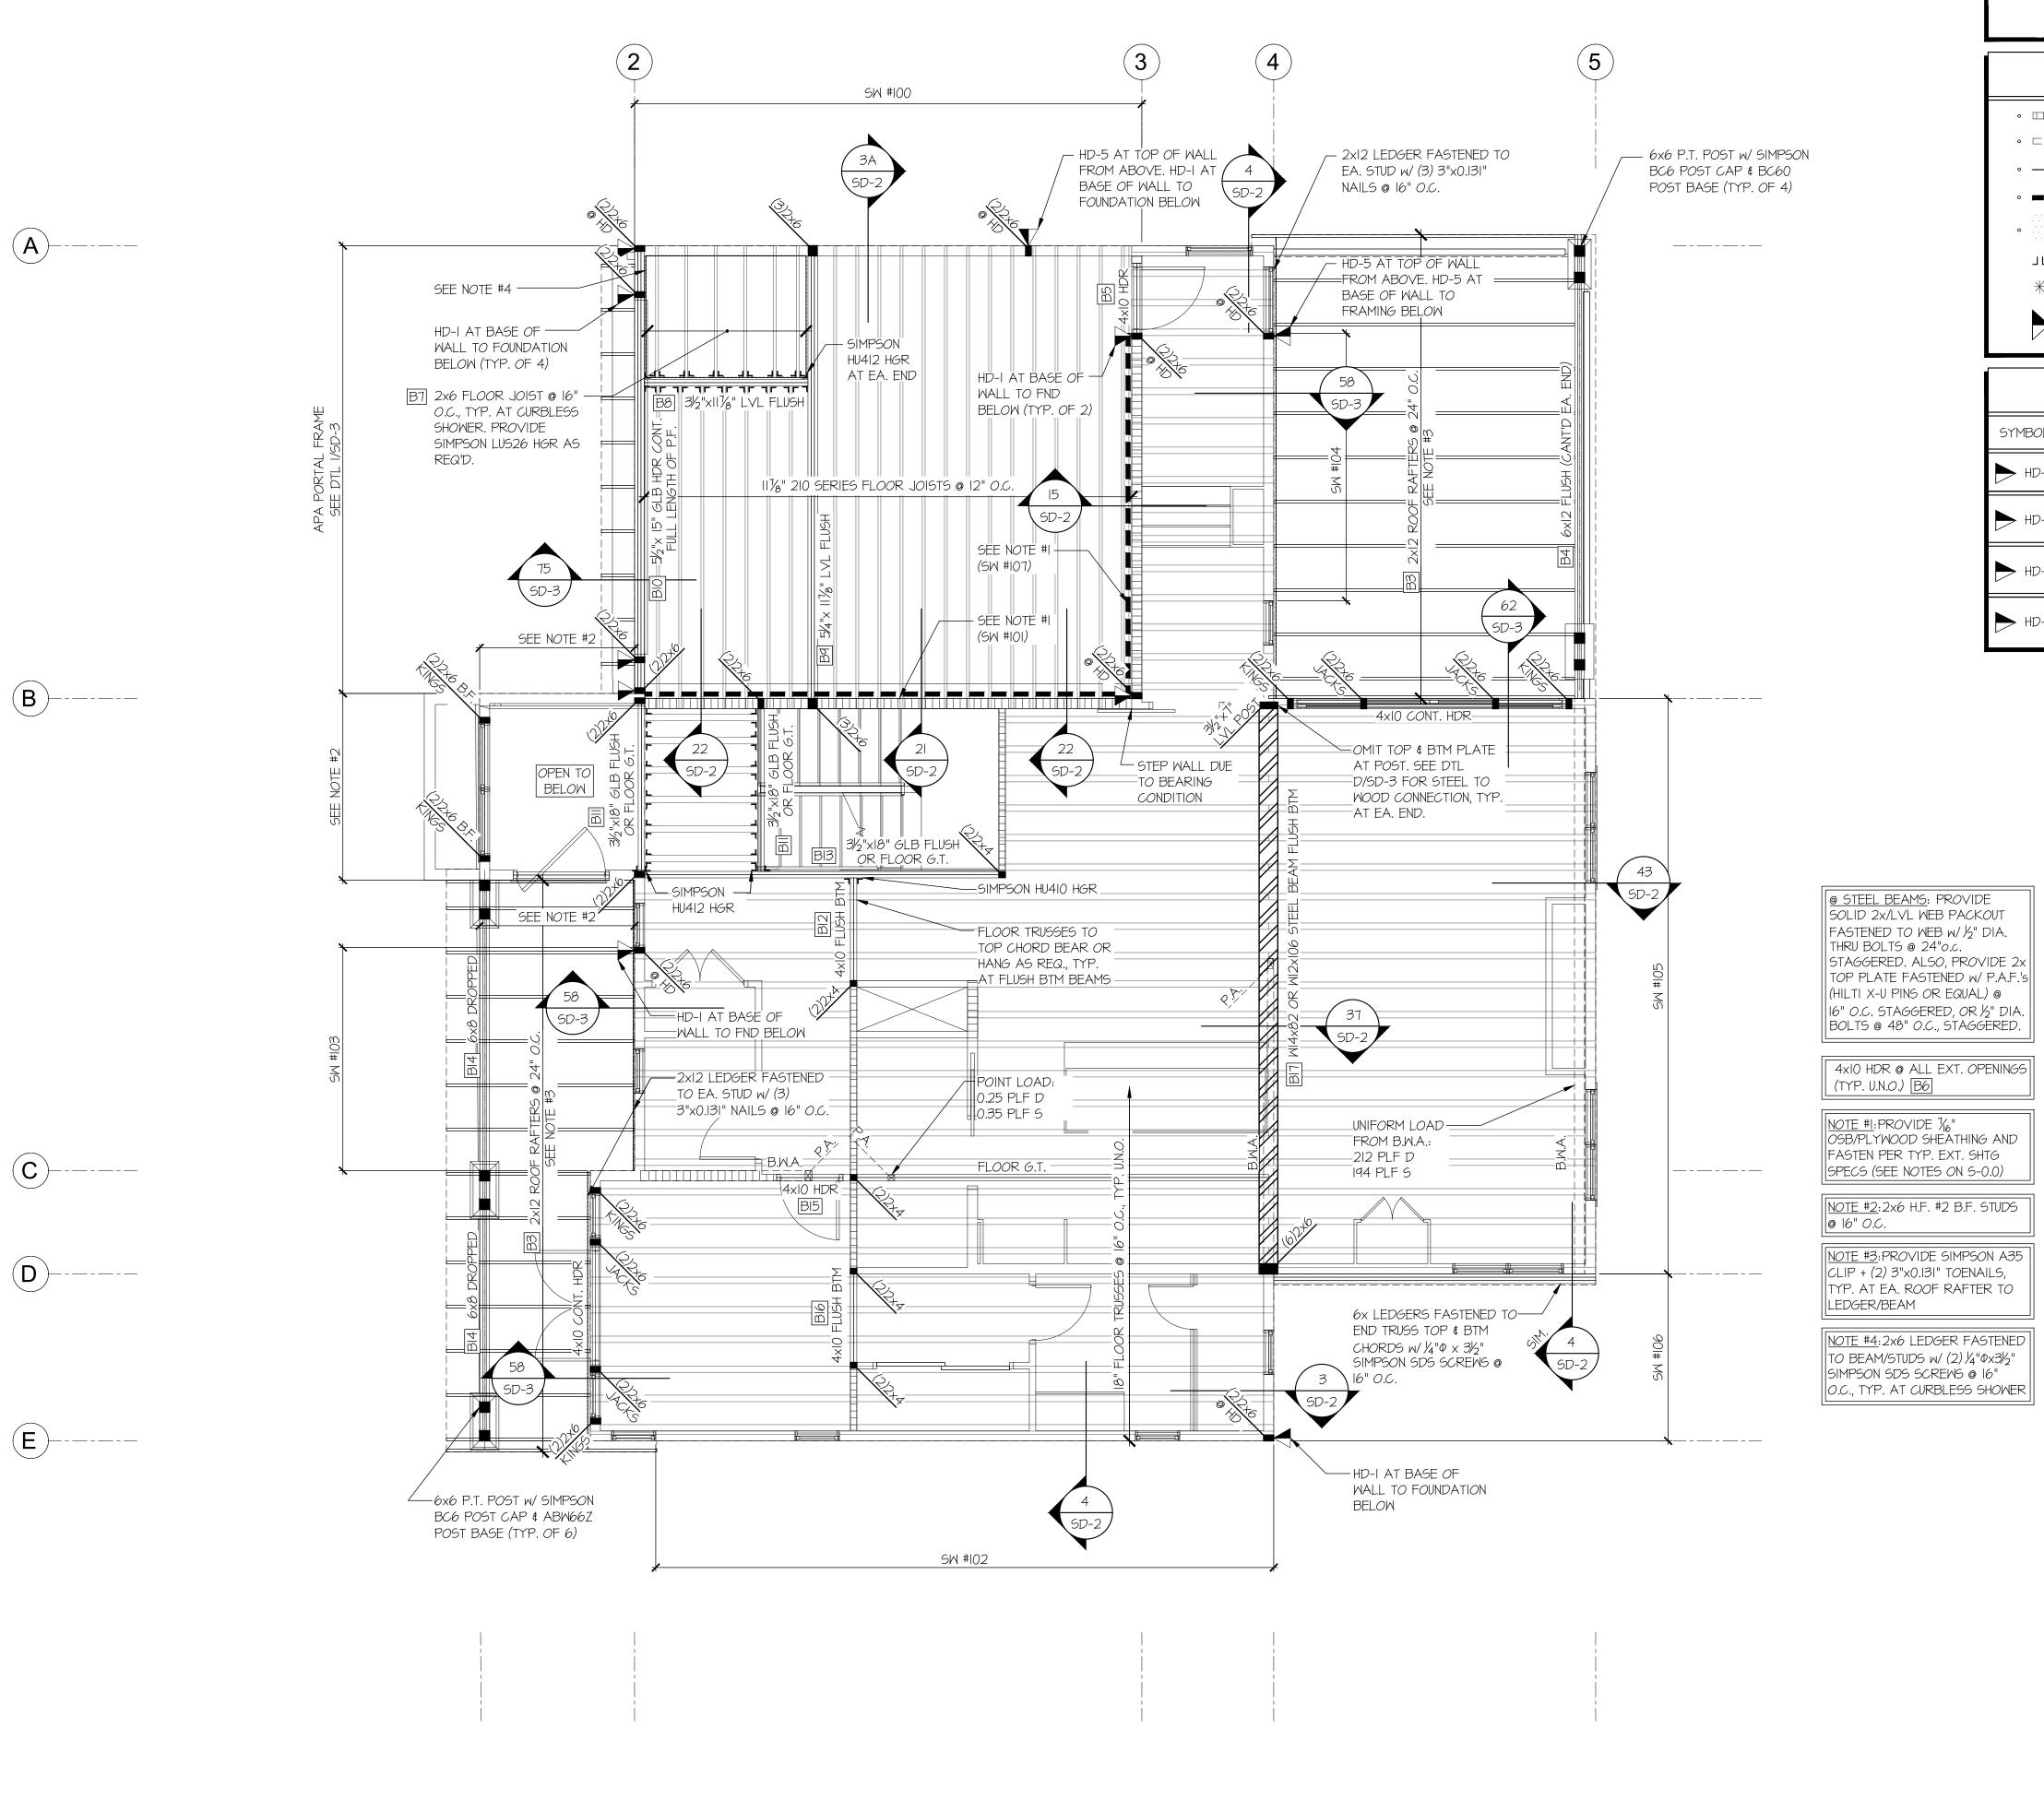
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OOR FRAMING MAIN



UPPER FLOOR FRAMING PLAN

SCALE: 1/4"=1'-0"

REFER TO S-0.0 FOR TYPICAL STRUCTURAL NOTES & SCHEDULES

LEGEND

- IIIIII INTERIOR BEARING WALL
- □□□□□ BEARING WALL ABOVE (B.W.A.), OR SHEARWALL ABOVE (S.W.A.)
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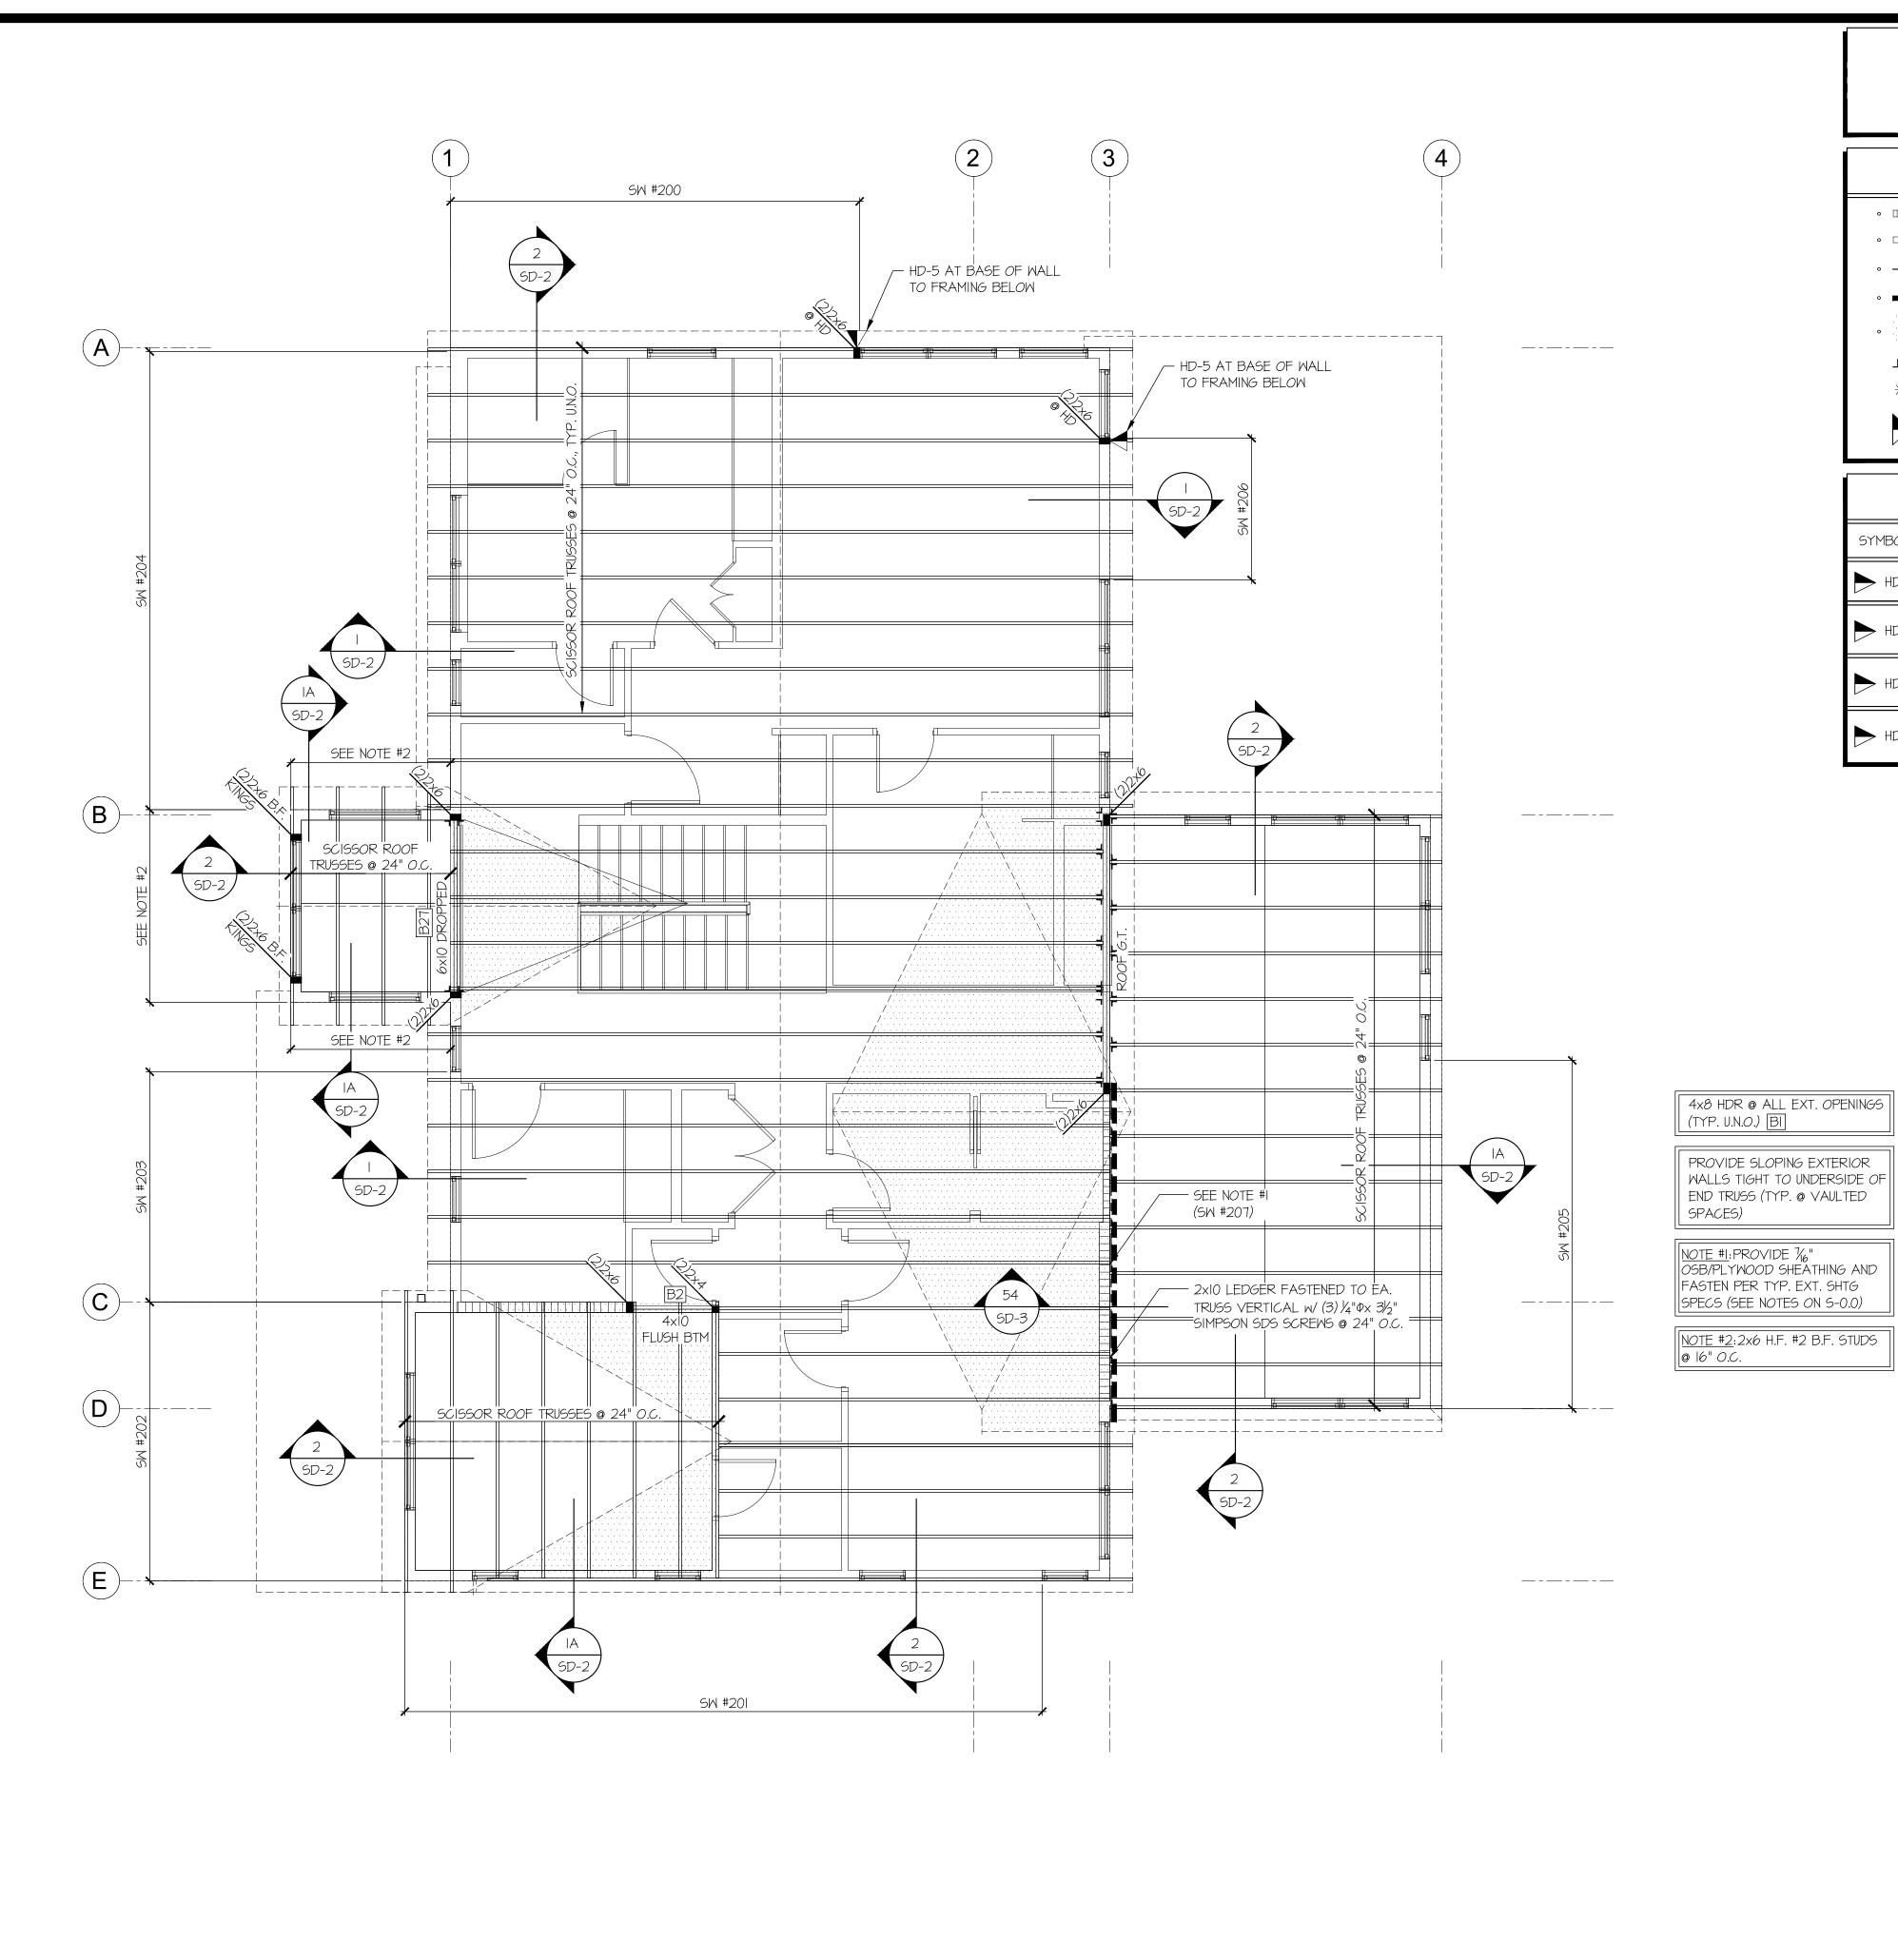
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LOOR FRMG



ROOF FRAMING PLAN

SCALE: 1/4"=1'-0"

REFER TO S-0.0 FOR TYPICAL STRUCTURAL NOTES & SCHEDULES

LEGEND

- IIIIII INTERIOR BEARING WALL
- □□□□□ BEARING WALL ABOVE (B.W.A.), OR SHEARWALL ABOVE (S.W.A.)
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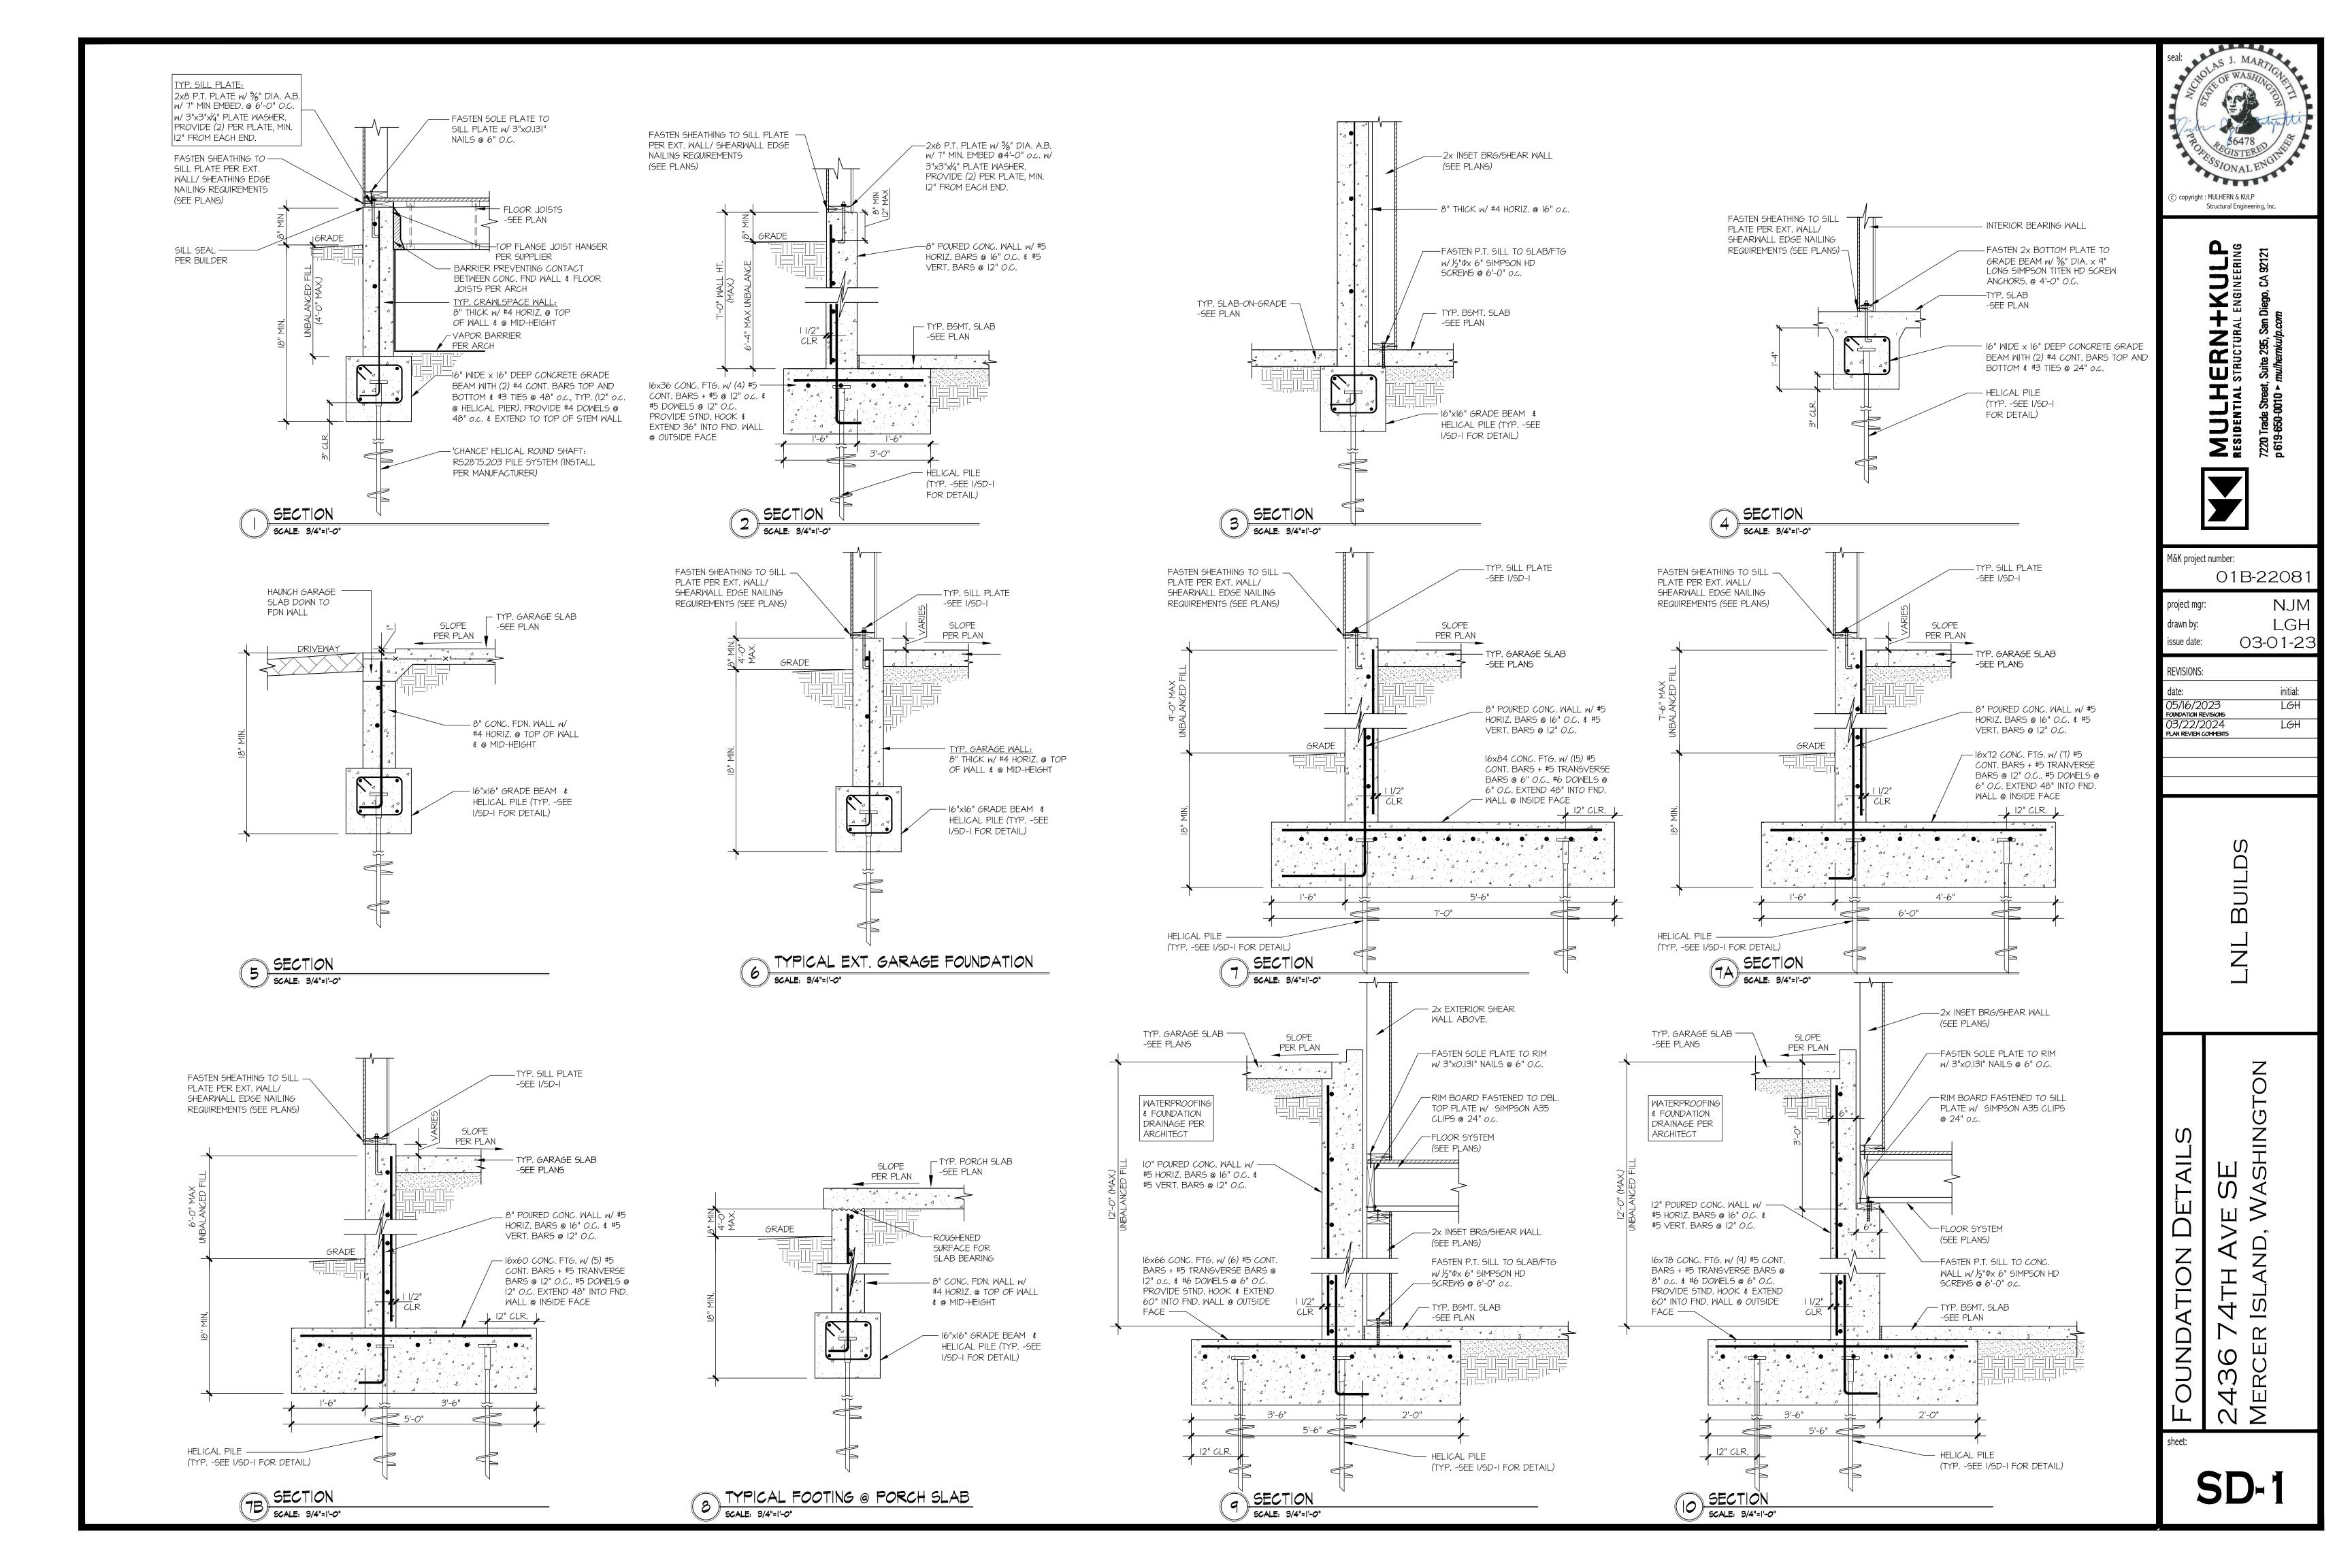
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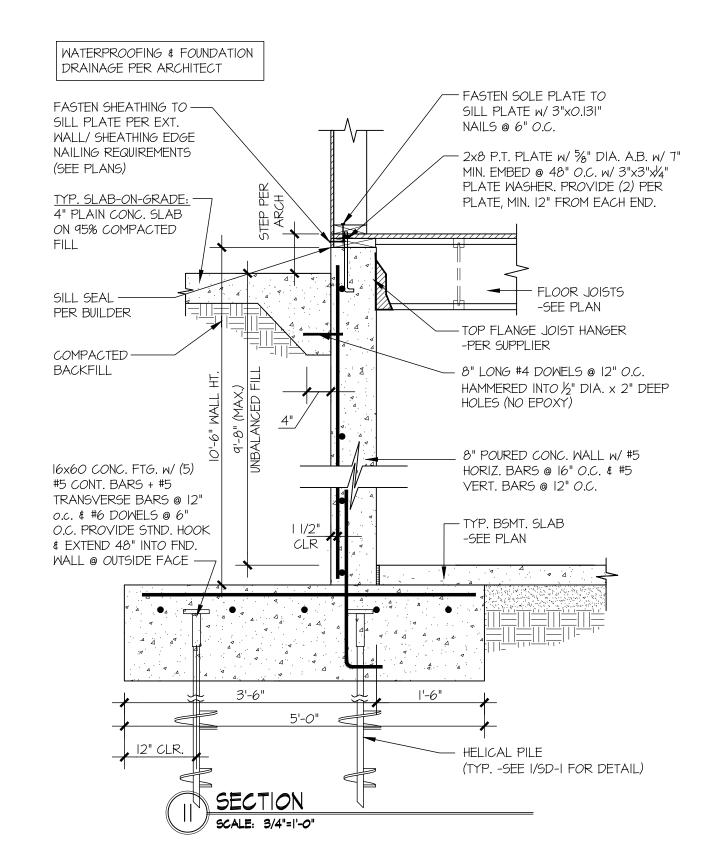
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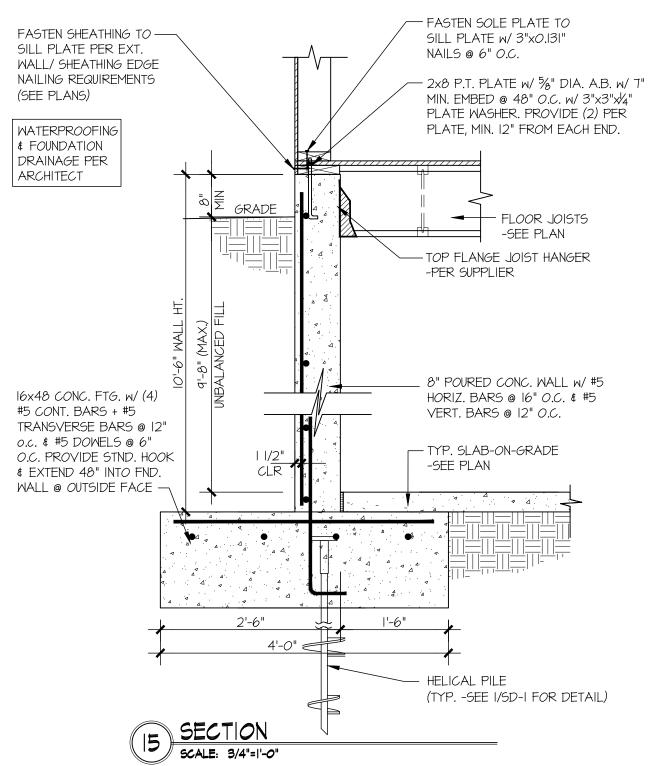
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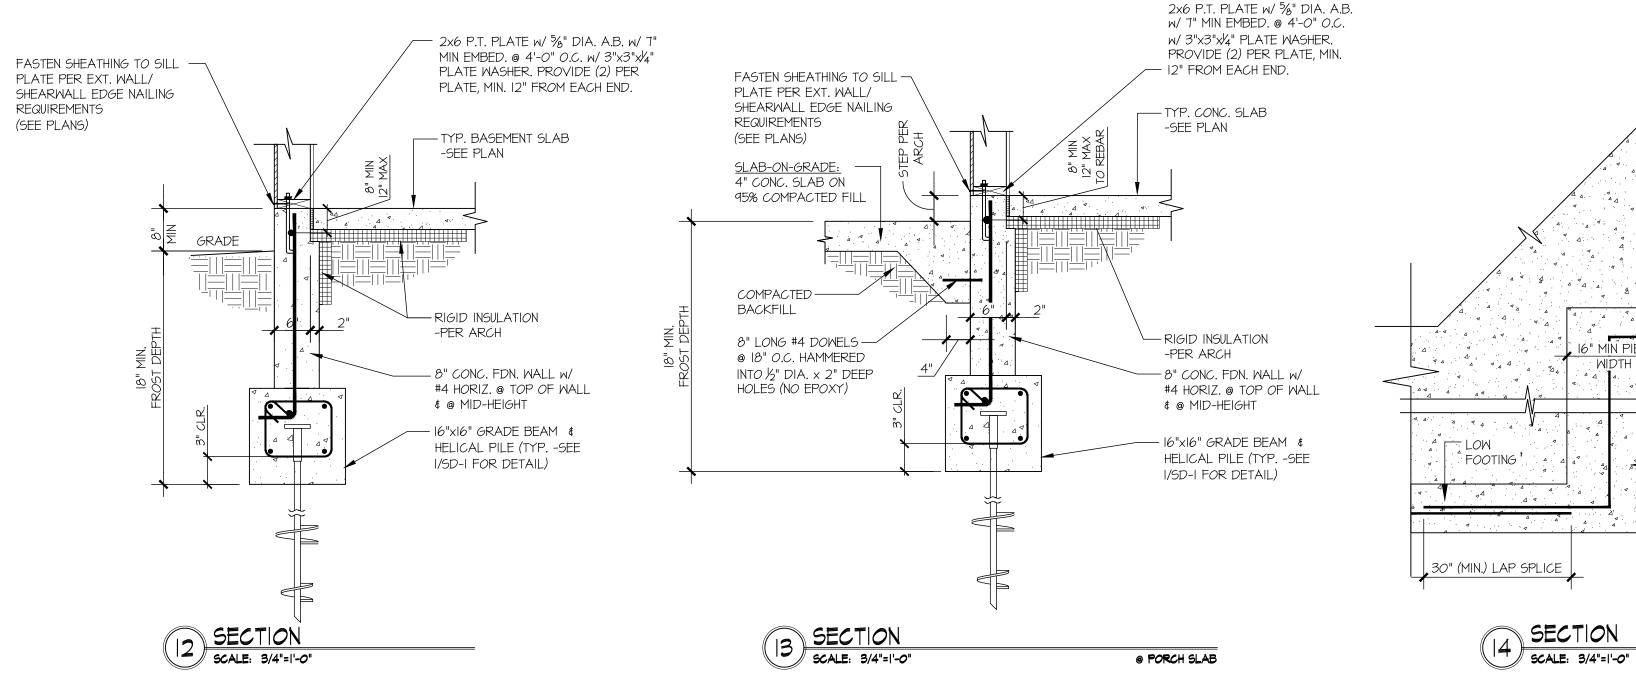
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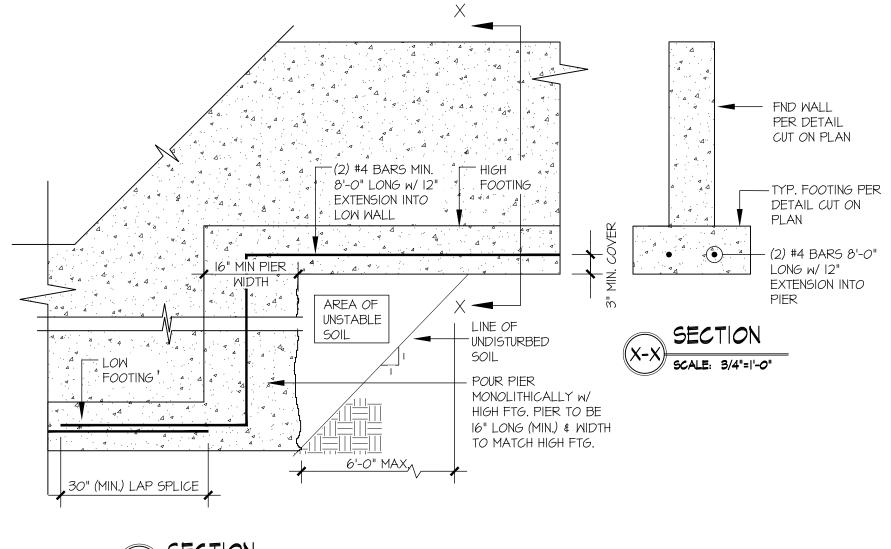
FRAMING PLAN













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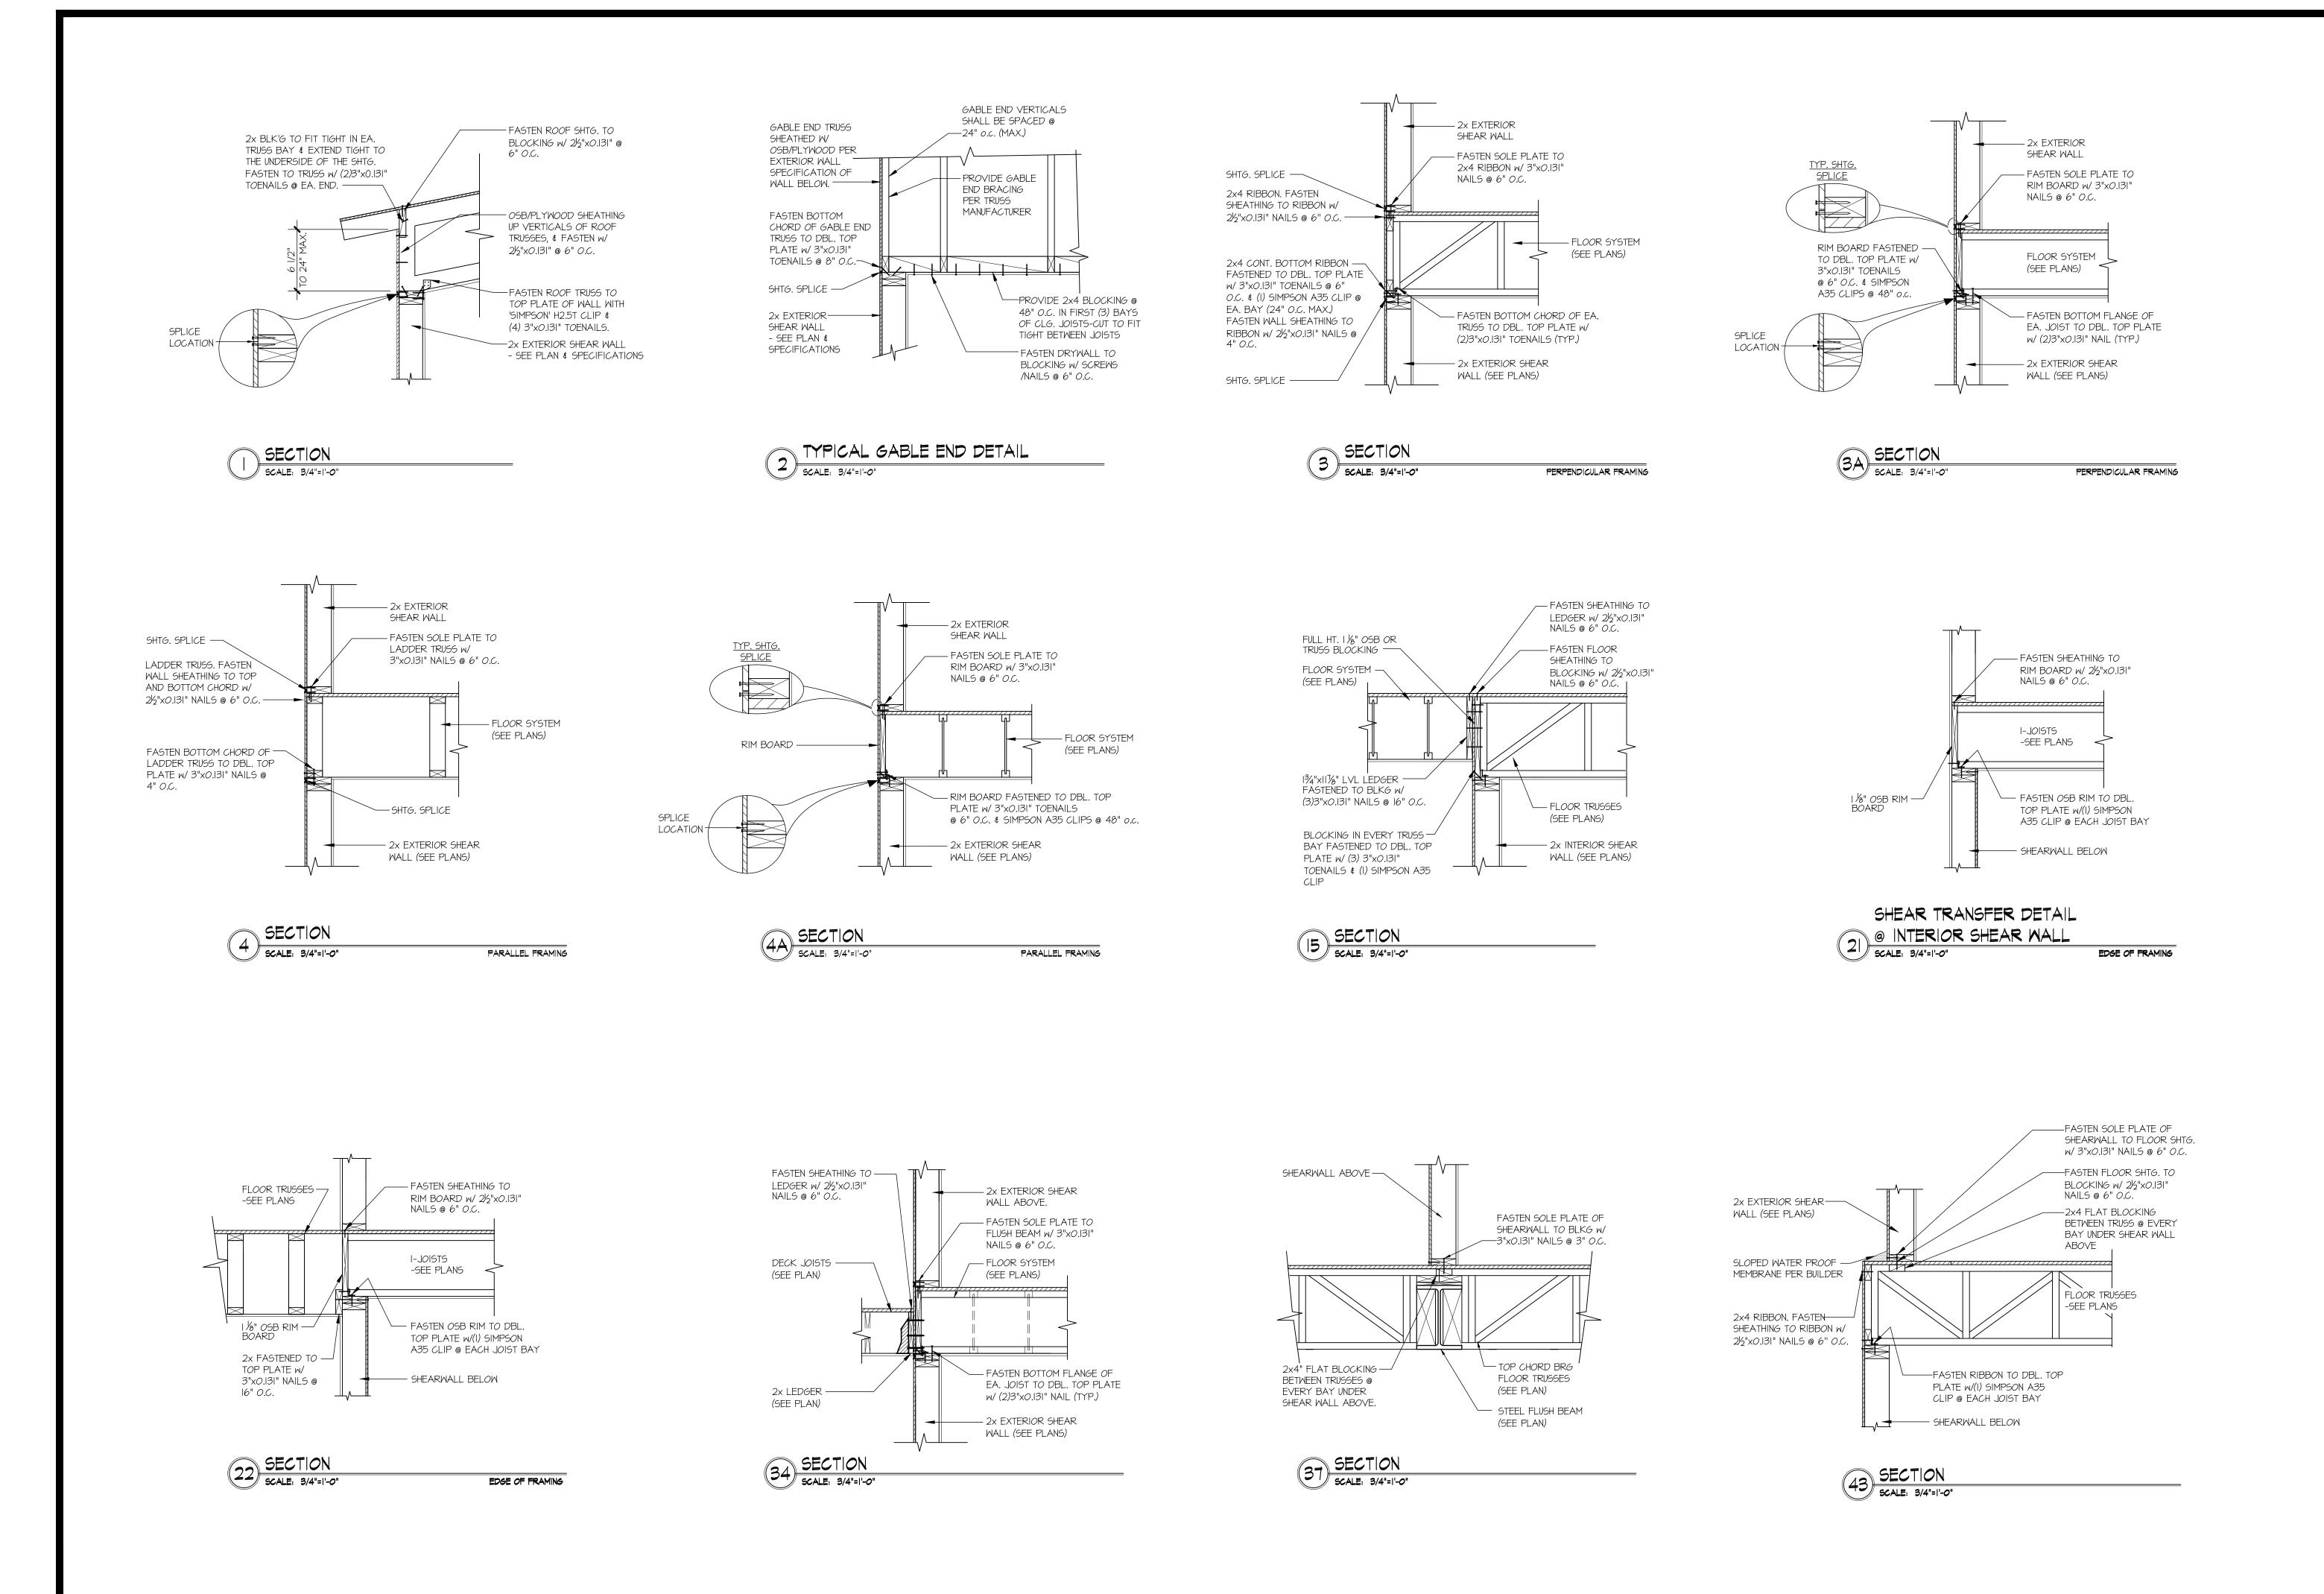
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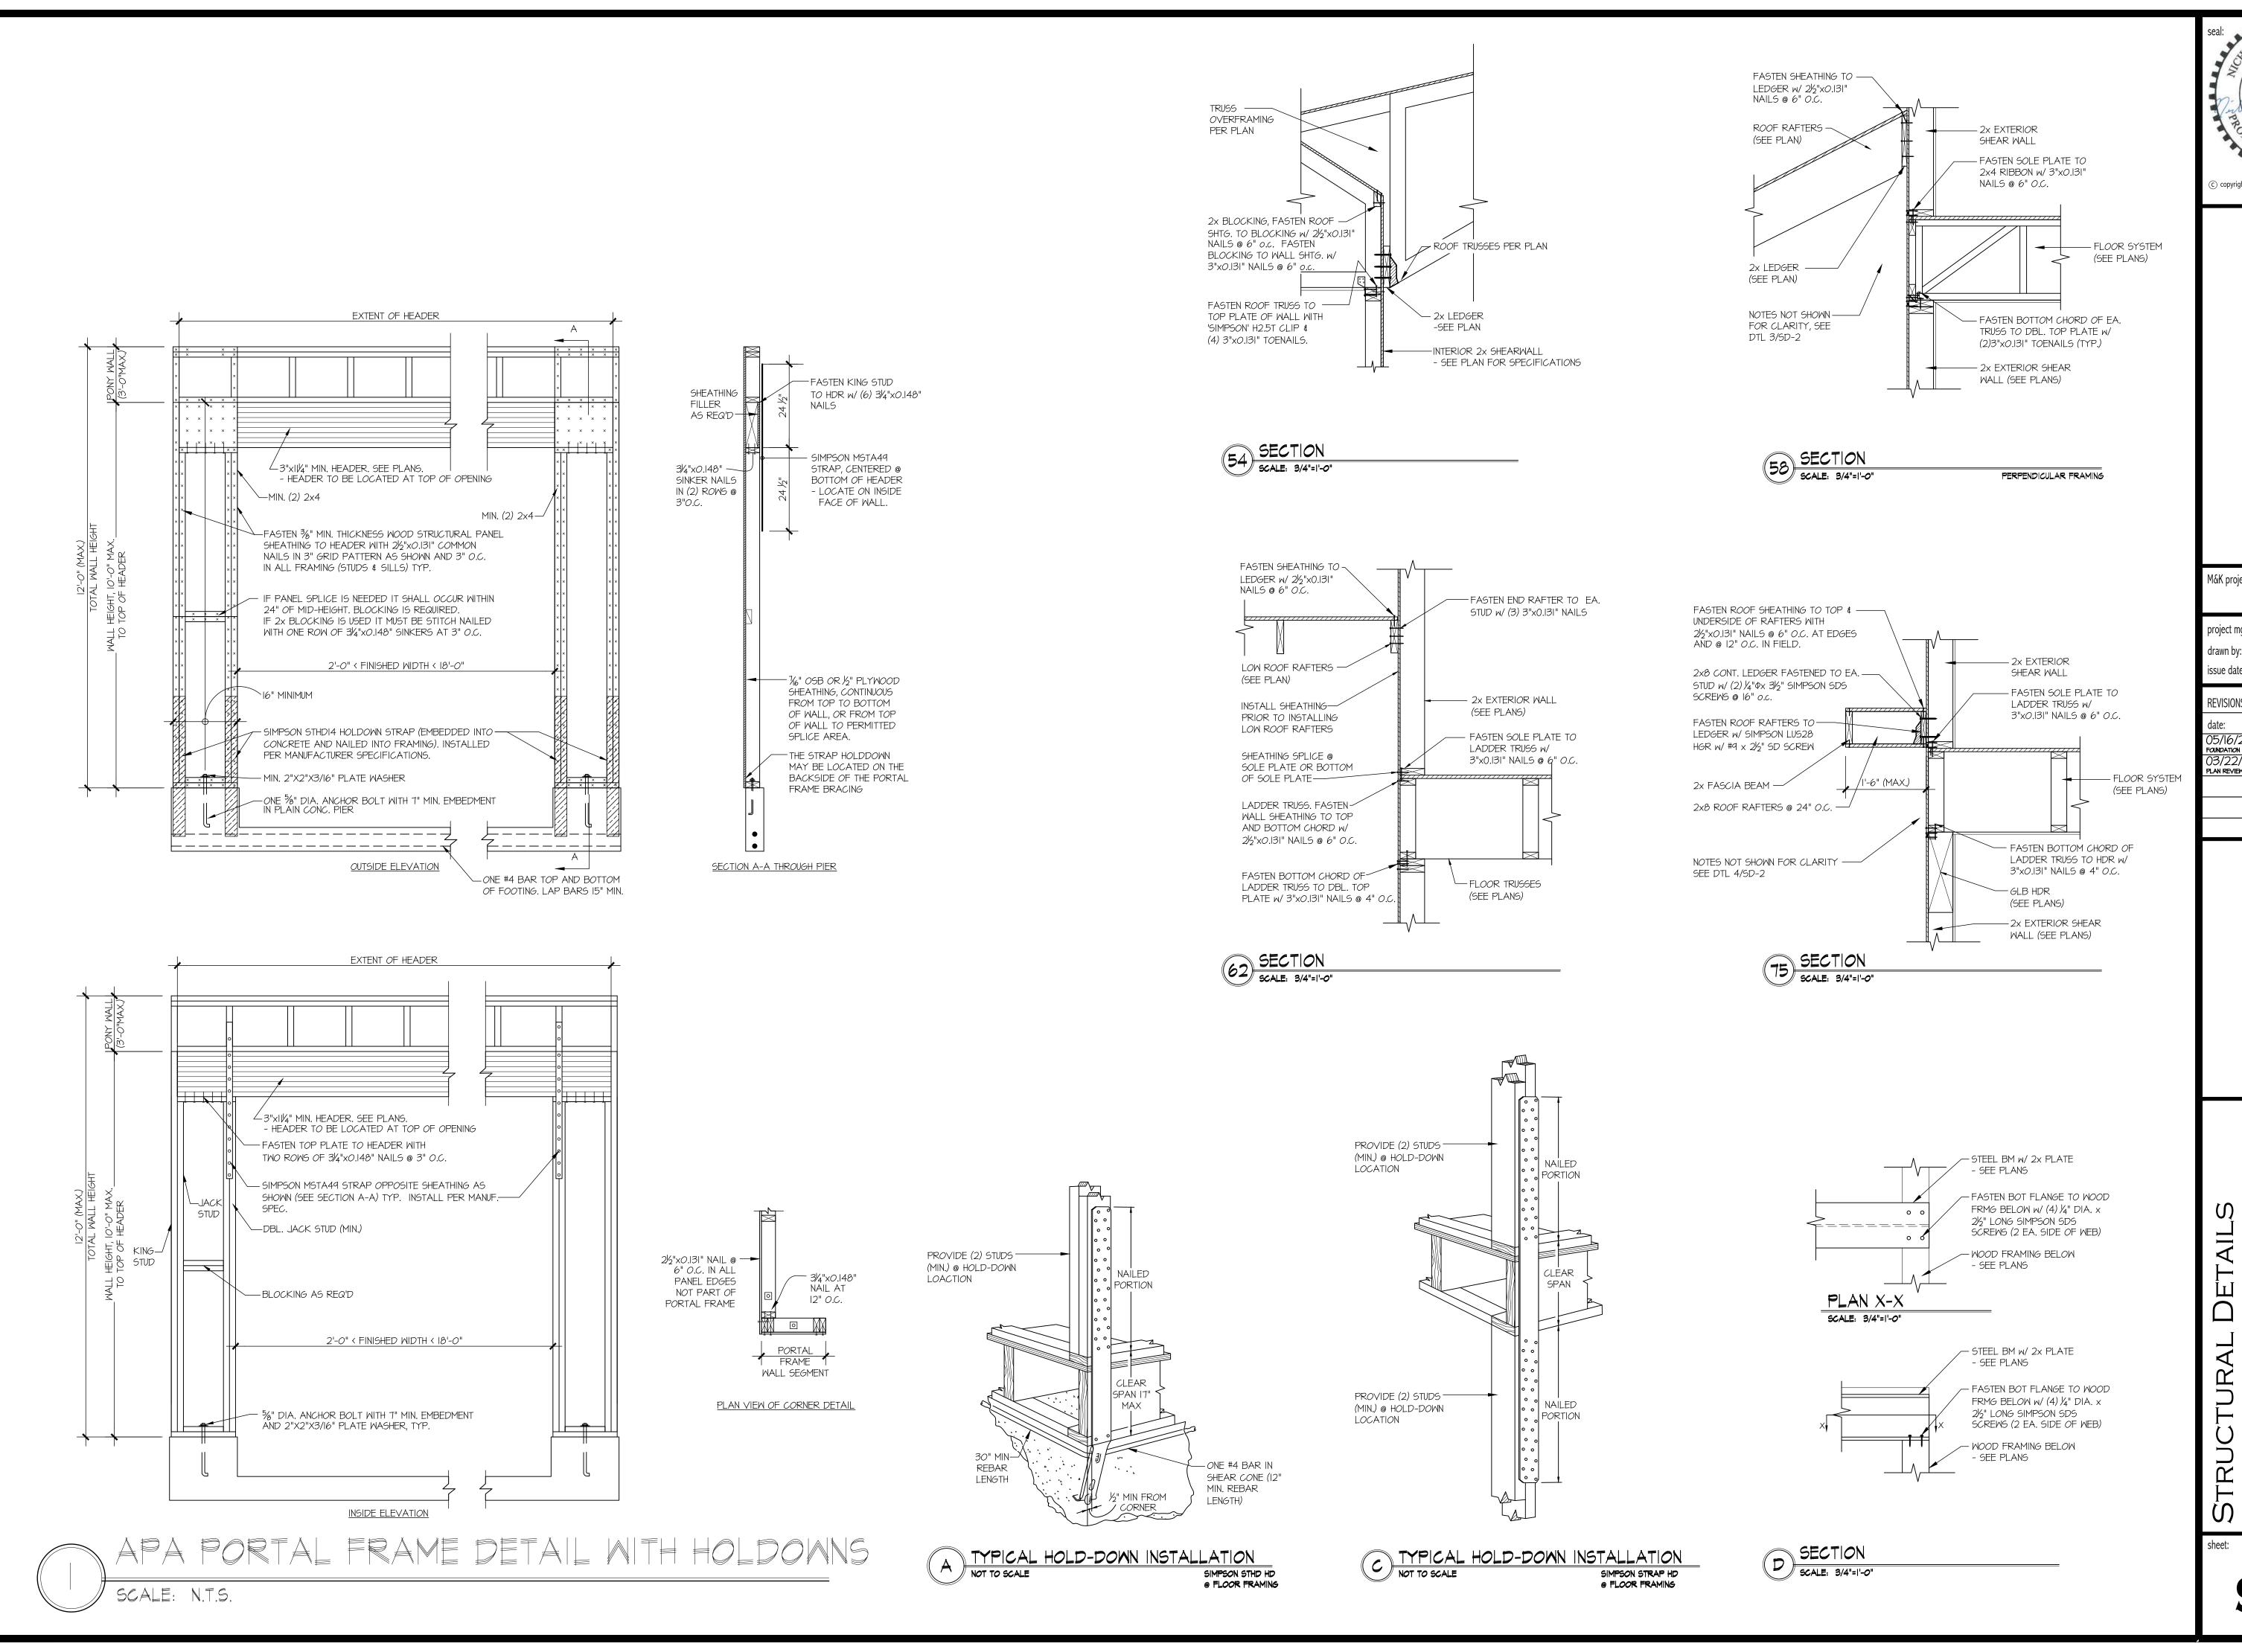
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OF WASHINGTON COMMITMENT. D.R. STRONG CONSULTING ENGINEERS, LLC HAS RELIED WHOLLY ON SAID CHICAGO TITLE COMPANY OF WASHINGTON REPRESENTATIONS OF THE TITLE'S CONDITION TO PREPARE THIS SURVEY AND THEREFORE D.R. STRONG CONSULTING PARCEL B: ENGINEERS. LLC QUALIFIES THE MAP'S ACCURACY AND COMPLETENESS TO THAT EXTENT. 2. THIS SURVEY REPRESENTS VISIBLE PHYSICAL IMPROVEMENT CONDITIONS EXISTING ON APRIL 13, 2023. ALL SURVEY CONTROL

ALL TITLE INFORMATION SHOWN ON THIS MAP HAS BEEN EXTRACTED FROM CHICAGO TITLE COMPANY OF WASHINGTON COMMITMENT NO

0187036-16, UPDATE 2ND COMMITMENT DATED NOVEMBER 24, 2021. IN PREPARING THIS MAP, D.R. STRONG CONSULTING ENGINEERS, LLC

AFFECTING THE SURVEYED PROPERTY OTHER THAN THOSE SHOWN ON THE MAP AND DISCLOSED BY REFERENCED CHICAGO TITLE COMPANY

HAS CONDUCTED NO INDEPENDENT TITLE SEARCH NOR IS D.R. STRONG CONSULTING ENGINEERS, LLC AWARE OF ANY TITLE ISSUES

INDICATED AS "FOUND" WAS RECOVERED FOR THIS PROJECT ON APRIL 6, 2023 UNLESS NOTED OTHERWISE.

3. PROPERTY AREA: $PARCEL A = 7,999 \pm SQUARE FEET (0.1836 \pm ACRES).$ PARCEL $B = 25,800 \pm SQUARE FEET (0.5923 \pm ACRES)$.

4. ALL DISTANCES ARE IN U.S. SURVEY FEET.

5. THIS IS A COMBINED FIELD TRAVERSE AND GLOBAL NAVIGATION SATELLITE SYSTEMS SURVEY. A TRIMBLE S7 ONE SECOND COMBINED ELECTRONIC TOTAL STATION AND A TRIMBLE R12i GLOBAL NAVIGATION SATELLITE SYSTEMS (GNSS) RECEIVER WERE USED TO MEASURE THE 3. SURVEY - RECORDING NO. 8501049012. ANGULAR AND DISTANCE RELATIONSHIPS BETWEEN THE CONTROLLING MONUMENTATION AS SHOWN. CLOSURE RATIOS OF THE TRAVERSE MET OR EXCEEDED THOSE SPECIFIED IN WAC 332-130-090. ALL MEASURING INSTRUMENTS AND EQUIPMENT ARE MAINTAINED IN ADJUSTMENT ACCORDING TO MANUFACTURER'S SPECIFICATIONS.

6. RTK GNSS OBSERVATIONS WERE MADE ON 04/06/2023 UTILIZING THE WASHINGTON STATE REFERENCE NETWORK (WSRN). THE COMBINED GRID TO GROUND SCALE FACTOR USED IS 0.999980520.

7. UTILITIES OTHER THAN THOSE SHOWN MAY EXIST ON THIS SITE. ONLY THOSE UTILITIES WITH EVIDENCE OF THEIR INSTALLATION VISIBLE AT GROUND SURFACE ARE SHOWN HEREON. UNDERGROUND UTILITY LOCATIONS SHOWN ARE APPROXIMATE ONLY. UNDERGROUND CONNECTIONS ARE SHOWN AS STRAIGHT LINES BETWEEN SURFACE UTILITY LOCATIONS BUT MAY CONTAIN BENDS OR CURVES NOT SHOWN. SOME UNDERGROUND LOCATIONS SHOWN HEREON MAY HAVE BEEN TAKEN FROM PUBLIC RECORDS. D.R. STRONG CONSULTING ENGINEERS INC. ASSUMES NO LIABILITY FOR THE ACCURACY OF PUBLIC RECORDS.

8. THE BOUNDARY SHOWN HEREON IS BASED ON A FIELD SURVEY.

9. CONTOURS ARE DERIVED FROM DIRECT FIELD OBSERVATION. CONTOUR ACCURACY IS WITHIN ONE-HALF CONTOUR INTERVAL PER NATIONAL MAPPING STANDARDS.

10. THIS SURVEY WAS PERFORMED IN SUPPORT OF ENGINEERING DESIGN.

CONSTRUCTION SEQUENCE

ARRANGE AND ATTEND A PRECONSTRUCTION MEETING WITH THE CITY INSPECTOR. FLAG OR FENCE CLEARING LIMITS.

CALL ONE-CALL UTILITY LOCATE SERVICE PRIOR TO ANY EXCAVATION WORK. 4. GRADE INSTALL ROCK CONSTRUCTION ENTRANCE IF NECESSARY.

5. INSTALL PERIMETER PROTECTION (SILT FENCE, BRUSH BARRIER, ETC.).

6. CONSTRUCT RESIDENCE AND OTHÈR SITE IMPROVEMENTS.

7. MAINTAIN EROSION CONTROL MEASURES IN ACCORDANCE WITH CITY OR COUNTY STANDARDS AND MANUFACTURER'S RECOMMENDATIONS.

3. MAINTAIN ACCESS TO OFF-SITE ROADS AND DRIVEWAYS AT ALL TIMES DURING THE DURATION OF THE PROJECT. 9. RELOCATE EROSION CONTROL MEASURES OR INSTALL NEW MEASURES SO THAT AS SITE CONDITIONS CHANGE THE EROSION AND

SEDIMENT CONTROL IS ALWAYS IN ACCORDANCE WITH THE CITY TESC MINIMUM REQUIREMENTS. 10. COVER ALL AREAS THAT WILL BE UNWORKED FOR MORE THAN SEVEN DAYS DURING THE DRY SEASON OR TWO DAYS DURING THE WET SEASON WITH STRAW, WOOD FIBER MULCH, COMPOST, PLASTIC SHEETING OR EQUIVALENT.

11. STABILIZE ALL AREAS THAT REACH FINAL GRADE WITHIN SEVEN DAYS. 12. SEED OR SOD ANY AREAS TO REMAIN UNWORKED FOR MORE THAN 30 DAYS.

13. UPON COMPLETION OF THE PROJECT, ALL DISTURBED AREAS MUST BE STABILIZED AND BMPS REMOVED IF APPROPRIATE AFTER ACCEPTANCE BY INSPECTOR.

LEGAL DESCRIPTION:

PARCEL B OF CITY OF MERCER ISLAND LOT LINE REVISION NO. SUB14-011. RECORDED UNDER RECORDING NUMBER 20150528900006, IN KING COUNTY SITUATE IN THE COUNTY OF KING, STATE OF WASHINGTON.

REFERENCES:

1. PLAT - MCGILVRA'S ISLAND ADDITION, VOLUME 16, PAGE 58 OF PLATS.

2. LOT LINE REVISION SUB14-011, RECORDING NO. 20150528900006.

HORIZONATAL DATUM:

WASHINGTON PLANE COORDINATE SYSTEM, NORTH ZONE. NAD83-2011 EPOCH 2010.00 (SEE SURVEY NOTE 6)

VERTICAL DATUM:

NAVD 88 PER GNSS OBSERVATION (SEE SURVEY NOTE 6)

BENCHMARK:

3.5" DIA. CONCRETE MONUMENT WITH 1/2" BRASS PLUG AND PUNCH IN MONUMENT CASE AT THE INTERSECTION OF SE 24TH ST. AND 74TH AVE. SE. BENCHMARK IS TOP OF CONCRETE MONUMENT.

P.E. CERTIFICATION FOR SECTION B:

HEREBY STATE THAT THIS CONSTRUCTION STORMWATER POLLUTION PREVENTION PLAN FOR 2430 74TH AVE SE HAS BEEN PREPARED BY ME OR UNDER MY SUPERVISION AND MEETS THE STANDARD OF CARE AND EXPERTISE WHICH IS USUAL AND CUSTOMARY IN THIS COMMUNITY FOR PROFESSIONAL ENGINEERS. UNDERSTAND THAT THE CITY OF MERCER ISLAND DOES NOT AND WILL NOT ASSUME LIABILITY FOR THE SUFFICIENCY, SUITABILITY, OR PERFORMANCE OF CONSTRUCTION SWPPP BMPS PREPARED BY ME.

SURVEY CONTOUR NOTE:

SEE NOTE ON BOUNDARY AND TOPOGRAPHIC SURVEY. ADDITIONAL SURVEY POINTS WERE TAKEN TO ENSURE THE AVERAGE CONTOUR ELEVATION WITHIN THE VICINITY OF THE BUILDING FOOTPRINT IS ACCURATE WITHIN 6 INCHES VERTICALLY AND HORIZONTALLY FROM ACTUAL ELEVATIONS.

TITLE RESTRICTIONS: (NOTE: NOT ALL DOCUMENTS PROVIDED.) EASEMENT GRANTED TO MERCER ISLAND SEWER DISTRICT FOR A SEWER PIPELINE. RECORDING NO. 4655731. AFFECTS PORTIONS OF PARCEL A AND OTHER PROPERTY

2. 4-FOOT WIDE EASEMENT FOR SIDE SEWER - AS CONSTRUCTED, RECORDING NO. 4995706. NOT PLOTTABLE. AFFECTS PORTION OF PARCEL B AND OTHER PROPERTY. [NOT PROVIDED]

3. 7-FOOT WIDE EASEMENT FOR UTILITIES INCLUDING POWER, LIGHT, GAS, WATER SEWER AND TELEPHONE, RECORDING NO. 5601958. AFFECTS NORTHERLY PORTION OF PARCEL A. [NOT PROVIDED]

4. TEMPORARY CRANE BOOM EASEMENT, RECORDING NO. 20101007000106. EASEMENT DOES NOT APPEAR TO IMPACT CURRENT LEGAL DESCRIPTION OF PARCEL A AND MAY HAVE SELF TERMINATED.

MAINTENANCE AND CONSTRUCTION EASEMENT, RECORDING NO. 20101007000107. DOES NOT APPEAR TO IMPACT CURRENT DESCRIPTION OF PARCEL A.

6. COVENANTS, CONDITIONS AND RESTRICTIONS, IF ANY, AS PERMITTED BY APPLICABLE LAW, AS SET FORTH IN DOCUMENT RECORDING NO. 6158024. [NOT PROVIDED]

7. HOLD HARMLESS AGREEMENT, RECORDING NO. 2016012000200 [INCOMPLETE RECORDING NO., COPY NOT PROVIDED]]

COVENANTS, CONDITIONS AND RESTRICTIONS, IF ANY, AS PERMITTED BY APPLICABLE LAW, AS SET FORTH ON LOT LINE REVISION NO. SUB14-011, RECORDING NO.

TIEBACK AND SHORING EASEMENT, RECORDING NO. 20170530001254. AFFECTS EASTERLY PORTION OF PARCELS A AND B. NO DEFINITE LOCATION DESCRIBED. MAY HAVE SELF TERMINATED.

10. EASEMENT FOR SEWER LINE, RECORDING NO. 20170530001263. SHOWN HEREON. 11. HOLD HARMLESS AGREEMENT, RECORDING NO. 20170710000863. NOT SURVEY

12. RESTAURANT AGREEMENT, RECORDING NO. 20171113001170. NOT SURVEY RELATED. 13-16. RELATED TO TAXES AND ASSESSMENTS. NOT SURVEY RELATED.

17. NOTING ENCROACHMENT OF A "TRASH CORRAL"

TESC LEGEND:

→(CH)**→**

FOR ADDITIONAL TESC DETAILS REFER TO DOE 2012/ 2014 SWMMWW CONSTRUCTION LIMITS, TO BE FLAGGED OR FENCED WHEN NO SILT FENCE IS

PROPOSED (BMP C103) SILT FENCE IS PROPOSED (BMP C233) STABILIZED CONSTRUCTION ENTRANCE (BMP C105) → (SSV) → STREET SWEEPING & VACUUMING INLET PROTECTION (BMP C220) OC-DUST CONTROL (BMP C140) MULCHING, MATTING, & COMPOST

BLANKETS (BMP C121, BMP C125) PERMANENT SEEDING AND PLANTING (BMP C120) POST-CONSTRUCTION SOIL QUALITY & DEPTH (BMP T5.13) SEE DETAIL ON SHEET C2 CONCRETE HANDLING (BMP C151)

PLASTIC COVERING (BMP C123)

EARTHWORK VOLUME CALCULATIONS

(CU. YDS.) (CU. YDS.) (CU. YDS.) *302* 231 ALL VOLUMES ARE APPROXIMATE AND ARE PROVIDED FOR PERMITTING

CUT VOLUME FILL VOLUME NET VOLUME

PURPOSES AND REPRESENT FINISH GRADE TO EXISTING GRADE AS SHOWN. CONTRACTOR SHALL RELY ON HIS/HER OWN ESTIMATES FOR DETERMINING ACTUAL FARTHWORK QUANTITIES. THE VOLUMES DO NOT INCLUDE STRIPPING, UTILITY EXCAVATION, EXPANSION/COMPACTION FACTOR OR ANY SOIL TYPE RESTRICTIONS.



VICINITY MAP



PROJECT CONTACTS:

PROPERTY OWNER/APPLICANTVANN LANZ LNL BUILDS, LLC. 317 4TH STREET KIRKLAND, WA 98033 (206) 499-1277 VANN@LNLBUILDS.COM

.. D.R. STRONG CONSULTING ENGINEERS, INC. CIVIL ENGINEER/SURVEYOR... 620 7TH AVENUE

KIRKLAND, WASHINGTON 98033 . (425) 827-3063 ..CONTACT: MAHER A. JOUDI, P.E. MAHER.JOUDI@DRSTRONG.COM

GEOTECHNICAL ENGINEER. ..EARTH SOLUTIONS NW .15365 NE 90TH ST #100 REDMOND, WASHINGTON 98052 .(425) 449-4704

CONTACT: SCOTT RIEGEL SCOTTR@ESNW.COM ENVIRONMENTAL ENGINEER..... ...ALTMANN OLIVER ASSOCIATES, LLC. . PO BOX 578

. CARNATION, WA 98014 ...(425) 333–4535 ...CONTACT: JOHNN ALTMANN ..JOHN@ALTOLIVER.COM

ARBORIST... ..DAVEY RESOURCE GROUP, INC. 18809 10TH AVE NE SHORELINE, WA

.(253)_656-1650 PROJECT DESCRIPTION:

.2436 74TH AVE SE SITE ADDRESS: ..

TAX PARCEL NUMBER:.. .5315100455 NUMBER OF LOTS:.....

ZONING:R−9.6 .25,799 S.F. (0.592 ACRES)

..6,561 S.F. (0.194 ACRES) GROSS PROJECT AREA:.. PROPOSED IMPERVIOUS AREA: .3,409 S.F. (13.2%) OFFSITE IMPERVIOUS AREA:

....0 S.F. (0.0%) REPLACED IMPERVIOUS AREA:.. PROPOSED PERVIOUS AREA:. ..22,390 S.F. (86.8%) EXISTING LOT COVERAGE:. ..0 S.F. (0.0%)

PROPOSED LOT COVERAGE: ..2,616 S.F. (10.14%)

NUMBER OF PARKING SPACES:. GRADING NOTE:

TOTAL AREA TO BE DISTURBED OFF-SITE...1,040 S.F. FILL SHALL CONSIST OF SUITABLE MATERIAL ORIGINATING FROM THE SITE OR FROM AN APPROVED SUPPLIER.

TOTAL AREA TO BE DISTURBED ON-SITE....5,521 S.F.

CONSTRUCTION NOTES:

1. ALL UTILITIES TO BE DISCONNECTED OR REMOVED PRIOR TO THE START

OF THE PROJECT. COORDINATE WITH UTILITY COMPANIES PRIOR TO DISCONNECTION OR REMOVAL.

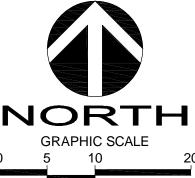
SOIL AMENDMENT NOTE: AREA (A) ENCOMPASSES THE ENTIRE SITE OUTSIDE OF HARD SURFACES. SEE LANDSCÁPE PLANS FOR TURF AND PLANTING BED AREAS. STOCKPILE SITE DUFF AND TOPSOIL FOR ALL DISTURBED PERVIOUS AREAS AND REAPPLY WITH SOIL AMENDMENT AFTER GRADING AND CONSTRUCTION. MINIMUM SCARIFICATION DEPTH 8-INCHES. PROVIDE A TOTAL OF 14.4 C.Y. OF AMENDMENT FOR AN AREA OF 2,665 S.F. (AREAS FOR TURF AND PLANTING BEDS TO BE

GENERAL EROSION CONTROL NOTES:

ALL DISTURBED AREAS SHALL BE STABILIZED USING TYPICAL TESC BMP'S. THE LIMITS OF DISTURBANCE WILL BE DELINEATED WITH HIGH VISIBILITY CONSTRUCTION FENCING. DURING CONSTRUCTION SILT FENCES WILL BE PLACED DOWN SLOPE OF DISTURBED AREAS ALONG WITH STRAW MATTING, NETS, OR PLASTIC COVERING OVER EXPOSED SOIL OR STOCKPILES. TREES TO BE RETAINED WILL BE PROTECTED WITH HIGH VISIBILITY CONSTRUCTION FENCING.

AT THE COMPLETION OF THE PROJECT ALL DISTURBED AREAS WILL BE STABILIZED WITH COMPOST AMENDED SOILS AND HYDROSEEDING OR SOD. EXPOSED SOILS SHALL BE WORKED DURING THE WEEK UNTIL THEY HAVE BEEN STABILIZED. SOIL STOCKPILES WILL BE LOCATED WITHIN THE DISTURBED AREA SHOWN ON THE SWPPP SITE MAP. SOIL EXCAVATED FOR THE FOUNDATION WILL BE BACKFILLED AGAINST THE FOUNDATION AND GRADED TO DRAIN AWAY FROM THE BUILDING. NO SOILS SHALL REMAIN EXPOSED AND UNWORKED FOR MORE THAN 7 DAYS FROM MAY 1 TO SEPTEMBER 30 OR MORE THAN 2 DAYS FROM OCTOBER 1 TO APRIL 30. ONCE THE

DISTURBED LANDSCAPE AREAS ARE GRADED, THE GRASS AREAS WILL BE AMENDED USING BMP T5.13 POST-CONSTRUCTION SOIL QUALITY AND DEPTH. ALL STOCKPILES WILL BE COVERED WITH PLASTIC OR BURLAP IF LEFT UNWORKED.




1 INCH=10 FT.






ENGINEERS PLANNERS SURVEYORS 620 - 7th AVENUE KIRKLAND, WA 98033 O 425.827.3063 F 425.827.2423

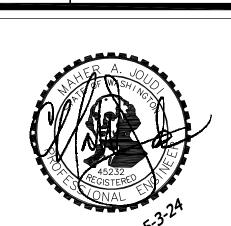ANN LANZ BUILDS, LLO



DRAFTED BY: RMF DESIGNED BY: RMF PROJECT ENGINEER: MAJ DATE: **9.26.23** PROJECT NO.: 23001

DRAWING: C1 SHEET: **1** OF **5**

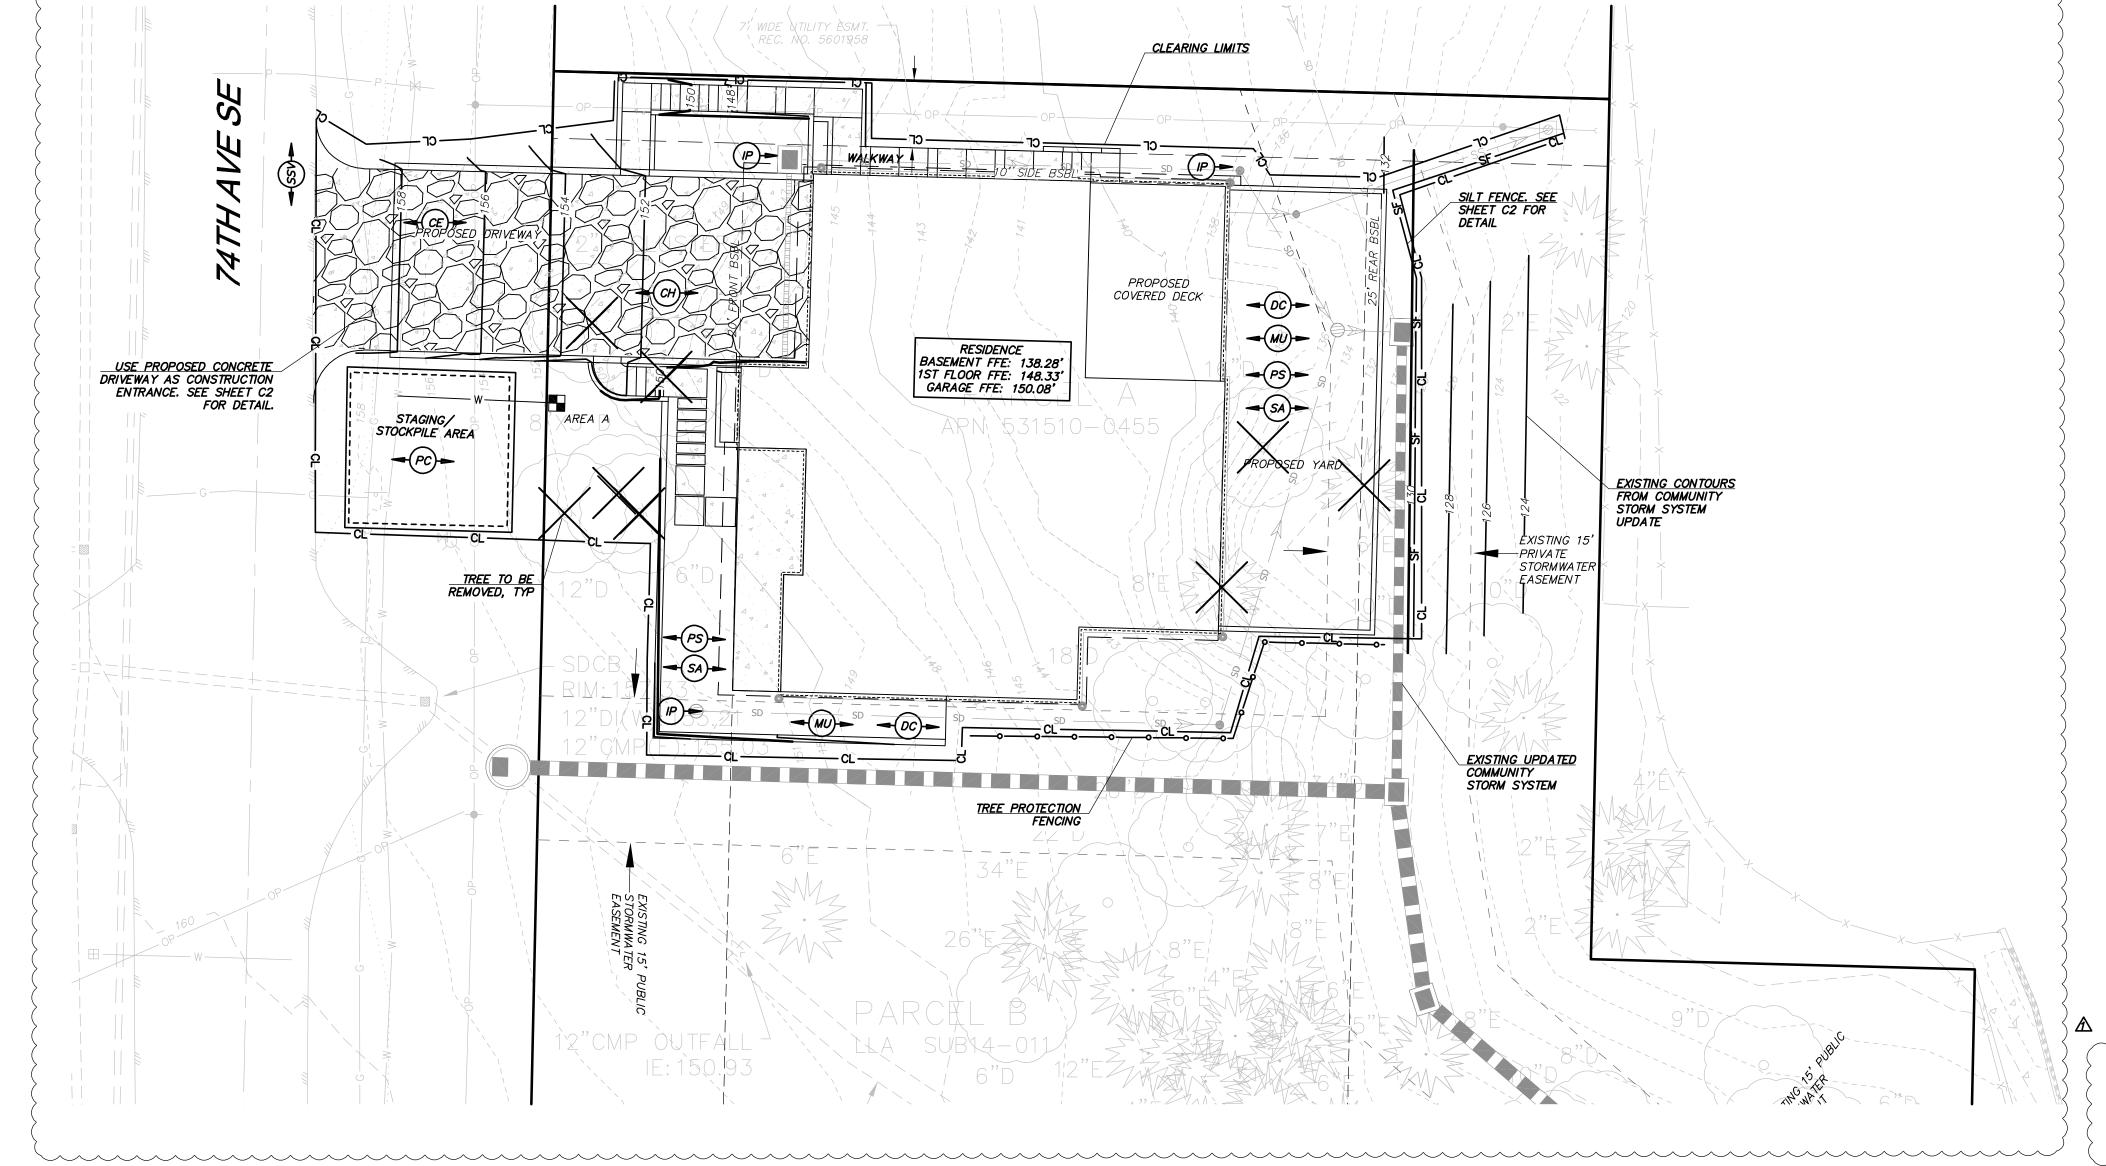


SHEET INDEX: COVER SHEET & T.E.S.C. PLAN C2 OF 5 T.E.S.C. NOTES & DETAILS C3 OF 5 TREE RETENTION PLAN C4 OF 5 TREE RETENTION PLAN C5 OF 5 STORM DRAINAGE PLAN

BASIS OF BEARINGS: N 88'29'52" W BETWEEN THE MONUMENTS



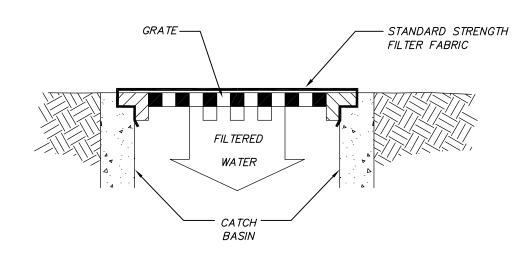2436 74TH AVE SE



CATCH BASIN INSERT MAINTENANCE STANDARDS

- 1. ANY ACCUMULATED SEDIMENT ON OR AROUND THE FILTER FABRIC PROTECTION SHALL BE REMOVED IMMEDIATELY. SEDIMENT SHALL NOT BE REMOVED WITH WATER, AND ALL SEDIMENT MUST BE DISPOSED OF AS FILL ON SITE OR HAULED OFF SITE.
- 2. ANY SEDIMENT IN THE CATCH BASIN INSERT SHALL BE REMOVED WHEN THE SEDIMENT HAS FILLED ONE—THIRD OF THE AVAILABLE STORAGE. THE FILTER MEDIA FOR THE INSERT SHALL BE CLEANED OR REPLACED AT
- 3. REGULAR MAINTENANCE IS CRITICAL FOR BOTH FORMS OF CATCH BASINS PROTECTION. UNLIKE MANY FORMS OF PROTECTION THAT FAIL GRADUALLY, CATCH BASIN PROTECTION WILL FAIL SUDDENLY AND COMPLETELY IF NOT MAINTAINED PROPERLY.

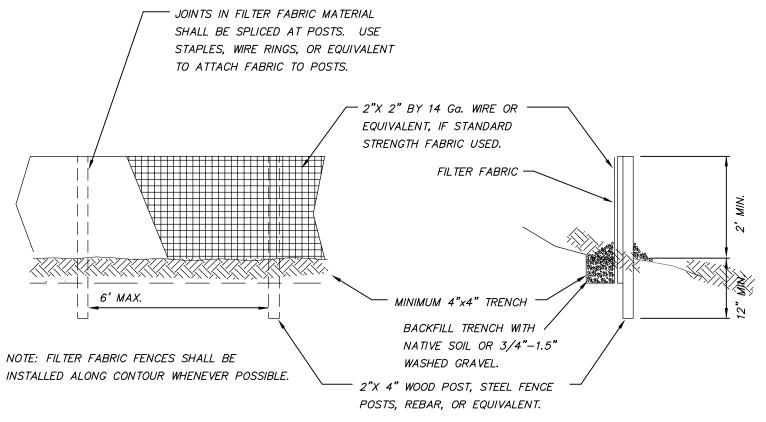
SILT FENCE DETAIL

CATCH BASIN INLET FILTER

OVERFLOW WILL NOR RESULT IN EROSION OF SLOPES.

NOTE: ONLY TO BE USED WHERE PONDING OF WATER ABOVE THE

CATCH BASIN WILL NOT CAUSE TRAFFIC PROBLEMS AND WHERE



- 1. ANY DAMAGE SHALL BE REPAIRED IMMEDIATELY. 2. IF CONCENTRATED FLOWS ARE EVIDENT UPHILL OF THE FENCE, THEY MUST BE INTERCEPTED AND
- CONVEYED TO A SEDIMENT TRAP OR POND. 3. IT IS IMPORTANT TO CHECK THE UPHILL SIDE OF THE FENCE FOR SIGNS OF THE FENCE CLOGGING AND ACTING AS A BARRIER TO FLOW AND THEN CAUSING CHANNELIZATION OF FLOWS PARALLEL TO THE FENCE. IF THIS OCCURS, REPLACE THE FENCE OR REMOVE THE TRAPPED SEDIMENT. 4. SEDIMENT MUST BE REMOVED WHEN THE SEDIMENT
- IS 6 INCHES HIGH.
- 5. IF THE FILTER FABRIC (GEOTEXTILE) HAS DETERIORATED DUE TO ULTRAVIOLET BREAKDOWN, IT SHALL BE REPLACED.

TREE PROTECTION AREA (TPZ)

DO NOT REMOVE OR ADJUST THE APPROVED LOCATION OF THIS TREE PROTECTION AREA

shall occur inside the protective fencing.

^^^^^^

KEEP OUT!

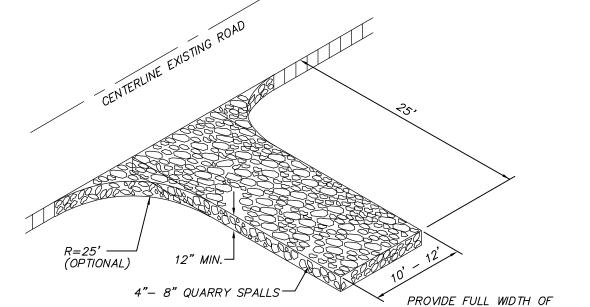
Trees enclosed by this fence are protected and are subject to the conditions of the tree permit. Violation of tree conditions may lead to:

- 1. Correction Notices or Stop Work Orders until compliance is achieved
- 2. RE Inspection Fees/financial penalties
- 3. Arborist reports recommending mitigation Crown drip line or other limit of Tree Protection area. See Site/Utility Plan for fence alignment.
- 1. No pruning shall be performed unless under the direction of the Project Arborist. Including limbing 2. No grading, excavation, storage (materials, equipment, vehicles, etc.), or other unpermitted activity
- 3. Penalties for damaging by root damage/compaction or removing a saved tree may be a fine up to three times the value of the tree plus restoration (MICC 19.10.160).
- 4. Any work in approved TPZ must be with the permission of the City Arborist (206) 275-7713,
- 5" course woodchips within the tree protection zone, but not against the tree trunk.

john.kenney@mercergov.org. Tree protection fence: 6' chain link fence, solidly anchored into the ground, or if authorized High-density polyethylene fencing with 3.5" x 1.5" openings; color orange. Steel posts installed at 8' o.c. 2" x 6" steel posts or approved equal TREE Maintain existing grade with the tree protection fence PROTECTION AREA unless otherwise indication on the plans

Any Work in the protected area must be with the permission of the City Arborist john.kenney@mercergov.org

Call 2 Working Days Before You Dig **Utilities Underground Location Center** (ID,MT,ND,OR,WA)




INGRESS/EGRESS AREA.

DRIVEWAYS SHALL BE PAVED TO THE EDGE OF R-O-W PRIOR TO INSTALLATION OF THE CONSTRUCTION ENTRANCE TO AVOID DAMAGING OF THE ROADWAY IT IS RECOMMENDED THAT THE ENTRANCE BE CROWNED SO THAT RUNOFF DRAINS OFF THE PAD

GRAVEL CONSTRUCTION ENTRANCE

EROSION AND SEDIMENT CONTROL NOTES:

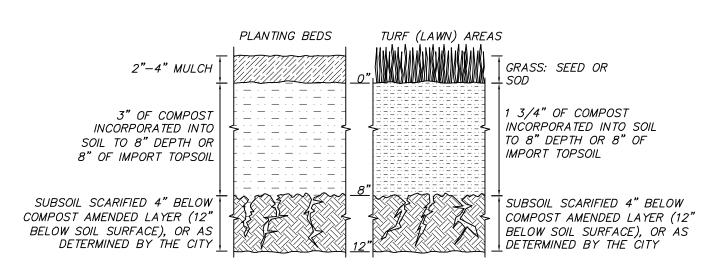- 1. APPROVAL OF THIS EROSION AND SEDIMENT CONTROL (ESC) PLAN DOES NOT CONSTITUTE AN APPROVAL OF PERMANENT ROAD OR DRAINAGE DESIGN (E.G. SIZE AND LOCATION OF ROADS, PIPES, RESTRICTORS, CHANNELS, RETENTION FACILITIES,
- 2. THE IMPLEMENTATION OF THESE ESC PLANS AND THE CONSTRUCTION, MAINTENANCE, REPLACEMENT, AND UPGRADING OF THESE ESC FACILITIES IS THE RESPONSIBILITY OF THE APPLICANT/ESC SUPERVISOR UNTIL ALL CONSTRUCTION IS APPROVED. 3. THE BOUNDARIES OF THE CLEARING LIMITS SHOWN ON THIS PLAN SHALL BE CLEARLY FLAGGED BY A CONTINUOUS LENGTH OF SURVEY TAPE (OR FENCING, IF REQUIRED) PRIOR TO CONSTRUCTION. DURING THE CONSTRUCTION PERIOD, NO DISTURBANCE BEYOND THE CLEARING LIMITS SHALL BE PERMITTED. THE CLEARING LIMITS SHALL BE MAINTAINED BY THE APPLICANT/ESC SUPERVISOR FOR THE DURATION OF CONSTRUCTION.
- 4. THE ESC FACILITIES SHOWN ON THIS PLAN MUST BE CONSTRUCTED PRIOR TO OR IN CONJUNCTION WITH ALL CLEARING AND GRADING SO AS TO ENSURE THAT THE TRANSPORT OF SEDIMENT TO SURFACE WATERS, DRAINAGE SYSTEMS, AND ADJACENT
- PROPERTIES IS MINIMIZED. 5. THE ESC FACILITIES SHOWN ON THIS PLAN ARE THE MINIMUM REQUIREMENTS FOR ANTICIPATED SITE CONDITIONS. DURING THE CONSTRUCTION PERIOD, THESE ESC FACILITIES SHALL BE UPGRADED AS NEEDED FOR UNEXPECTED STORM EVENTS AND MODIFIED TO ACCOUNT FOR CHANGING SITE CONDITIONS (E.G. ADDITIONAL SUMP PUMPS, RELOCATION OF DITCHES AND SILT
- 6. THE ESC FACILITIES SHALL BE INSPECTED DAILY BY THE APPLICANT/ESC SUPERVISOR AND MAINTAINED TO ENSURE CONTINUED PROPER FUNCTIONING. WRITTEN RECORDS SHALL BE KEPT OF WEEKLY REVIEWS OF THE TESC FACILITIES DURING
- THE WET SEASON (OCT. 1 TO APRIL 30) AND OF MONTHLY REVIEWS DURING THE DRY SEASON (MAY 1 TO SEPT. 30). 7. ANY AREAS OF EXPOSED SOILS, INCLUDING ROADWAY EMBANKMENTS, THAT WILL NOT BE DISTURBED FOR TWO DAYS DURING THE WET SEASON OR SEVEN DAYS DURING THE DRY SEASON SHALL BE IMMEDIATELY STABILIZED WITH THE APPROVED ESC METHODS (E.G., SEEDING, MULCHING, PLASTIC COVERING, ETC.).
- 8. AT NO TIME SHALL MORE THAN ONE FOOT OF SEDIMENT BE ALLOWED TO ACCUMULATE WITHIN A TRAPPED CATCH BASIN. ALL CATCH BASINS AND CONVEYANCE LINES SHALL BE CLEANED PRIOR TO PAVING. THE CLEANING OPERATION SHALL NOT FLUSH SEDIMENT LADEN WATER INTO THE DOWNSTREAM SYSTEM. STABILIZED CONSTRUCTION ENTRANCES SHALL BE INSTALLED AT THE BEGINNING OF CONSTRUCTION AND MAINTAINED FOR THE DURATION OF THE PROJECT. ADDITIONAL MEASURES MAY BE REQUIRED TO INSURE THAT ALL PAVED AREAS ARE KEPT CLEAN FOR THE DURATION OF THE PROJECT.
- 9. ALL DISTURBED AREAS SHALL BE STABILIZED USING TYPICAL TESC BMP'S. THE LIMITS OF DISTURBANCE WILL BE DELINEATED WITH HIGH VISIBILITY CONSTRUCTION FENCING. DURING CONSTRUCTION SILT FENCES WILL BE PLACED DOWN SLOPE OF DISTURBED AREAS ALONG WITH STRAW MATTING, NETS, OR PLASTIC COVERING OVER EXPOSED SOIL OR STOCKPILES. TREES TO BE RETAINED WILL BE PROTECTED WITH HIGH VISIBILITY CONSTRUCTION FENCING.
- 10. ALL SOIL STOCKPILES TO BE COVERED WITH PLASTIC SHEETING UNTIL SUCH TIME THAT THE SOIL IS EITHER USED OR REMOVED. PILES SHOULD BE SITUATED AND LOCATED SUCH THAT SEDIMENT DOES NOT RUN INTO THE STREET OR ONTO
- 11. ALL EXPOSED SOIL AREAS SHALL BE COVERED OR PROTECTED USING AN APPROPRIATE BMP. STABILIZE DENUDED AREAS OF
- THE SITE BY MULCHING, SEEDING, PLANTING, OR SODDING. 12. ALL ADJACENT PROPERTIES SHALL BE PROTECTED FROM SEDIMENT DEPOSITION BY APPROPRIATE USE OF VEGETATION BUFFER STRIPS, SEDIMENT BARRIERS, OR FILTERS, DIKES, MULCHING, OR BY A COMBINATION OF THESE MEASURES AND OTHER
- 13. PROVIDE FOR PERIODIC STREET CLEANING TO REMOVE ANY SEDIMENT THAT MAY HAVE BEEN TRACKED OFF-SITE. SEDIMENT SHOULD BE REMOVED BY SHOVELING OR SWEEPING AND CAREFULLY REMOVED TO A SUITABLE DISPOSAL AREA WHERE IT WILL
- 14. ALL INSTALLED EROSION AND SEDIMENT CONTROL BMP'S SHALL BE INSPECTED REGULARLY BY THE GENERAL CONTRACTOR ESPECIALLY AFTER ANY LARGE STORM. MAINTENANCE, INCLUDING REMOVAL AND PROPER DISPOSAL OF SEDIMENT SHOULD BE A NECESSARY TO INSURE THAT SEDIMENT AND EROSION IS CONTROLLED ON SITE.



SOIL AMENDMENT

SOIL AMENDMENT NOTES

*SOIL RETENTION: RETAIN, IN AN UNDISTURBED STATE, THE DUFF LAYER AND NATIVE TOPSOIL TO THE MAXIMUM EXTENT PRACTICABLE. IN ANY AREAS REQUIRING GRADING REMOVE AND STOCKPILE THE DUFF LAYER AND TOPSOIL ON SITE IN A DESIGNATED, CONTROLLED AREA. NOT ADJACENT TO PUBLIC RESOURCES AND CRITICAL AREAS, TO BE REAPPLIED TO OTHER PORTIONS OF THE SITE WHERE FEASIBLE.

*SOIL QUALITY: ALL AREAS SUBJECT TO CLEARING AND GRADING THAT HAVE NOT BEEN COVERED BY IMPERVIOUS SURFACE, INCORPORATED INTO A DRAINAGE FACILITY OR ENGINEERED AS STRUCTURAL FILL OR SLOPE SHALL, AT PROJECT COMPLETION, DEMONSTRATE THE FOLLOWING:

- 1. A TOPSOIL LAYER WITH A MINIMUM ORGANIC MATTER CONTENT OF 10% DRY WEIGHT IN PLANTING BEDS, AND 5% ORGANIC MATTER CONTENT IN TURF AREAS, AND A PH FROM 6.0 TO 8.0 OR MATCHING THE PH OF THE UNDISTURBED SOIL. THE TOPSOIL LAYER SHALL HAVE A MINIMUM DEPTH OF EIGHT INCHES EXCEPT WHERE TREE ROOTS LIMIT THE DEPTH OF INCORPORATION OF AMENDMENTS NEEDED TO MEET THE CRITERIA. SUBSOILS BELOW THE TOPSOIL LAYER SHOULD BE SCARIFIED AT LEAST 4 INCHES WITH SOME INCORPORATION OF THE UPPER MATERIAL TO AVOID STRATIFIED LAYERS, WHERE FEASIBLE. 2. MULCH PLANTING BEDS WITH 2-4 INCHES OF ORGANIC MATERIAL
- 3. USE COMPOST AND OTHER MATERIALS THAT MEET THESE ORGANIC CONTENT REQUIREMENTS: A. THE ORGANIC CONTENT FOR "PRE-APPROVED" AMENDMENT RATES CAN BE MET ONLY USING COMPOST MEETING THE COMPOST SPECIFICATION FOR BIORETENTION (BMP T7.30), WITH THE EXCEPTION THAT THE COMPOST MAY HAVE UP TO 35% BIOSOLIDS OR MANURE. THE COMPOST MUST ALSO HAVE AN ORGANIC MATTER CONTENT OF 40% TO 65%, AND A CARBON TO NITROGEN RATIO

BELOW 25:1. THE CARBON TO NITROGEN RATIO MAY BE AS HIGH AS 35:1 FOR PLANTINGS COMPOSED ENTIRELY OF PLANTS

NATIVE TO THE PUGET SOUND LOWLANDS REGION. B. CALCULATED AMENDMENT RATES MAY BE MET THROUGH USE OF COMPOSTED MATERIAL MEETING (A.) ABOVE; OR OTHER ORGANIC MATERIALS AMENDED TO MEET THE CARBON TO NITROGEN RATIO REQUIREMENTS, AND NOT EXCEEDING THE CONTAMINANT LIMITS IDENTIFIED IN TABLE 220-B, TESTING PARAMETERS, IN WAC 173-350-220. THE RESULTING SOIL SHOULD BE CONDUCIVE TO THE TYPE OF VEGETATION TO BE ESTABLISHED.

•IMPLEMENTATION OPTIONS: THE SOIL QUALITY DESIGN GUIDELINES LISTED ABOVE CAN BE MET BY USING ONE OF THE METHODS LISTED

- 1. LEAVE UNDISTURBED NATIVE VEGETATION AND SOIL, AND PROTECT FROM COMPACTION DURING CONSTRUCTION. 2. AMEND EXISTING SITE TOPSOIL OR SUBSOIL EITHER AT DEFAULT "PRE-APPROVED" RATES, OR AT CUSTOM CALCULATED RATES
- BASED ON TESTS OF THE SOIL AND AMENDMENT. 3. STOCKPILE EXISTING TOPSOIL DURING GRADING, AND REPLACE IT PRIOR TO PLANTING. STOCKPILED TOPSOIL MUST ALSO BE AMENDED IF NEEDED TO MEET THE ORGANIC MATTER OR DEPTH REQUIREMENTS, EITHER AT A DEFAULT "PRE-APPROVED" RATE OR AT A CUSTOM CALCULATED RATE. 4. IMPORT TOPSOIL MIX OF SUFFICIENT ORGANIC CONTENT AND DEPTH TO MEET THE REQUIREMENTS.

MORE THAN ONE METHOD MAY BE USED ON DIFFERENT PORTIONS OF THE SAME SITE. SOIL THAT ALREADY MEETS THE DEPTH AND ORGANIC MATTER QUALITY STANDARDS, AND IS NOT COMPACTED, DOES NOT NEED TO BE AMENDED.

*ESTABLISH SOIL QUALITY AND DEPTH TOWARD THE END OF CONSTRUCTION AND ONCE ESTABLISHED. PROTECT FROM COMPACTION. SUCH AS FROM LARGE MACHINERY USE. AND FROM EROSION. PLANT VEGETATION AND MULCH THE AMENDED SOIL AREA AFTER INSTALLATION.

•LEAVE PLANT DEBRIS OR ITS EQUIVALENT ON THE SOIL SURFACE TO REPLENISH ORGANIC MATTER. *REDUCE AND ADJUST, WHERE POSSIBLE, THE USE OF IRRIGATION, FERTILIZERS, HERBICIDES AND PESTICIDES, RATHER THAN CONTINUING

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D.R. STRONG **CONSULTING ENGINEERS** ENGINEERS PLANNERS SURVEYORS 620 - 7th AVENUE KIRKLAND, WA 98033


O 425.827.3063 F 425.827.2423

VANN LANZ L BUILDS, LL



DRAFTED BY: RMF DESIGNED BY: RMF PROJECT ENGINEER: MAJ DATE: **9.26.23** PROJECT NO.: 23001


DRAWING: C2 SHEET: **2** OF **5**

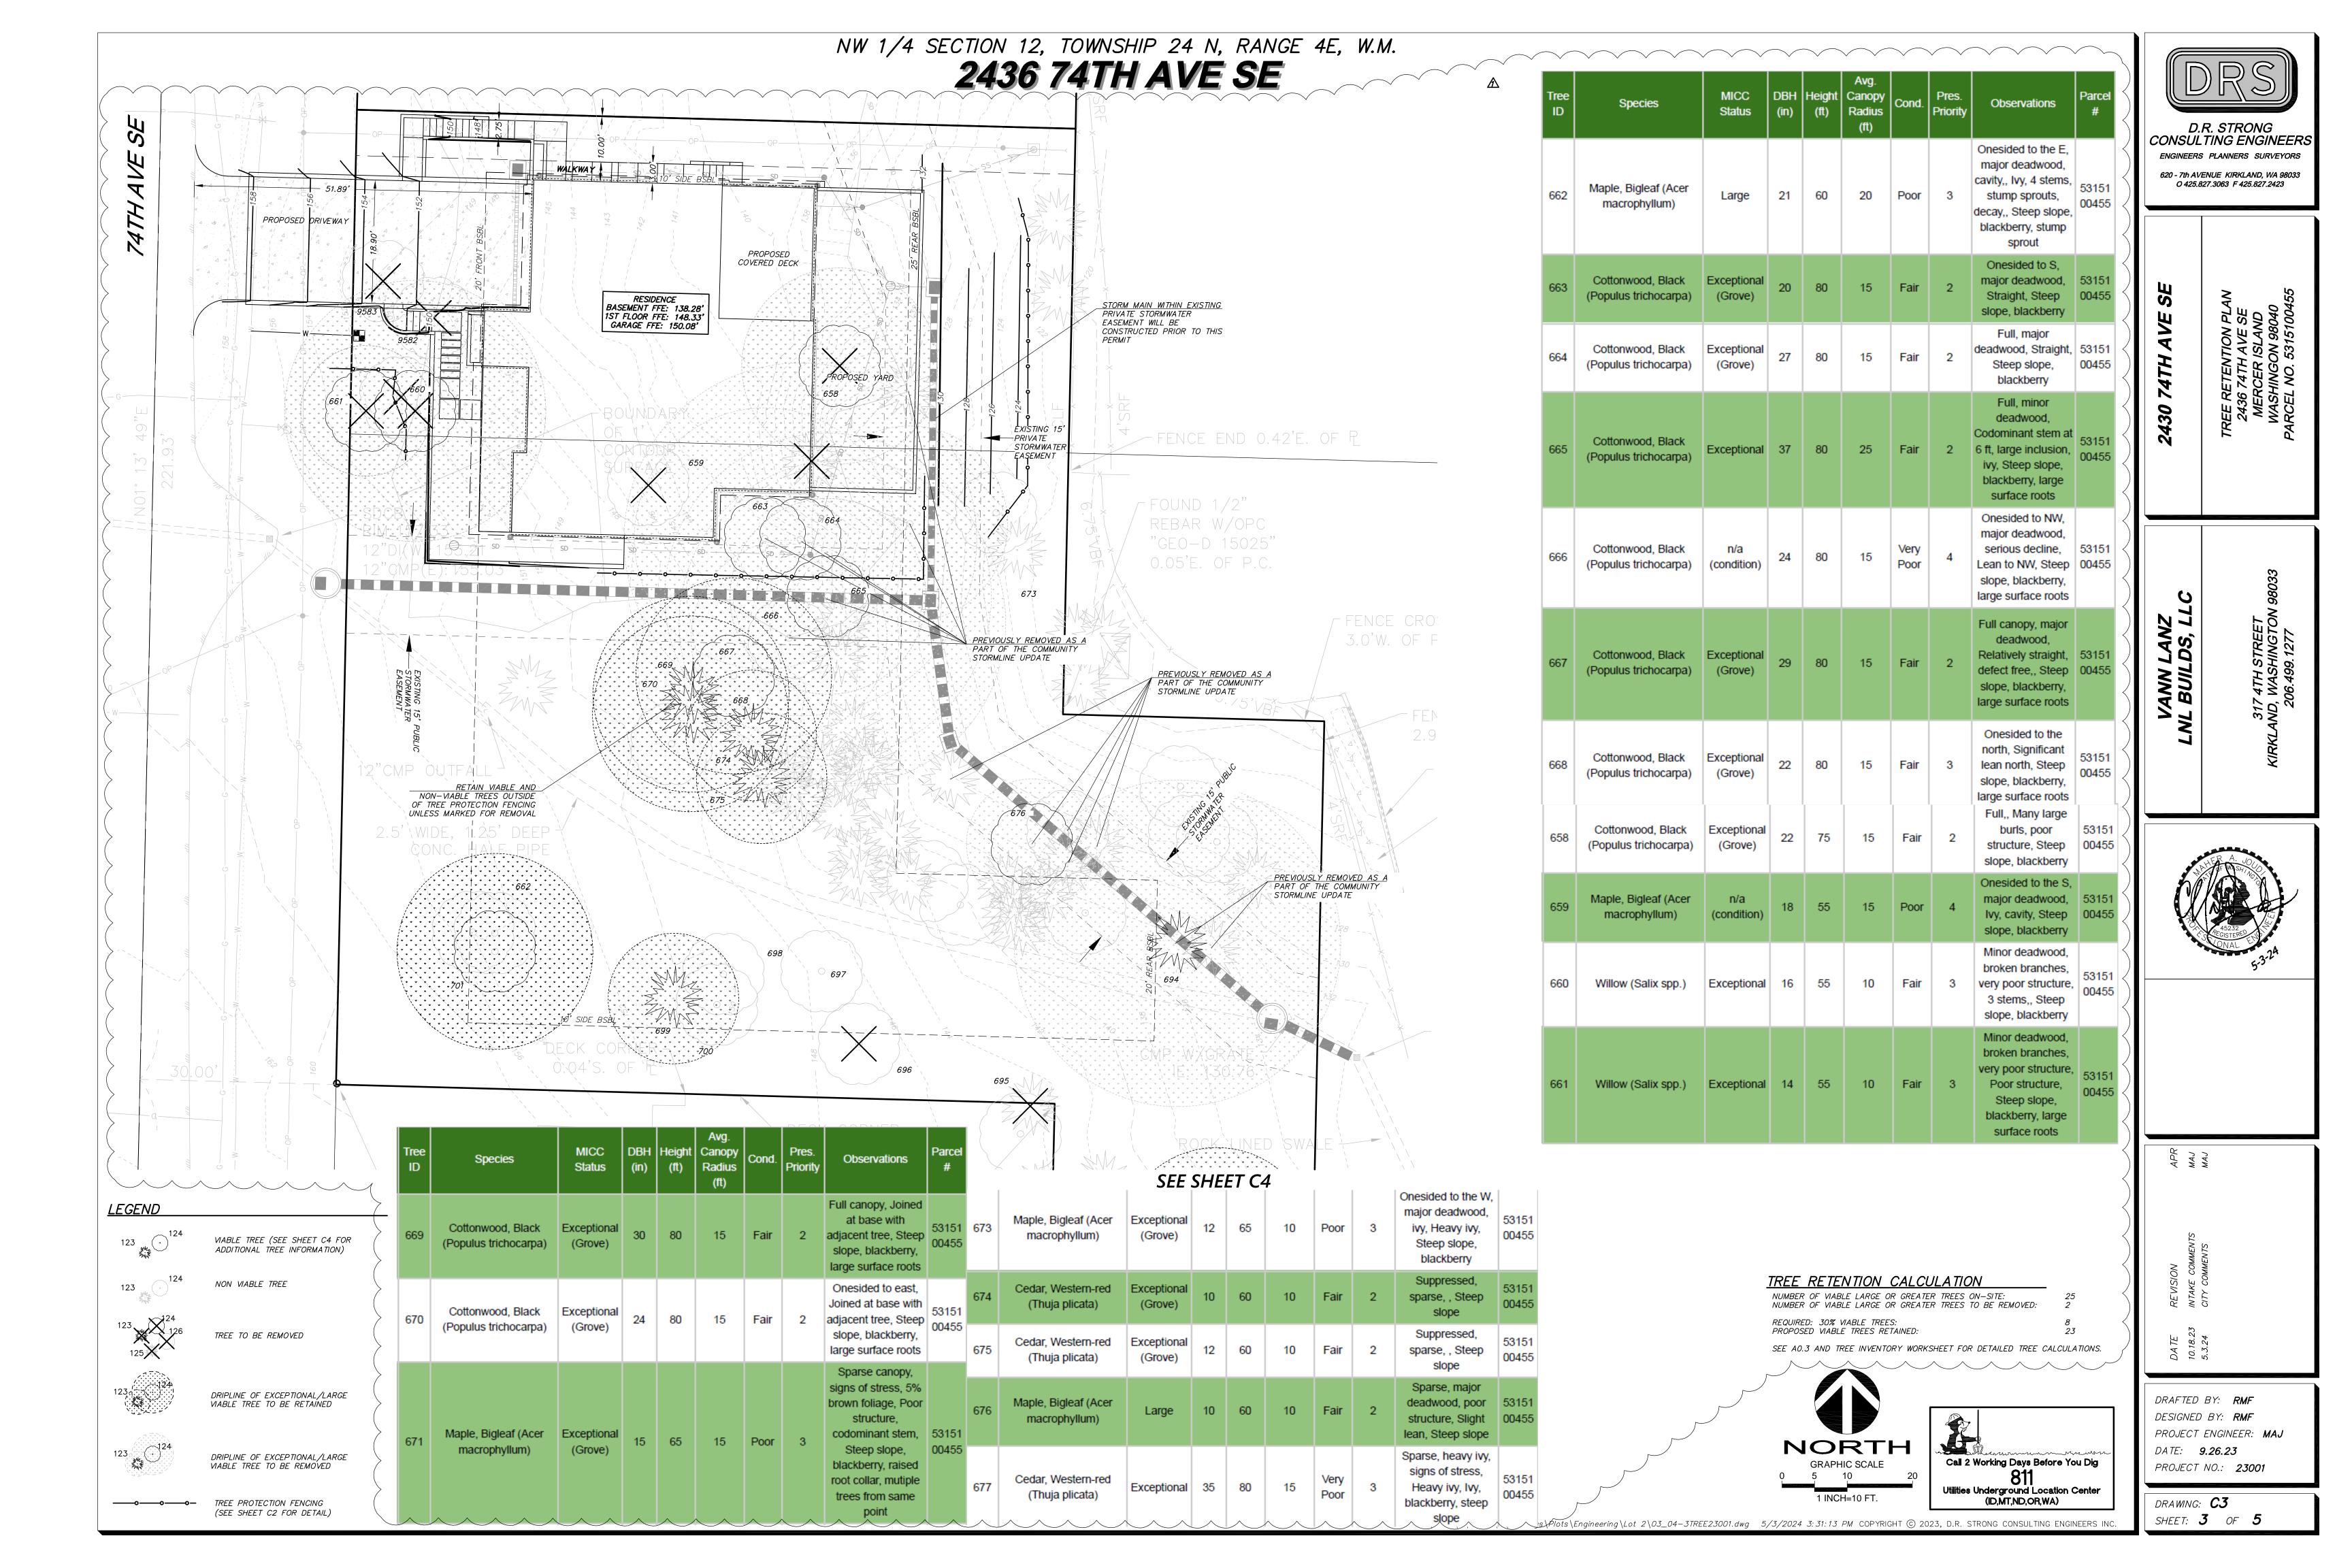

Tree ID	Species	MICC Status	DBH (in)	Height (ft)	Avg. Canopy Radius (ft)	Cond.	Pres. Priority	Observations	Parce #
680	Maple, Bigleaf (Acer macrophyllum)	n/a (condition)	14	60	10	Very Poor	4	Onesided N, minor deadwood, Codominant stem, inclusion, lean to west, Ivy, blackberry, steep slope	53151 00455
681	Alder, Red (Alnus rubra)	n/a (condition)	10	60	5	Very Poor	4	Ivy, serious decline, Heavy ivy, cavity, seam, Ivy, blackberry, steep slope	53151 00455
682	Alder, Red (Alnus rubra)	n/a (condition)	14	40	5	Very Poor	4	Ivy, serious decline, Heavy ivy,, Ivy, blackberry, steep slope	53151 00455
683	Alder, Red (Alnus rubra)	Large	12	60	10	Fair	3	Ivy, signs of stress, Heavy ivy, poor structure, Ivy, blackberry, steep slope	53151 00455
684	Cedar, Western-red (Thuja plicata)	Large	25	70	15	Fair	2	Sparse,, Codominant stem,,	53151 00455
685	Cedar, Western-red (Thuja plicata)	Large	12	70	15	Fair	2	Sparse,,,	53151 00455
686	Cedar, Western-red (Thuja plicata)	Large	20	70	20	Fair	2	Sparse,, Codominant stem, poor structure, wishbone union at base,	53151 00455
687	Cherry (Prunus spp.)	n/a (condition)	11	25	5	Very Poor	4	Sparse, deadwood, Codominant stem, poor structure, flaking bark,	53151 00455
688	Willow (Salix spp.)	Exceptional	12	50	10	Poor	3	Sparse, deadwood, onesided to the north., Twisted, leaning to the north,	53151 00455
689	Alder, Red (Alnus rubra)	n/a (condition)	18	65	10	Dying	4	Sparse, deadwood, Flaking bark, decay,	
690	Willow (Salix spp.)	n/a (condition)	19	65	10	Dying	4	50% dead branches, Decay, cavity,	53151 00455
691	Maple, Bigleaf (Acer macrophyllum)	Large	13	65	15	Fair	2	Deadwood, onesided to the east, Slight lean to the east, Blackberry, ivy, horsetail	53151 00455
692	Cedar, Western-red (Thuja plicata)	n/a (condition)	15	65	5	Dead	4	.,	53151 00455
693	Maple, Bigleaf (Acer macrophyllum)	Large	12	65	15	Fair	2	Full crown, , Blackberry, ivy, horsetail	53151 00455
694	Cottonwood, Black (Populus trichocarpa)	Large	33	100	25	Fair	3	Full crown, large hanging deadwood, Large tree with multiple large limb failures, may not be practical to preserve, any construction impacts would flag for removal. Targets under canopy., , Blackberry, ivy, horsetail	53151 00455
695	Maple, Bigleaf (Acer macrophyllum)	n/a (condition)	37	25	5	Dead	4	, Multistem, snag,	53151 00455
696	Maple, Bigleaf (Acer	n/a	22	25	5	Dead	4	, Msnag,	53151 00455

NW 1/4 SECTION 12, TOWNSHIP 24 N, RANGE 4E, W.M.

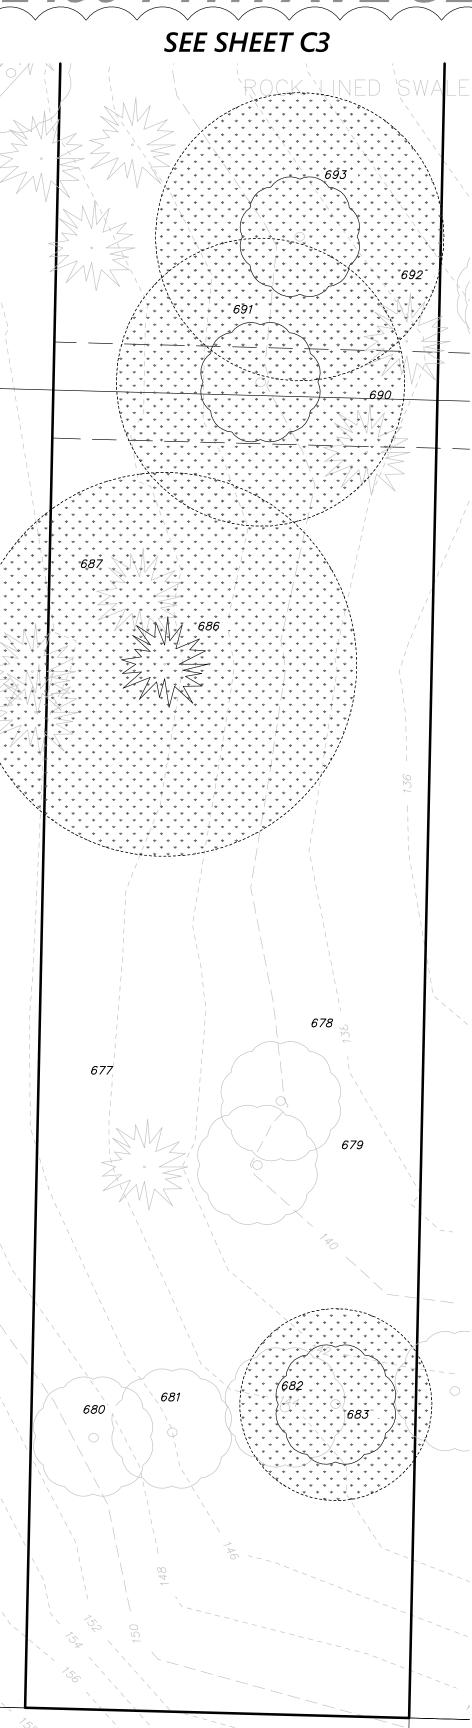2436 74TH AVE SE



<u>LEGEND</u>

123

VIABLE TREE (SEE SHEET C3 FOR ADDITIONAL TREE

INFORMATION)

NON VIABLE TREE

TREE TO BE REMOVED

Tree ID	Species	MICC Status	DBH (in)	Height (ft)	Canopy Radius (ft)	Cond.	Pres. Priority	Observations	Parcel #
697	Maple, Bigleaf (Acer macrophyllum)	n/a (condition)	22	75	15	Poor	4	6 large stubs from broken branches, recently exposed to north wind, Lean to the south, ivy, Saturated soil, blackberry, ivy	53151 00455
698	Maple, Bigleaf (Acer macrophyllum)	n/a (condition)	20	75	15	Poor	4	Large deadwood, onesided south,, Lean to the south, ivy, large basal cavity, multistem at base, Saturated soil, blackberry, ivy	53151 00455
699	Cedar, Western-red (Thuja plicata)	Large	13	35	10	Good	2	Full canopy, Interesting structure, swooping, Saturated soil, blackberry, ivy	53151 00455
700	Cottonwood, Black (Populus trichocarpa)	n/a (condition)	21	75	10	Poor	4	Large deadwood, 5 large broken stubs, lvy, Saturated soil, blackberry, ivy	53151 00455
701	Cedar, Western-red (Thuja plicata)	Large	24	50	15	Good	2	Suppressed, , Steep slope, blackberry, stump sprout	53151 00455
9582	Hawthorn, Black (Crataegus douglasii)	n/a (condition)	8	30	10	Poor	4		53151 00455
9583	Willow (Salix spp.)	Exceptional	8	25	10	Fair	3		53151 00455
678	Cottonwood, Black (Populus trichocarpa)	n/a (condition)	18	60	10	Very Poor	4	Sparse, heavy ivy, signs of stress, hanging deadwood, Heavy ivy, Ivy, blackberry, steep slope	53151 00455
679	Alder, Red (Alnus rubra)	n/a (condition)	14	60	10	Very Poor	4	Sparse, heavy ivy, signs of stress, hanging deadwood, Heavy ivy, Ivy, blackberry, steep slope	53151 00455

NORTH 1 INCH=10 FT.

DRIPLINE OF EXCEPTIONAL/LARGE VIABLE TREE TO BE RETAINED

DRIPLINE OF EXCEPTIONAL/LARGE VIABLE TREE TO BE REMOVED

TREE PROTECTION FENCING
(SEE SHEET C2 FOR DETAIL)

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REQUIRED: 30% VIABLE TREES: PROPOSED VIABLE TREES RETAINED:

SEE AO.3 AND TREE INVENTORY WORKSHEET FOR DETAILED TREE CALCULATIONS.



DRAFTED BY: RMF DESIGNED BY: RMF PROJECT ENGINEER: **MAJ** DATE: **9.26.23** PROJECT NO.: **23001**

D.R. STRONG CONSULTING ENGINEERS

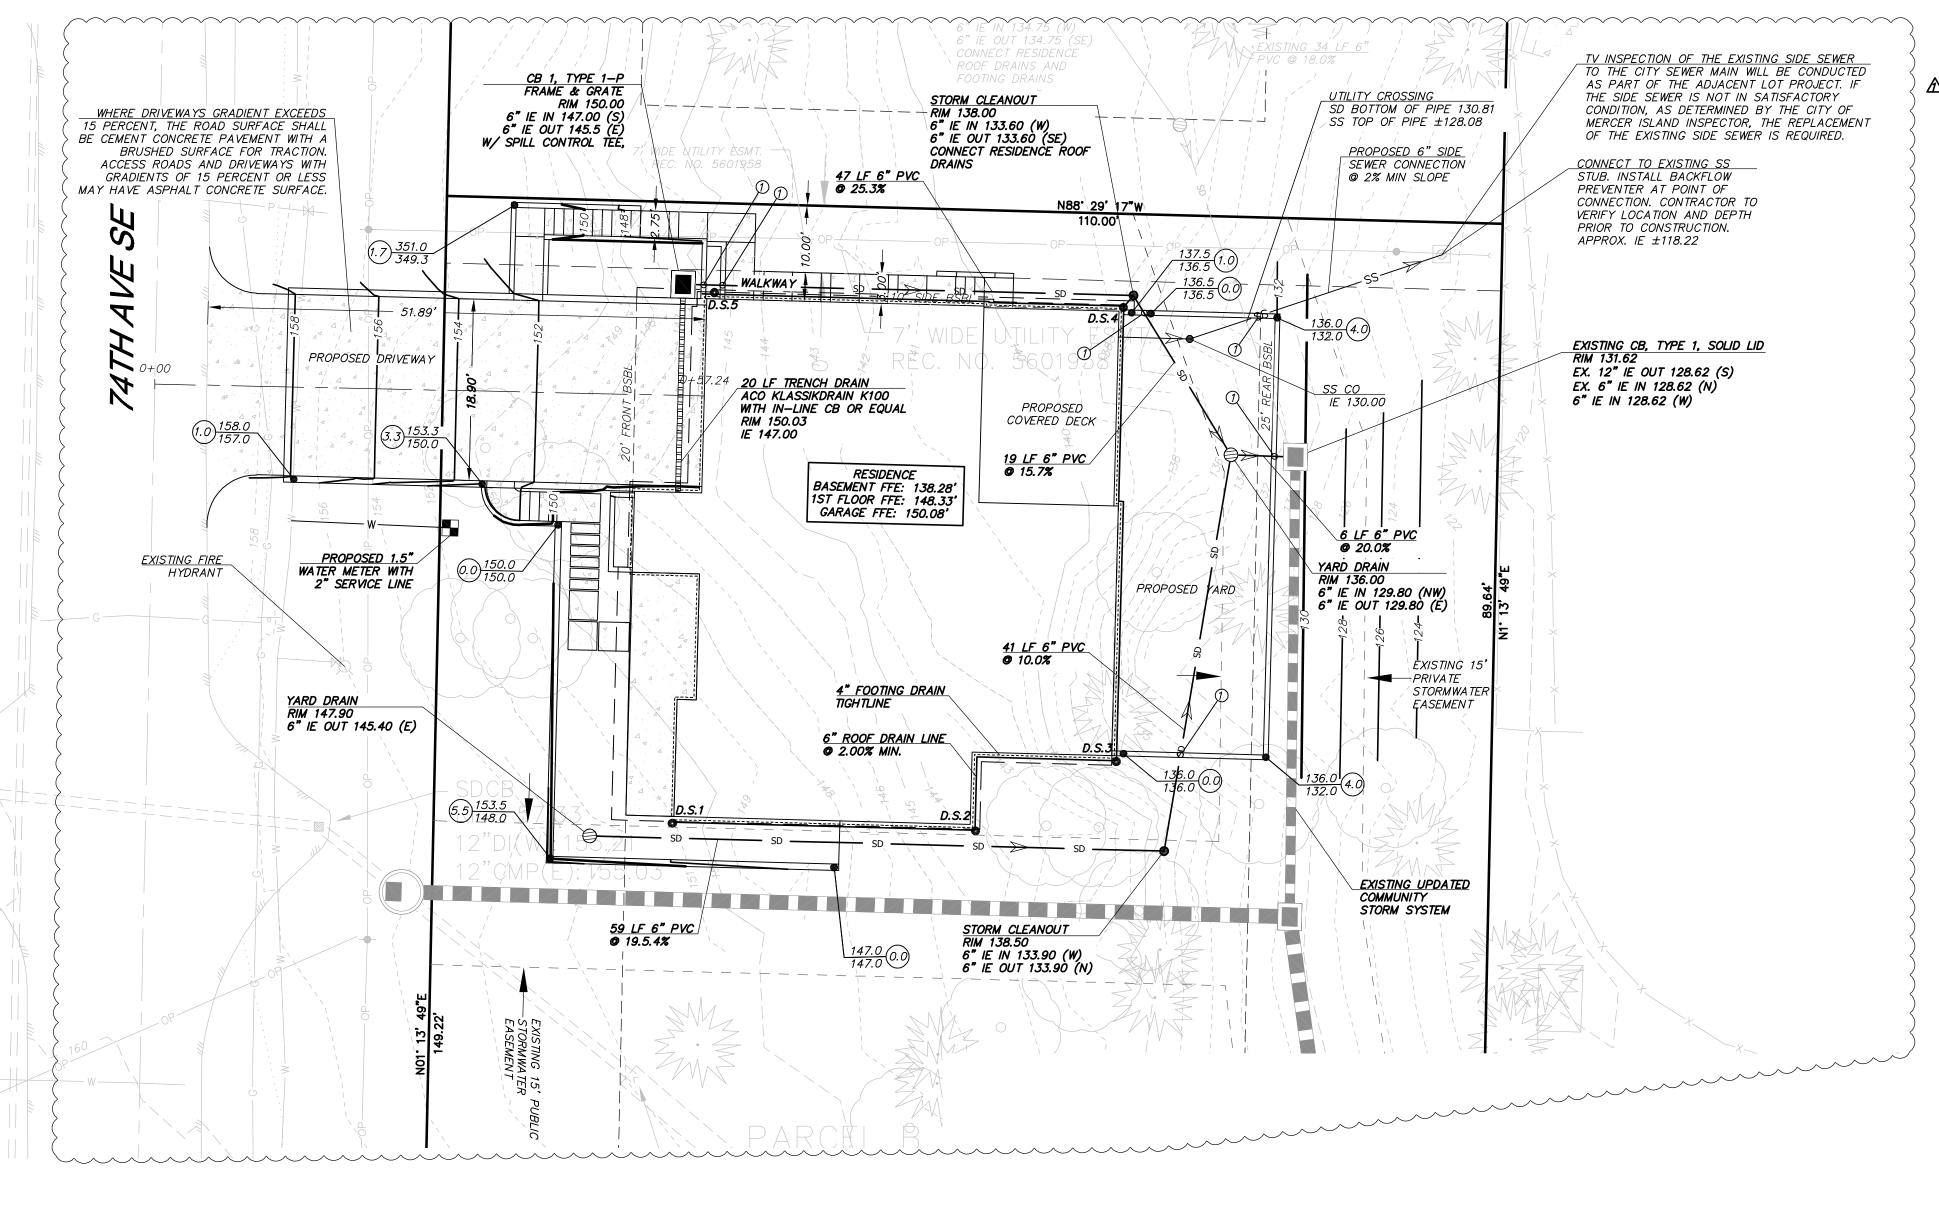
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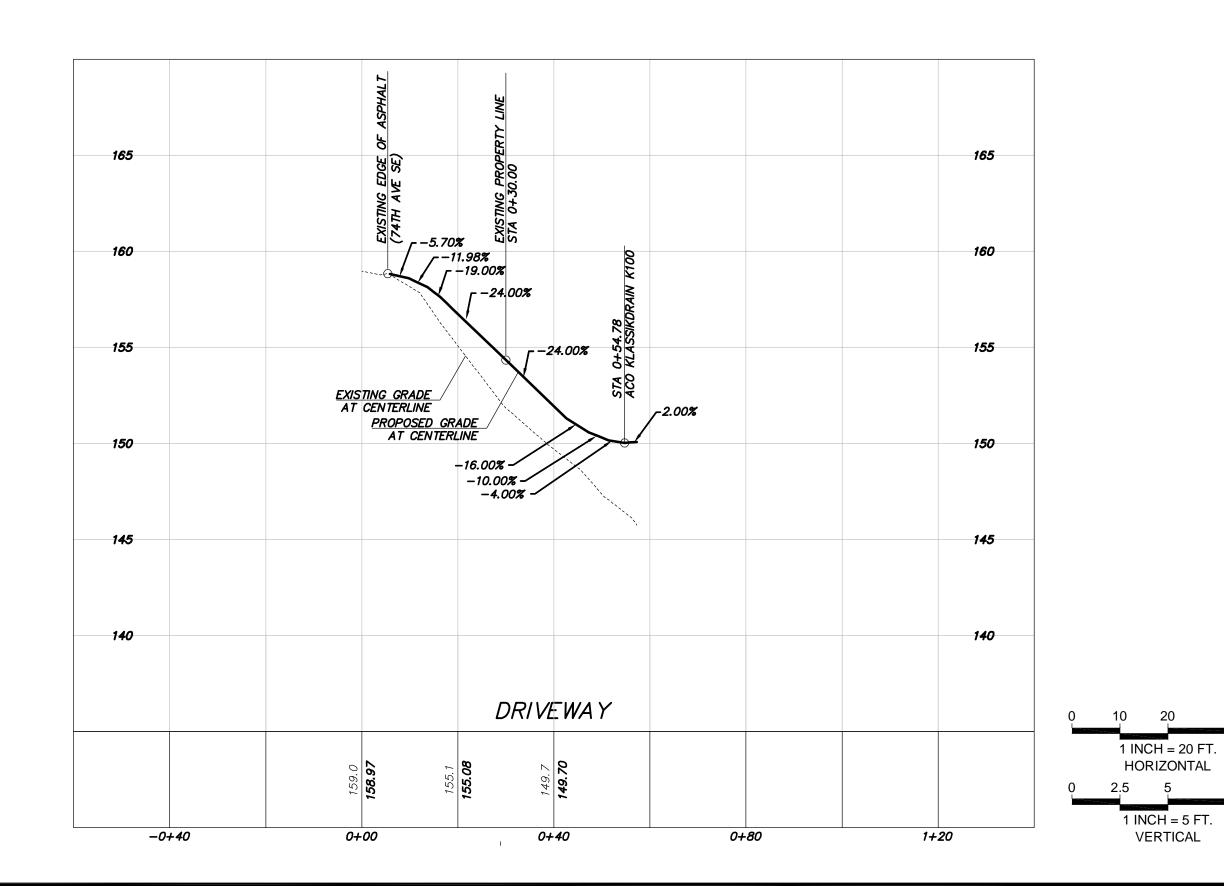
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TREE RETENTION CALCULATION

NUMBER OF VIABLE LARGE OR GREATER TREES ON—SITE:
NUMBER OF VIABLE LARGE OR GREATER TREES TO BE REMOVED:







FIRE SPRINKLER NOTE:

NFPA 13R FIRE SPRINKLER SYSTEM IN COMPLIANCE WITH NFPA 13R AND COMI STANDARDS SHALL BE INSTALLED THROUGHOUT THE RESIDENCE. A SEPARATE FIRE PERMIT IS REQUIRED.

FIRE ALARM NOTE:

A NFPA 72- CHAPTER 29 MONITORED FIRE ALARM SYSTEM IN COMPLIANCE WITH NFPA 72 AND COMI STANDARDS SHALL BE INSTALLED THROUGHOUT THE RESIDENCE. A SEPARATE FIRE PERMIT IS REQUIRED.

LAWN AND LANDSCAPE AREA NOTE:

THE LAWN AND LANDSCAPE AREAS ARE REQUIRED TO PROVIDE POST-CONSTRUCTION SOIL QUALITY AND DEPTH IN ACCORDANCE WITH BMP T5.13. THE PROJECT CIVIL ENGINEER MUST PROVIDE A LETTER OF CERTIFICATION TO ENSURE THAT THE LAWN AND LANDSCAPE AREAS ARE MEETING THE POST-CONSTRUCTION SOIL QUALITY AND DEPTH REQUIREMENTS SPECIFIED ON THE APPROVED PLAN SET PRIOR TO FINAL INSPECTION OF THE PROJECT.

AREA BREAKDOWN: ADDRESS: 2436 74TH AVE SE

LOT SIZE: 25,799 S.F. (0.592 AC.) EX. HARD SURFACES ON LOT: 0 S.F.

<u>NEW HARD SURFACES ON LOT:</u> MAIN HOUSE ROOF: 520 S.F. WALKS & PATIOS 3,409 S.F. (13.2%) TOTAL NEW ON LOT:

NEW HARD SURFACES: 3,409 S.F. 22,392 S.F. LOT PERVIOUS:

OFFSITE DRIVEWAY: 478 S.F. TOTAL PROJECT HARD SURFACES: 3,885 S.F. TOTAL P.G.I.S.: 998 S.F.

DOWNSPOU	T ELEVATIONS
DOWNSPOUT #	INVERT ELEV.
1	145.00
2	140.84
3	135.53
4	135.04
5	1 <i>42.55</i>

UTILITY LEGEND:

SD	PROPOSED STORM LINE
C	PROPOSED COMMUNICATION L
W	PROPOSED WATER LINE
P	PROPOSED POWER LINE

GENERAL NOTES:

1. SITE PLAN PROVIDED BY CLIENT ON APRIL 10, 2023.

- 2. WALL/ FOOTING/ LAWN UNDERDRAIN DRAINAGE SYSTEM AND ROOF DOWNSPOUT SYSTEM SHALL NOT BE INTERCONNECTED UNLESS SUCH CONNECTION IS MADE AT LEAST ONE FOOT BELOW THE WALL/FOOTING/ UNDERDRAIN DRAINAGE SYSTEM AND DOWN SLOPE OF THE WALL/BUILDING FOUNDATION AND DOWNSTREAM OF THE DETENTION TANK.
- 3. EXISTING UTILITY LOCATIONS SHOWN HEREON ARE APPROXIMATE ONLY. IT SHALL BE THE CONTRACTOR'S RESPONSIBILITY TO DETERMINE THE EXACT VERTICAL AND HORIZONTAL LOCATION OF ALL EXISTING UNDERGROUND UTILITIES PRIOR TO COMMENCING CONSTRUCTION. NO REPRESENTATION IS MADE THAT ALL EXISTING UTILITIES ARE SHOWN HEREON. THE ENGINEER ASSUMES NO RESPONSIBILITY FOR UTILITIES SHOWN, OR NOT SHOWN IN THEIR PROPER
- CONTRACTOR SHALL POT-HOLF LOCATION OF FXISTING UTILITIES TO BE RECONNECTED PRIOR TO BEGINNING CONSTRUCTION. NOTIFY ENGINEER OF ANY
- 5. CONTRACTOR TO VERIFY CONDITION AND GOOD WORKING ORDER OF ALL EXISTING UTILITIES TO BE RECONNECTED OR RE-USED PRIOR TO START OF
- 6. SOILS ON THE SITE CONSISTS OF KITSAP SILT LOAM (KpB) PER THE NRCS WEB
- 7. ROOF DRAINS SHALL BE 4" OR 6" PVC AS SHOWN AND HAVE A MINIMUM SLOPE OF 2.00%.
- 8. ALWAYS CALL 811 TWO WORKING DAYS BEFORE YOU DIG.

STORM DRAINAGE NOTES:

- 1. 6" & 8" PVC PIPE SHALL MEET ASTM D3034 SDR-35 2. FOOTING/ WALL DRAINAGE SYSTEM AND ROOF DOWNSPOUT SYSTEM SHALL NOT BE INTERCONNECTED UNLESS SUCH CONNECTION IS MADE AT LEAST ONE FOOT BELOW THE FOOTING/ WALL DRAINAGE SYSTEM AND DOWN SLOPE OF THE BUILDING FOUNDATION. PROVIDE BACKWATER VLAVES WHERE NOTED.
- APPLICANTS ARE REQUIRED TO CALL FOR INSPECTIONS. IF THE WORK DOES NOT CONFORM TO THE APPROVED PLANS, OR THE INSPECTION REVEALS OTHER CONDITIONS THAT REQUIRE MODIFICATIONS OR ADDITIONAL INFORMATION, THAT PORTION OF THE WORK WILL BE STOPPED. NO FINAL OCCUPANCY SHALL BE PERMITTED UNTIL ALL ON-SITE STORMWATER MANAGEMENT BMPS AND OTHER DRAINAGE CONTROL FACILITIES ARE COMPLETED, INSPECTED AND APPROVED.
- 4. APPLICANTS MAY BE REQUIRED TO OBTAIN A STREET OPENING PERMIT IF DRAINAGE WORK IS TO BE DONE IN THE CITY'S RIGHT-OF-WAY. IF THE IMPROVEMENTS INCLUDE A CONCRETE DRIVEWAY THAT IS TO EXTEND INTO THE PUBLIC RIGHT-OF-WAY, A PUBLIC PLACE USE PERMIT IS REQUIRED FOR THAT PORTION OF THE DRIVEWAY LOCATED WITHIN THE PUBLIC RIGHT-OF-WAY. 5. FIELD ADJUST AREA DRAIN LOCATIONS. GRADE TO DRAIN.
- 6. SLEEVE ALL PIPES UNDER/ THROUGH WALLS.

SURVEY CONTOUR NOTE:

SEE NOTE ON BOUNDARY AND TOPOGRAPHIC SURVEY. ADDITIONAL SURVEY POINTS WERE TAKEN TO ENSURE THE AVERAGE CONTOUR ELEVATION WITHIN THE VICINITY OF THE BUILDING FOOTPRINT IS ACCURATE WITHIN 6 INCHES VERTICALLY AND HORIZONTALLY FROM ACTUAL ELEVATIONS.


DETENTION NOTE:

THIS PROJECT PROPOSES A FEE IN LIEU OF DETENTION. SEE DRAINAGE REPORT FOR DETAILED ANALYSIS.

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PIPE SLEEVE NOTE:

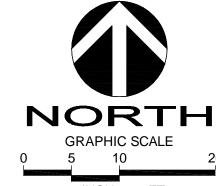① SLEEVE ALL PIPES UNDER/ THROUGH WALLS.








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ENGINEERS PLANNERS SURVEYORS

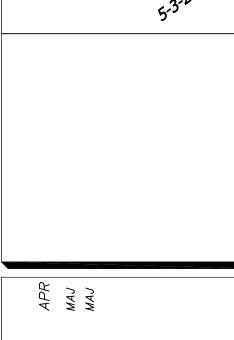VANN LANZ NL BUILDS, LLO



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